


# 3401 OLYMPUS BLVD. SUITE #450 DALLAS, TX 75019

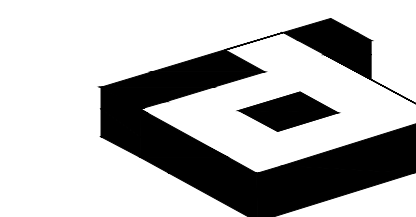

**idGROUP**

2641 IRVING BLVD.  
DALLAS, TEXAS 75207  
TEL: 214-638-6800 FAX: 214-689-0301



PROJECT NO.: 580-004  
DRAWN BY: RH  
CHECKED BY: MW  
TENANT R.S.F.: 9.452

**BILLINGSLEY**  
COMPANY

3401 OLYMPUS  
ARTISAN DESIGN GROUP

3401 OLYMPUS BLVD.  
SUITE #450  
DALLAS, TX 75019

NO.	ISSUED FOR:	DATE:
1	REVISION 1	04/17/20

LANDLORD/CLIENT REVIEW ISSUE DATE: 03/30/20  
 BID ISSUE DATE: 03/30/20  
 CONSTRUCTION ISSUE DATE: 03/30/20

DRAWING TITLE:  
**COVER SHEET  
& INDEX**


DRAWING NUMBER:

# GO.0

## SYMBOL LEGEND

ROOM NAME	ROOM MARK	SYMBOL	ALIGN TO
000			MULLION CENTERLINE
01	DOOR MARK		GRID LINE REFERENCE
01	WINDOW MARK		REVISION REFERENCE
	KEYNOTE REFERENCE		ALIGN FACE FINISH
XXX.X	ELEVATION REFERENCE		DIMENSION TO INSIDE FACE
XXX.X	SECTION REFERENCE		MATCH LINE
4-2-2	ELEVATION REFERENCE		DATUM OR FLOOR ELEVATION
FC	FIRE EXTINGUISHER CABINET, U.N.O.		ENLARGED PLAN DETAIL REFERENCE
X.X	CLEAR DIMENSION TO BE MAINTAINED		BUILDING SECTION REFERENCE

## VICINITY MAP

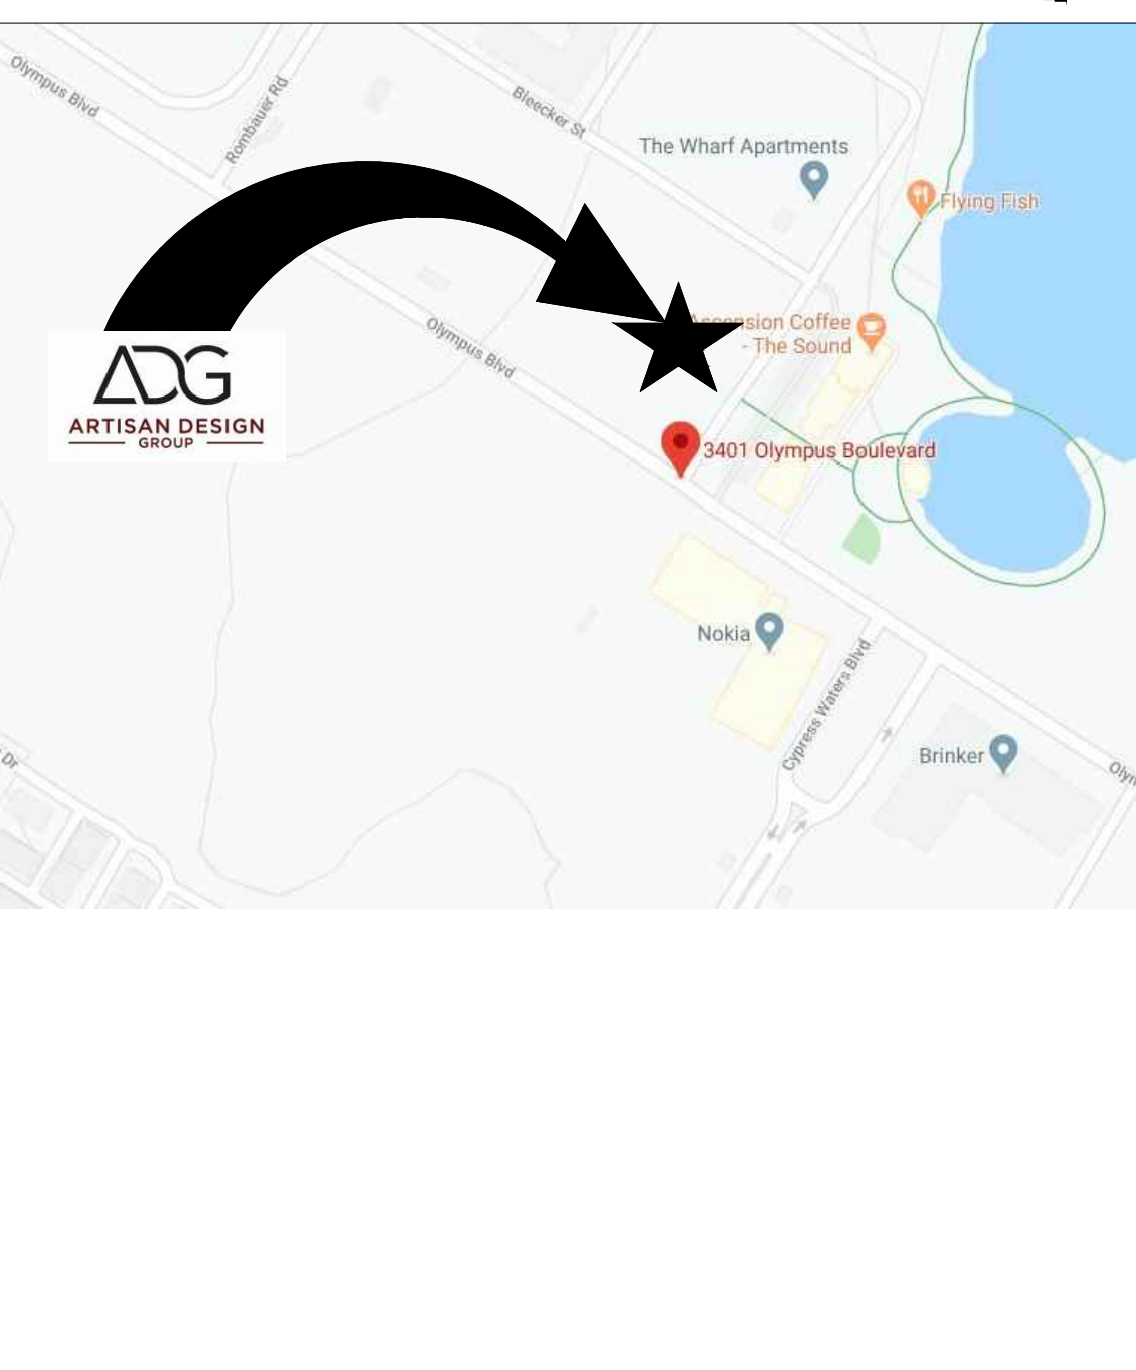

## PROJECT SUMMARY

**PROJECT DESCRIPTION**  
 THE SCOPE OF THIS PROJECT IS A NON-STRUCTURAL INTERIOR FINISH-OUT IN AN EXISTING SINGLE FLOOR SUITE FOR THE ABOVE NAMED TENANT. SCOPE INCLUDES HVAC, ELECTRICAL, PLUMBING.

**APPLICABLE BUILDING CODES**

JURISDICTION	CITY OF DALLAS
BUILDING	2015 INTERNATIONAL BUILDING CODE
FIRE	2015 INTERNATIONAL FIRE CODE
PLUMBING	2015 INTERNATIONAL PLUMBING CODE
MECHANICAL	2015 INTERNATIONAL MECHANICAL CODE
ELECTRICAL	2017 NATIONAL ELECTRICAL CODE
ACCESSIBILITY	TEXAS ACCESSIBILITY STANDARDS
ENERGY	2015 INTERNATIONAL ENERGY CONSERVATION CODE
FUEL/GAS	2015 INTERNATIONAL FUEL GAS CODE
OTHER	2015 GREEN CONSTRUCTION CODE WITH DALLAS AMENDMENTS

**PROJECT DATA**

STORIES:	5
SPRINKLER SYSTEM:	YES
OCCUPANCY GROUP:	B
USABLE SQ. FOOTAGE:	8,373
	CONFERENCE AREA: 1,050/15 = 70 OCC.
	OFFICE AREA: 7,323/100 = 74 OCC.
OCCUPANT LOAD:	144
NUMBER OF EXITS REQUIRED:	2 REQUIRED / 2 PROVIDED
LONGEST DIAGONAL:	163'-5"
EXIT SEPARATION:	54'-6" MINIMUM REQUIRED / 85'-4" PROVIDED
DEAD END CORRIDOR:	50' MAX / 0' PROVIDED
COMMON PATH OF TRAVEL:	100' MAX / 90'-4" PROVIDED
TRAVEL DISTANCE:	300' MAX / 126'-5" PROVIDED

## PROJECT DIRECTORY

**LANDLORD CONTACT:**  
 BILLINGSLEY COMPANY  
 1722 ROUTH STREET  
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**MEP CONSULTANT:**  
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## SHEET INDEX

REV.	ARCHITECTURAL
G0.0	COVER SHEET & INDEX
G0.1	GENERAL NOTES
G0.2	TEXAS ACCESSIBILITY STANDARDS
G0.3	TEXAS ACCESSIBILITY STANDARDS
G0.4	KEY PLAN
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A2.0E	CONSTRUCTION PLAN
A2.2W	POWER & COMMUNICATION PLAN
A2.2E	POWER & COMMUNICATION PLAN
A2.3W	REFLECTED CEILING PLAN
A2.3E	REFLECTED CEILING PLAN
A2.5W	FINISH PLAN
A2.5E	FINISH PLAN
A6.0	INTERIOR ELEVATIONS & SECTIONS
A7.0	PARTITION & DOOR TYPES
M0.01	MECHANICAL NOTES & SYMBOLS
M1.01	MECHANICAL SPECIFICATIONS
M2.04E	LEVEL 04 MECHANICAL PLAN
M2.04W	LEVEL 04 MECHANICAL PLAN
M2.14E	LEVEL 04 MECHANICAL PLAN
M2.14W	LEVEL 04 MECHANICAL PLAN
M3.01	MECHANICAL NOTES & SYMBOLS
E0.01	ELECTRICAL NOTES & SYMBOLS
E1.01	ELECTRICAL SPECIFICATIONS
E1.02	ELECTRICAL SPECIFICATIONS
E2.04E	LEVEL 04 ELECTRICAL PLAN
E2.04W	LEVEL 04 ELECTRICAL PLAN
E3.04E	LEVEL 04 LIGHTING PLAN
E3.04W	LEVEL 04 LIGHTING PLAN
P0.01	PLUMBING NOTES & SYMBOLS
P1.01	PLUMBING SPECIFICATIONS
P2.04E	LEVEL 04 PLUMBING PLAN - EAST

## DEFERRED SUBMITTALS

FIRE ALARM SYSTEM: DESIGN/BUILT. G.C. SHALL BE RESPONSIBLE FOR PREPARING DRAWINGS AND OBTAINING ALL BUILDING PERMITS AS REQUIRED BY LOCAL JURISDICTION.

FIRE SPRINKLER SYSTEM: DESIGN/BUILT. G.C. SHALL BE RESPONSIBLE FOR PREPARING DRAWINGS AND OBTAINING ALL BUILDING PERMITS AS REQUIRED BY LOCAL JURISDICTION.

## ABBREVIATIONS

A	AMPERE	HT	HEIGHT
A.D.A.	AMERICANS WITH DISABILITIES ACT	HVAC	HEATING, VENTILATION & AIR CONDITIONING
A.F.F.	ABOVE FINISHED FLOOR	MAX.	MAXIMUM
A.H.J.	AUTHORITIES HAVING JURISDICTION	M.D.F.	MEDIUM DENSITY FIBER BOARD
ADNL	ADDITIONAL	MIN.	MINIMUM
BD.	BOARD	MFR.	MANUFACTURER
BLKG.	BLOCKING	N.I.C.	NOT IN CONTRACT
CAB.	CABINET	N.T.S.	NOT TO SCALE
CLG.	CEILING	O.C.	ON CENTER
CLR.	CLEAR OPENING	OP.G.	OPENING
COL.	COLUMNS	PART.	PARTICLE
CONTR.	CONTRACTOR	PR.	PAIR
DWGS.	DRAWINGS	PREFAB.	PREFABRICATED
E.C.	EXISTING TO BE CAPPED	P.T.L.	PRESSURE TREATED LUMBER
ELEC.	ELECTRICAL	REF.	REFERENCE
ELEC.	ELECTRICAL	REOD	REQUIRED
EQ.	EQUAL	SIM	SIMILAR
F.E.	FIRE EXTINGUISHER	S.S.	STAINLESS STEEL
FEC	FIRE EXTINGUISHER CABINET	STD.	STANDARD
FHC	FIRE HOSE CABINET	T.B.D.	TO BE DETERMINED
FLUOR.	FLUORESCENT	TYP.	TYPICAL
F.R.F.	FIRE RETARDANT TREATED	U.O.N.	UNLESS OTHERWISE NOTED
FRP	FIBERGLASS REINFORCED PLASTIC	V	VOLTS
GA.	GALVE	VCT	VINYL COMPOSITION TILE
G.C.	GENERAL CONTRACTOR	V.I.F.	VERIFY IN FIELD
GWBX	TYPE 'X' GYPSUM BOARD	W	WITH
GYP. BD.	GYPSUM BOARD	W/O	WITHOUT
H.M.	HOLLOW METAL	WH	WATER HEATER
HWIR	HARDWARE		

## SITE PLAN



## LANDLORD/TENANT APPROVAL

I HAVE REVIEWED THESE DRAWINGS AND BY EXECUTION, I HAVE ACCEPTED ALL INFORMATION, SPECIFICATIONS, DIMENSIONS, AND DESIGN ELEMENTS AS INDICATED IN THESE DRAWINGS. NO CHANGES WILL BE MADE WITHOUT WRITTEN NOTIFICATION TO LANDLORD'S REPRESENTATIVE. I ASSUME FULL RESPONSIBILITY FOR ALL ASSOCIATED COSTS OF MATERIALS, LABOR, AND ADDITIONAL DESIGN FEES FOR ANY CHANGES TO THE SCOPE OF WORK OUTLINED IN THESE DRAWINGS.

\_\_\_\_ APPROVED \_\_\_\_ APPROVED AS NOTED

DATE: \_\_\_\_\_

TENANT: \_\_\_\_\_

LANDLORD: \_\_\_\_\_

## LANDLORD NOTES

1. IF THIS PLAN IS TO BE CONSTRUCTED, AND IF THE AMOUNT OF CONSTRUCTION IS OVER \$50,000.00, THE OWNER IS TO NOTIFY THE idGROUP IMMEDIATELY, AND CONSTRUCTION DOCUMENTS WILL BE REQUIRED TO BE SUBMITTED FOR T.A.S. REVIEW. THE BUILDING OWNER IS RESPONSIBLE FOR COMPLETE BUILDING CODE AND "TEXAS ACCESSIBILITY STANDARDS" COMPLIANCE THROUGHOUT THE BUILDING.

2. AS A REGISTERED INTERIOR DESIGNER IN THE STATE OF TEXAS, WE ARE REQUIRED BY LAW (TEXAS GOVERNMENT CODE #469.101 AND 102) TO SUBMIT DOCUMENT SETS INTENDED FOR CONSTRUCTION AND/OR RENOVATION FOR TAS COMPLIANCE REVIEW UPON ISSUE. AS THE BUILDING OR FACILITY OWNER, YOU ARE ALSO REQUIRED BY THE SAME LAW TO DISALLOW CONSTRUCTION, RENOVATION OR MODIFICATIONS AND/OR APPLICATION FOR BUILDING PERMITS WITHOUT FIRST SUBMITTING PLANS AND SPECIFICATIONS FOR TAS COMPLIANCE REVIEW. SHOULD WORK COMMENCE PER DOCUMENTATION EXPRESSLY PREPARED FOR BID OR PRICING, ALL LIABILITY FOR TAS AND BUILDING CODE COMPLIANCE SHALL FALL UPON THE BUILDING AND/OR FACILITY OWNER.

3. idGROUP HAS PRODUCED THE ATTACHED SET OF DRAWINGS, INTENDED FOR CONSTRUCTION. IF LANDLORD ELECTS NOT TO HAVE A CONSTRUCTION DOCUMENT REVIEW MEETING WITH TENANT TO REVIEW ALL DESIGN ASPECTS OF THESE DRAWINGS, AND RECEIVE AN APPROVAL SIGNATURE FROM SAID TENANT, idGROUP WILL NOT BE RESPONSIBLE FOR MISUNDERSTANDINGS, ERRORS, AND/OR OMISSIONS IN THESE DRAWINGS REGARDLESS OF PREVIOUS CONVERSATIONS AND/OR MEETINGS. LIKEWISE, IF idGROUP IS NOT RETAINED FOR CONSTRUCTION ADMINISTRATION DURING THE CONSTRUCTION PROCESS, WE WILL NOT BE HELD LIABLE FOR DISCREPANCIES OR PROBLEMS DISCOVERED IN THE FIELD, AND SUBSEQUENT DECISIONS MADE WITHOUT OUR KNOWLEDGE.

## GENERAL NOTES

### A. GENERAL

- THE GENERAL CONDITIONS OF THE CONTRACT FOR CONSTRUCTION, A.I.A. STANDARD FORM A201 - CURRENT EDITION, ARE HEREBY INCORPORATED INTO THIS DOCUMENT EXCEPT AS SPECIFICALLY MODIFIED BELOW.
- THE CONTRACTOR SHALL SECURE AND PAY FOR THE BUILDING PERMIT AND OTHER PERMITS AND GOVERNMENTAL FEES, LICENSES AND INSPECTIONS NECESSARY FOR PROPER EXECUTION AND COMPLETION OF THE WORK. SCHEDULING OF APPROVALS AND INSPECTIONS BY AUTHORITIES HAVING JURISDICTION OVER THE WORK IS THE RESPONSIBILITY OF THE CONTRACTOR.
- THE CONTRACT DOCUMENTS CONVEY DESIGN INTENT AND THE GENERAL TYPE OF CONSTRUCTION DESIRED ARE INTENDED TO APPLY TO THE FINEST QUALITY OF CONSTRUCTION, MATERIAL AND WORKMANSHIP THROUGHOUT.
- THE idGROUP IS NOT RESPONSIBLE FOR ENGINEERING THESE DOCUMENTS. FOR CONSTRUCTION SETS WITHOUT ENGINEERING DOCUMENTS, THE CONTRACTOR SHALL PROVIDE SHOP DRAWINGS PRIOR TO CONSTRUCTION AND AS-BUILTS UPON COMPLETION FOR ELECTRICAL AND MECHANICAL TRADES TO THE LANDLORD.
- PRIOR TO SUBMITTING A PROPOSAL OR COMMENCEMENT OF WORK, THE CONTRACTOR SHALL VISIT THE PROJECT SITE TO COMPARE THE SCOPE OF WORK AS OUTLINED IN THESE DOCUMENTS WITH EXISTING CONDITIONS. PROMPTLY REPORT ANY ERRORS, OMISSIONS, INCONSISTENCIES OR OTHER DETRIMENTAL CONDITIONS TO THE idGROUP. IF THE CONTRACTOR FAILS TO PERFORM THIS OBLIGATION, THE CONTRACTOR WILL BE RESPONSIBLE FOR ALL COSTS AND DAMAGES ASSOCIATED WITH ACTIONS REQUIRED TO CORRECT UNREPORTED CONDITIONS THAT OTHERWISE COULD HAVE BEEN AVOIDED.
- IN THE EVENT THAT DISCREPANCIES ARE FOUND BETWEEN DRAWINGS AND/OR SPECIFICATIONS, THE CONTRACTOR SHALL REQUEST A CLARIFICATION FROM THE idGROUP IN WRITING. THE idGROUP'S RESPONSE TO THE CONTRACTOR'S REQUEST FOR INFORMATION SHALL NOT BE CAUSE FOR A CHANGE IN THE CONTRACT AMOUNT UNLESS IT IS AGREED THAT THE ORIGINAL SCOPE OF WORK HAS BEEN ALTERED BY THE RESPONSE.
- THE CONTRACTOR SHALL CONTACT THE BUILDING MANAGEMENT TO DETERMINE ANY SPECIAL REQUIREMENTS AND RULES / REGULATIONS GOVERNING ALL PHASES OF WORK ON THE PREMISES.
- PRIOR TO BEGINNING WORK, THE CONTRACTOR SHALL FURNISH A CONSTRUCTION SCHEDULE SHOWING THE CHRONOLOGICAL PHASES OF WORK, SCHEDULE OF VALUES, AND INSURANCE CERTIFICATE. THIS SCHEDULE SHALL INDICATE ORDERING LEAD TIMES, A BEGINNING AND END DATE FOR EACH PHASE AND A PROJECTED COMPLETION DATE FOR THE ENTIRE PROJECT.
- THE CONTRACTOR IS WHOLLY RESPONSIBLE FOR THE COORDINATION AND SCHEDULING OF THE WORK EFFORTS FOR ALL ENGINEERS, SUBCONTRACTORS, CRAFTSMEN AND TRADESMEN REQUIRED TO COMPLETE THE JOB AND SHALL BE RESPONSIBLE FOR PROVIDING THEM WITH FULL SETS OF CURRENT DRAWINGS, ADDENDUM, AND OTHER SUPPLEMENTAL INFORMATION PERTINENT TO THE COMPLETION OF THE WORK.
- THE CONTRACTOR SHALL PROVIDE TEMPORARY LIGHTING AND ELECTRICAL SERVICE FOR TRADES.
- UNLESS OTHERWISE STIPULATED IN THE CONTRACT DOCUMENTS, THE CONTRACTOR SHALL BE RESPONSIBLE FOR THE PROVISION, STORAGE AND PAYMENT OF LABOR, MATERIALS, TOOLS, EQUIPMENT, TOOLS, CONSTRUCTION EQUIPMENT, MACHINERY, TRANSPORTATION AND OTHER FACILITIES NECESSARY FOR PROPER EXECUTION AND COMPLETION OF THE WORK WHETHER OR NOT IT IS SPECIFICALLY CALLED OUT OR DETAILED ON THE DRAWINGS.
- THE CONTRACTOR WARRANTS TO THE OWNER THAT MATERIALS AND EQUIPMENT FURNISHED UNDER THE CONTRACT WILL MEET INDUSTRY STANDARDS AND BE NEW AND OF GOOD QUALITY UNLESS OTHERWISE PERMITTED BY THE CONTRACT DOCUMENTS. THE WORK WILL BE INSTALLED PER MANUFACTURER'S SPECIFICATIONS, FREE FROM DEFECTS AND WILL BE COMPLETED IN A NEAT AND WORKMANLIKE MANNER ACCEPTABLE TO THE OWNER.
- THE CONTRACTOR SHALL PROMPTLY CORRECT IN A PROFESSIONAL MANNER, AT NO COST TO THE OWNER AND WITHOUT CHANGE IN CONTRACT TIME, ALL NON-CONFORMING OR DEFECTIVE WORK AND DAMAGES CAUSED BY HIS WORK OR WORKMEN WHETHER DISCOVERED BEFORE OR AFTER SUBSTANTIAL COMPLETION.
- THE CONTRACTOR SHALL INSPECT ALL EQUIPMENT AND SYSTEMS FOR PROPER OPERATIONS UPON SUBSTANTIAL COMPLETION OF PROJECT.
- THE CONTRACTOR SHALL THOROUGHLY CLEAN THE ENTIRE PROJECT SITE AND ADJACENT AFFECTED SPACES TO THE SATISFACTION OF THE OWNER.

### B. DRAWING CONVENTIONS

- DIMENSIONS TAKE PRECEDENCE OVER SCALE ON THE CONSTRUCTION DRAWINGS. NOTIFY THE idGROUP OF DISCREPANCIES BETWEEN DRAWING DIMENSIONS AND FIELD CONDITIONS.
- DIMENSIONS ARE GIVEN TO FACE OF FINISHED MATERIAL UNLESS OTHERWISE NOTED.
- PARTITION THICKNESS IS DERIVED FROM DESCRIPTION OF THE PARTITION CONSTRUCTION AND/OR DESIGNATED DETAIL.
- PARTITIONS THAT INTERSECT INTERIOR OR EXTERIOR GLAZED WALLS ARE TO BE CENTERED ON MULLIONS AND PERPENDICULAR TO EXTERIOR WALL UNLESS DETAILED OTHERWISE.
- UNLESS OTHERWISE NOTED, PARTITIONS AND OTHER ELEMENTS ON THE DRAWING THAT ARE DRAWN AT AN OBLIQUE ANGLE ARE TO BE CONSTRUCTED AT A 45-DEGREE ANGLE TO THE MAIN GRID.
- WALLS SHOWN ALIGNED WITH BASE BUILDING STRUCTURE SHALL BE FLUSH AND SMOOTH WITH BASE BUILDING STRUCTURE UNLESS OTHERWISE NOTED.
- UNLESS DIMENSIONED OTHERWISE, DEPTH OF FURRING ON COLUMNS AND OTHER ELEMENTS IS TO BE HELD TO THE MINIMUM THICKNESS REQUIRED TO CONCEAL MECHANICAL, PLUMBING OR ELECTRICAL COMPONENTS.
- UNLESS OTHERWISE INDICATED, POSITION DOOR JAMBS 6" OFF THE FACE OF ADJACENT INTERSECTING PARTITIONS OR CENTER ON PARTITION.
- OUTLETS THAT OCCUR ON OPPOSITE SIDES OF THE SAME PARTITION ARE TO BE STAGGERED HORIZONTALLY A MINIMUM OF 12" TO MINIMIZE SOUND TRANSMISSION.

### C. DEMOLITION, CUTTING, AND PATCHING

- THE CONTRACTOR SHALL INSPECT THE SITE AND CALL ATTENTION TO ENVIRONMENTAL HAZARDS WITH BUILDING MANAGEMENT. SAID HAZARDS ARE TO BE REMOVED AT THE BUILDING'S EXPENSE. REMOVAL TO ADHERE TO THE ENVIRONMENTAL PROTECTION AGENCY'S GUIDELINES.
- THE CONTRACTOR IS RESPONSIBLE FOR ALL DEMOLITION, CUTTING AND PATCHING REQUIRED TO FACILITATE COMPLETION OF THE WORK.
- PRIOR TO STARTING WORK, ERECT TEMPORARY BARRIERS AROUND THE PERIMETER OF THE PROJECT AND BASE BUILDING TOILET FACILITIES TO PREVENT THE SPREAD OF DUST AND OTHER CONTAMINANTS TO ADJACENT AREAS OF THE BUILDING. MAINTAIN DUST PROOF AND SOUND BARRIERS THROUGHOUT THE COURSE OF CONSTRUCTION OR UNTIL NO LONGER REQUIRED. REMOVE BARRIERS AND REPAIR ANY DAMAGE CAUSED BY THEIR INSTALLATION TO MATCH ADJACENT SURFACES.
- DEMOLITION WORK SHALL BE COORDINATED WITH THE OWNER TO MINIMIZE DISRUPTION AND INCONVENIENCE TO OTHER TENANTS IN OCCUPIED BUILDINGS. MAINTAIN SAFE MEANS OF ACCESS AND EGRESS TO OCCUPIED TENANT SPACES.
- UNLESS NOTED OTHERWISE, ALL DEMOLISHED DEBRIS, MATERIAL EQUIPMENT AND FIXTURES BECOME THE PROPERTY OF THE CONTRACTOR WHO IS RESPONSIBLE FOR ITS SAFE REMOVAL FROM THE SITE. DISPOSAL OF DEMOLISHED MATERIAL SHALL BE IN ACCORDANCE WITH APPLICABLE RULES, REGULATIONS AND ORDINANCES OF AUTHORITIES HAVING JURISDICTION. COORDINATE WITH BUILDING MANAGEMENT.
- THE CONTRACTOR SHALL FURNISH BUILDING MANAGEMENT WITH A COMPLETE INVENTORY LIST OF ITEMS THAT CAN BE REUSED AND/OR STORED IN BUILDING STOCK. CAREFULLY REMOVE MATERIAL, EQUIPMENT AND FIXTURES DESIGNATED TO BE SALVAGED AND DELIVER THEM TO BUILDING MANAGEMENT.
- MAINTAIN THE FUNCTION AND INTEGRITY OF EXISTING FIRE, LIFE/SAFETY AND SECURITY SYSTEMS.
- MAINTAIN THE INTEGRITY OF RATED PARTITIONS AND OTHER FIRE RATED ASSEMBLIES. REPAIR OR REPLACE DAMAGED PORTIONS WITH NEW CONSTRUCTION TO MATCH EXISTING AND HAVE REPAIR WORK APPROVED BY THE BUILDING INSPECTOR.
- NEW PIPE, CONDUIT AND DUCT PENETRATIONS OF FIRE RATED ASSEMBLIES ARE TO BE CONSTRUCTED IN ACCORDANCE WITH AN UNDERWRITERS LABORATORY TESTED DESIGN.
- IN BUILDINGS CONSTRUCTED WITH POST-TENSIONED CONCRETE, LOCATE P-T TENDONS BY X-RAY DETECTION PRIOR TO STARTING OF ANY CUTTING OR DRILLING. COORDINATE ALL SUCH ACTIVITIES WITH BUILDING MANAGEMENT.
- PATCH ALL EXISTING OR NEWLY DAMAGED AREAS TO MATCH ADJACENT SURFACES IN QUALITY, TEXTURE AND COLOR.
- EXISTING CIRCUITS NOT BEING USED ARE TO BE REMOVED TO THE PANEL. BREAKERS SHALL BE LABELED "SPARE" AND LEFT IN THE OPEN POSITION.
- PLUMBING TO BE ABANDONED SHALL BE CAPPED BEHIND EXISTING FINISHED SURFACES. EXISTING SURFACES SHALL BE PATCHED TO MATCH EXISTING ADJACENT FINISHES.

### D. GENERAL CONSTRUCTION

- THE CONTRACTOR SHALL FIRMLY ANCHOR PARTITIONS PER JURISDICTION AND INDUSTRY STANDARDS AND USE METAL TRIM ACCESSORIES AT EXPOSED CORNERS, EDGES AND ENDS IN PLASTER AND DRYWALL PARTITIONS.
- THE CONTRACTOR SHALL PROVIDE ACCESS PANELS REQUIRED FOR MECHANICAL, ELECTRICAL AND PLUMBING INSTALLATIONS PER LOCAL BUILDING CODES. LOCATIONS SHALL BE COORDINATED WITH BUILDING MANAGEMENT PRIOR TO INSTALLATION.
- CEILING JOINTS IN THE FIELD SHALL BE SQUARE, LEVEL AND PERFECTLY ALIGNED WITH EACH OTHER AND WITH THE RECESSED LIGHT FIXTURES. ALL RECESSED FIXTURES SHALL BE SET FLUSH INTO CEILING.
- COMMUNICATION, DATA, SECURITY AND SIMILAR SYSTEMS WILL BE FURNISHED AND INSTALLED BY THE TENANT UNLESS OTHERWISE NOTED IN THE CONTRACT DOCUMENTS. IT SHALL BE THE RESPONSIBILITY OF THE CONTRACTOR TO COORDINATE WITH THE TENANTS VENDORS AND PROVIDE CONDUIT, BOXES AND OTHER ROUGH-IN REQUIREMENTS TO FACILITATE FINAL WIRING INSTALLATION.
- COORDINATE AND FIELD VERIFY THE ROUGH-IN LOCATION OF ELECTRICAL, COMMUNICATION AND DATA CONNECTIONS TO TENANT SUPPLIED FURNITURE SYSTEM.
- WIRING AND CONDUIT IS TO BE CONCEALED IN BOTH NEW AND EXISTING PARTITIONS WITH ALL OUTLETS, SWITCHES AND SIMILAR DEVICES MOUNTED IN RECESSED JUNCTION BOXES WITH FLUSH COVER PLATES. SURFACE MOUNTED CONDUIT, WIREMOLD, OUTLETS, ETC. WILL NOT BE PERMITTED UNLESS OTHERWISE NOTED.
- THE CONTRACTOR SHALL PROVIDE RETURN AIR OPENINGS IN PARTITIONS TO DECK AND ABOVE CEILINGS TO MATCH AREA CALCULATION REQUIREMENTS AS SHOWN ON ENGINEERING DRAWINGS. OPENINGS IN DEMISING AND SOUND ATTENUATED WALLS TO HAVE SOUND BOOTS. OPENINGS IN FIRE RATED WALLS SHALL HAVE FIRE OR SMOKE DAMPERS AS REQUIRED BY CODE. OPENINGS SHALL BE SUFFICIENTLY FRAMED FOR VIBRATION.
- DUCTWORK SHALL BE INSULATED FOR THERMAL AND ACOUSTIC CONSIDERATIONS.
- WOOD CASEWORK SHALL CONFORM TO ARCHITECTURAL WOODWORK INSTITUTE (AWI) "PREMIUM GRADE" QUALITY STANDARDS AND SHALL BE "FLUSH OVERLAY" CONSTRUCTION UNLESS DETAILED OTHERWISE ON THE DRAWINGS.
- PLASTIC LAMINATE CASEWORK SHALL CONFORM TO ARCHITECTURAL WOODWORK INSTITUTE (AWI) "CUSTOM GRADE" QUALITY STANDARDS AND SHALL BE "FLUSH OVERLAY" CONSTRUCTION UNLESS DETAILED OTHERWISE ON THE DRAWINGS.
- CASEWORK SHALL BE SCRIBED TO WALL OR CEILING. CONTRACTOR SHALL COORDINATE WITH OTHER INVOLVED TRADES.
- LOCKSETS SHALL BE "KEYED" IN ACCORDANCE WITH BUILDING MANAGEMENT'S REQUIREMENTS. "KEYS" ARE TO BE PROPERLY TESTED AND DELIVERED TO BUILDING MANAGEMENT. THE NUMBER OF MASTER AND PASS KEYS SHALL BE COORDINATED WITH BUILDING MANAGEMENT.
- WOOD SHELVEING AND PAINTED DOORS SHALL RECEIVE PRIMING, SANDING AND (2) FULL COATS OF SEMI-GLOSS ENAMEL, FREE OF BRUSH STROKES.
- GRIND, SAND, LEVEL OR FLOAT FLOOR AND WALL SURFACES AS NECESSARY TO ACHIEVE A LEVEL, SMOOTH SUBSTRATE ACCEPTABLE FOR INSTALLATION OF THE SPECIFIED FINISH MATERIAL.
- PREPARE WALL AND FLOOR SURFACES TO MEET STANDARD SMOOTHNESS AND LEVELING MATERIAL REQUIREMENTS AS SPECIFIED BY THE MANUFACTURER AND CONTRACT DOCUMENTS PRIOR TO INSTALLATION OF NEW BUILDING FINISHES.

### D. GENERAL CONSTRUCTION (CONT.)


- EXISTING APPURTENANCES NOT BEING REMOVED SHALL BE REFURBISHED, LOOSE ITEMS TIGHTENED AND MISSING OR BROKEN PARTS REPLACED TO ACHIEVE A FINISHED FIRST CLASS INSTALLATION AND "LIKE-NEW" APPEARANCE.
- THE CONTRACTOR SHALL REMOVE SWITCH PLATES, OUTLET PLATES, SURFACE HARDWARE, ETC. PRIOR TO PAINTING. REPLACE SAME WHEN PAINTING HAS BEEN COMPLETED. REMOVE PAINT SPLATTERS FROM ADJACENT SURFACES - I.E. MULLIONS, CEILING GRID, ETC.
- THE CONTRACTOR SHALL BE RESPONSIBLE FOR COMPLYING WITH LOCAL V.O.C. REGULATIONS FOR MATERIALS USED IN CONSTRUCTION.
- TILE SHALL BE LAID IN SQUARE PATTERN PARALLEL TO WALLS UNLESS OTHERWISE NOTED.
- ALL VARYING FLOOR MATERIAL SHALL BE INSTALLED FLUSH TO EACH OTHER. TRANSITIONS SHALL BE CENTERED ON DOOR UNLESS OTHERWISE NOTED.
- SPACES BEING SURFACED SHALL BE CLOSED TO TRAFFIC AND OTHER WORK DURING THE LAYING OF FLOORING, STONE, WOOD, OR OTHER MATERIAL. FINISHED FLOORS SHALL BE COVERED AFTER INSTALLATION FOR PROTECTION.

### E. REQUIRED APPROVALS AND SUBMITTALS

- WHERE THE TERMS "APPROVED EQUAL", "OTHER APPROVED", "EQUAL TO", "ACCEPTABLE" OR OTHER GENERAL QUALIFYING TERMS ARE USED, IT SHALL BE UNDERSTOOD THAT REFERENCE IS MADE TO THE RULING AND JUDGMENT OF BUILDING MANAGEMENT AND MUST BE SUBMITTED FOR APPROVAL PRIOR TO PURCHASE OR USE.
  - THE CONTRACTOR SHALL HAVE (10) WORKING DAYS FROM AWARD OF THE CONTRACT TO SUBMIT SUBSTITUTIONS OF SPECIFIED PRODUCTS OR WORK FOR REVIEW BY BUILDING MANAGEMENT AND SHALL INCLUDE CUT SHEETS WITH SPECIFICATIONS AND REASONS FOR SUBSTITUTION. NO SUBSTITUTIONS SHALL BE ACCEPTED AFTER THE INITIAL TIME LIMIT HAS EXPIRED.
  - WHERE REQUIRED BY BUILDING MANAGEMENT, THE CONTRACTOR SHALL REVIEW, SIGN, DATE AND SUBMIT A MINIMUM OF (3) SETS OF COMPLETE AND DETAILED SHOP DRAWINGS, FINISHES, FIXTURE AND EQUIPMENT CUT SHEETS TO idGROUP FOR REVIEW. THE idGROUP SHALL HAVE (10) WORKING DAYS TURNAROUND TIME FROM RECEIPT OF SUBMITTAL. ALL SHOP DRAWINGS AND CUT SHEETS SIGNED "REVIEWED" SHALL SUPERSEDE ORIGINAL DRAWINGS IN DESIGN APPEARANCE ONLY. CONTRACTORS SHALL ASSUME RESPONSIBILITY FOR ERRORS IN THEIR DRAWINGS.
  - IN THE EVENT THAT THE FOREMENTIONED DRAWINGS, SPECIFICATIONS, ETC. ARE NOT SUBMITTED FOR REVIEW AND APPROVAL, THE CONTRACTOR SHALL ASSUME FULL RESPONSIBILITY FOR THE REPLACEMENT, CORRECTION OR ACQUISITION OF PRODUCTS TO COMPLY WITH OWNER'S SPECIFICATION AND APPROVAL.
  - THE CONTRACTOR SHALL PROVIDE CHALK LINES ON THE SLAB OF PARTITIONS FOR APPROVAL PRIOR TO FRAMING AND SHALL NOTIFY idGROUP OF ANY DEVIATION FROM CONSTRUCTION DIMENSIONS OR CLEARANCES AS DESIGNATED ON THE DRAWINGS OR OF APPARENT CONSTRUCTION CONFLICTS.
  - BUILDING MECHANICAL AND ELECTRICAL SERVICE SHUT DOWN REQUIRED FOR THIS PROJECT SHALL BE SUBMITTED IN WRITING TO BUILDING MANAGEMENT BY THE CONTRACTOR A MINIMUM OF (72) HOURS IN ADVANCE OF THE SHUT DOWN. THE CONTRACTOR SHALL OBTAIN APPROVAL FROM AUTHORITIES HAVING JURISDICTION PRIOR TO SHUT DOWN AND SHALL NOT OVERLY INCONVENIENCE BUILDING OCCUPANTS.
  - UPON SUBSTANTIAL COMPLETION OF WORK, THE HVAC SYSTEM SHALL BE BALANCED BY A QUALIFIED ENGINEER AND A WRITTEN REPORT SHALL BE SUBMITTED TO BUILDING MANAGEMENT.
  - UPON SUBMISSION OF THE "FINAL APPLICATION FOR PAYMENT", THE CONTRACTOR SHALL PROVIDE BUILDING MANAGEMENT WITH (1) SET OF AS-BUILT DOCUMENTATION INCLUDING DRAWINGS, SPECIFICATIONS, ADDENDA, CHANGE ORDERS, PRODUCT DATA, EQUIPMENT WARRANTIES AND MANUALS, FINISH SAMPLES AND OTHER REQUIRED SUBMITTALS. THE CONTRACTOR SHALL PROVIDE BUILDING MANAGEMENT WITH A WRITTEN WARRANTY COVERING ALL WORK PERFORMED UNDER THE CONTRACT. WARRANTY SHALL BE FOR A PERIOD OF ONE YEAR COMMENCING ON THE DATE OF SUBSTANTIAL COMPLETION AND SHALL BE INCLUDED WITH THIS SUBMITTAL.
  - THE CONTRACTOR SHALL SUPPLY LIEN WAIVERS RELATING TO ALL WORK WITH THE "FINAL APPLICATION FOR PAYMENT" TO BE REVIEWED FOR "FINAL CERTIFICATE OF PAYMENT".
- F. CHANGES IN WORK**
- THE TENANT WITHOUT INVALIDATING THE CONTRACT, MAY ORDER EXTRA WORK OR MAKE CHANGES BY ALTERING, ADDING TO OR DEDUCTING FROM THE WORK - THE CONTRACT SUM BEING ADJUSTED ACCORDINGLY. SUCH WORK SHALL BE EXECUTED UNDER THE CONDITIONS OF THE ORIGINAL CONTRACT EXCEPT THAT ANY CLAIM FOR EXTENSIONS OF TIME CAUSED THEREBY SHALL BE INDICATED ON THE CHANGE ORDER.
  - CLAIMS FOR ADDITIONAL WORK WILL BE SUBMITTED IN WRITING FOR REVIEW BY BUILDING MANAGEMENT AND SHOULD INCLUDE A COMPLETE DESCRIPTION OF THE WORK, MATERIALS BEING USED, THE ROOM NUMBER OR AREA AFFECTED, AND THE AUTHORIZATION UNDER WHICH THE WORK IS BEING PERFORMED.

## PROJECT NOTES

- THE SUBMISSION OF A PROPOSAL SHALL BE CONSTRUED AS EVIDENCE THAT SUCH AN EXAMINATION HAS BEEN MADE AND LATER CLAIMS FOR LABOR, EQUIPMENT, OR MATERIAL REQUIRED FOR DIFFICULTIES ENCOUNTERED WHICH COULD HAVE BEEN FORESEEN HAD SUCH AN EXAMINATION BEEN MADE. WILL NOT BE RECOGNIZED. idGROUP IS NOT COMMISSIONED TO VERIFY EVERY EXISTING CONDITION, VISIBLE OR OTHERWISE, THEREFORE IT IS THE GENERAL CONTRACTOR'S OBLIGATION TO ASSUME ALL RESPONSIBILITY FOR MODIFYING ANY AND ALL EXISTING CONDITIONS TO MEET THE DESIGN INTENT OF THESE DRAWINGS.
- BULLETED NOTES ARE GENERAL CONDITIONS REQUIRED FOR THE PLAN. NUMBERED NOTATIONS REFERENCE SPECIFIC LOCATIONS ON THE DRAWINGS.
- THE BUILDING ENVELOPE, MECHANICAL, ELECTRICAL, SERVICE-WATER HEATING AND ILLUMINATION SYSTEMS, AND EQUIPMENT SHALL COMPLY WITH THE MOST CURRENT APPLICABLE INTERNATIONAL ENERGY CONSERVATION CODE, AS RECOGNIZED BY THE MUNICIPALITY GOVERNING THIS PROJECT.
- ITEMS NOTED TO BE "TOUCHED-UP" ARE TO BE BROUGHT TO AN ACCEPTABLE INDUSTRY STANDARD LEVEL OF REFURBISHMENT. IF AN ENTIRE WALL(S) REQUIRES REPAINTING IN ORDER TO ACHIEVE AN ACCEPTABLE FINISH, INCLUDE NECESSARY FEES IN BID TO DO SO.
- RETURN REUSABLE MATERIALS TO BUILDING STOCK. VERIFY ACCEPTABILITY OF MATERIALS WITH BUILDING MANAGER.
- REUSE AS MANY EXISTING MATERIALS FROM LEASE AS POSSIBLE, TOUCH UP. VERIFY AVAILABILITY OF MATERIALS TO BE USED FROM BUILDING STOCK WITH BUILDING MANAGER.
- CONTRACTOR TO PROTECT PUBLIC CORRIDOR, ADJACENT SPACES, AND MATERIALS DURING CONSTRUCTION FROM DUST, DIRT, NOISE, AND HARM.
- ALL CONSTRUCTION MATERIALS TO BE ASBESTOS FREE. idGROUP SHALL HAVE NO RESPONSIBILITY FOR THE DISCOVERY, PRESENCE, HANDLING, REMOVAL OR DISPOSAL OF, OR EXPOSURE TO HAZARDOUS MATERIALS IN ANY FORM AT THE PROJECT SITE, INCLUDING BUT NOT LIMITED TO ASBESTOS PRODUCTS, POLYCHLORINATED BIPHENYL (PCB), OR OTHER TOXIC SUBSTANCES.
- EXISTING PUBLIC RESTROOMS ARE NOT INCLUDED IN THIS SCOPE OF WORK. IF APPLICABLE, COORDINATE WITH BUILDING MANAGEMENT FOR ANY NEW CONSTRUCTION REQUIRED IN RESTROOMS TO ENSURE ADA/TAS COMPLIANCE.
- CONFIRM ALL BUILDING STANDARD SPECIFICATIONS WITH BUILDING MANAGER.
- COORDINATE WITH BUILDING MANAGEMENT FOR ALL DEMOLISHED MATERIALS FOR PROPER STORAGE OR DISPOSAL.
- REMOVE ALL DOORS SHOWN TO BE DEMOLISHED AND SALVAGE FOR POSSIBLE RE-USE IN NEW CONSTRUCTION. CONTRACTOR TO VERIFY QUANTITY, QUALITY, AND CORRECT DOOR SWINGS OF EXISTING DOORS AVAILABLE TO RE-USE.
- REMOVE NAILS AND SCREWS FROM EXISTING WALLS. REPAIR HOLES AND SCRATCHES. PREPARE ALL WALL SURFACES FOR NEW SCHEDULED FINISHES.
- PROVIDE NEW BUILDING STANDARD DOOR STOPS AT ALL NEW DOOR LOCATIONS. REPLACE IF DAMAGED OR MISSING AT ALL EXISTING DOOR LOCATIONS.
- IF NOT ALREADY EXISTING, PROVIDE MINIMUM REQUIRED GYPSUM BOARD FURRING AT FIRE RATED CORE WALLS FOR MILLWORK, MILLWORK STANDARDS, PLUMBING, LIGHT SWITCHES AND/OR ELECTRICAL/TELEPHONE OUTLETS. DO NOT PENETRATE FIRE-RATED PARTITIONS.
- PATCH AND REPAIR WALLS WHERE DEMOLITION, DAMAGE, OR INCOMPLETE WORK HAS OCCURRED. PREPARE SURFACES FOR NEW SCHEDULED FINISHES AND TEXTURES.
- PROVIDE FIRE RETARDANT TREATED WOOD BLOCKING WITHIN WALL TO SUPPORT MILLWORK, STANDARDS, AND WALL HUNG EQUIPMENT.
- ALL NEW MILLWORK TO MEET ADA/TAS REQUIREMENTS.
- PROVIDE FIRE EXTINGUISHERS IN TENANTS LEASE PER CODE. NOT TO EXCEED 75 FEET.
- PROVIDE NEW SWITCH & OUTLETS COVER PLATES WHERE MISSING OR DAMAGED TO MATCH EXISTING.
- CONTRACTOR TO UPDATE ALL PANEL SCHEDULES TO REFLECT CORRECT BREAKER ASSIGNMENTS. PROVIDE DIAGRAM TO BUILDING ENGINEER.
- NEW OUTLETS TO BE MOUNTED AT 17" AF F. OUTLETS ABOVE STANDARD MILLWORK TO BE MOUNTED HORIZONTALLY AT 42" A.F.F., ON CENTER, U.N.O.
- SECURITY, TELEPHONE, AND COMPUTER CABLING WORK TO BE COMPLETED BY TENANTS PROVIDER. GC TO PROVIDE PATHWAY, RING, AND STRING ONLY AT INDICATED LOCATIONS.
- REMOVE EXCESS WIRING RESULTING FROM DEMOLITION.
- EXISTING ELECTRICAL OUTLETS LOCATED ON PARTITIONS TO BE DEMOLISHED ARE NOT SHOWN AND ARE TO BE REMOVED, INCLUDING CONDUIT AND WIRING, BACK TO THEIR RESPECTIVE ELECTRICAL PANELS.
- VERIFY THE AVAILABILITY OF CIRCUITRY ON EXISTING ELECTRICAL PANELS. RECIRCUIT OUTLETS LEFT ON INCOMPLETE CIRCUITS INTO NEW CONSTRUCTION.
- WHERE ELECTRICAL OUTLETS ARE REQUIRED WITHIN (3) FEET OF A SINK, PROVIDE GFI CIRCUITS AS REQUIRED BY CODE.
- EXISTING SWITCHES NOT NOTED ON PLAN AND THAT ARE NOT LOCATED ADJACENT TO LATCH SIDE OF DOORS ARE TO BE REMOVED AND WALL PATCHED TO MATCH ADJACENT WALL CONSTRUCTION.
- PROVIDE EITHER DUAL SWITCHING OR MOTION SENSORS AT ALL ROOMS SWITCHED WITH MORE THAN ONE LIGHT FIXTURE AND IN ROOMS THAT ARE 250 SQ. FT. OR MORE. PROVIDE WATTSTOPPER MOTION SENSORS AND/OR ULTRASONIC DEVICES FOR ROOMS THAT ARE 250 SQ. FT. OR MORE, IN ALL AREAS INCLUDED IN IECC CALCULATIONS.
- SWITCHES INDICATE LOCATION ONLY. SUBSCRIPT LETTERS INDICATE DESIRED SWITCHING. GENERAL CONTRACTOR TO VERIFY QUANTITY OF LIGHT FIXTURES PER CIRCUIT AND QUANTITY OF SWITCHES REQUIRED. ALL NEW SWITCHES TO BE MOUNTED 48" A.F.F. TO CENTERLINE OF SWITCH.
- CLEAN SUPPLY AND RETURN GRILLS THROUGHOUT, U.N.O.
- SURFACE MOUNTED FIRE SAFETY DEVICES TO BE PLACED AWAY FROM CENTERS OF ALL WALLS. PLACEMENT TO COMPLY WITH ALL CODES. WHERE POSSIBLE, COORDINATE WITH TENANT FOR DESIRED LOCATIONS.
- FIRE PROTECTION CONTRACTOR TO VERIFY REQUIREMENTS AND QUANTITY OF FIRE PROTECTION DEVICES. INCLUDE SMOKE DETECTORS, FIRE ALARMS, SPEAKERS, STROBES, ETC. INCLUDE COSTS TO THE SUCH DEVICES INTO BUILDING PANEL. LIFE SAFETY INSTALLATIONS TO MEET ADA/TAS REQUIREMENTS. SUBMIT CITY APPROVED FIRE PROTECTION PLAN FOR SPRINKLER LOCATIONS TO BUILDING MANAGER FOR APPROVAL.
- ALL PAINTED WALLS SHALL RECEIVE TWO COATS OF LATEX PAINT IN BUILDING STANDARD FINISH.
- TOUCH-UP OR REPAIR ALL WALLS AS NEEDED AFTER COMPLETION OF TENANT LEASE SPACE.
- EXISTING WINDOW COVERINGS TO REMAIN, U.N.O. CLEAN AND REPAIR THROUGHOUT. REPLACE TO MATCH EXISTING, IF MISSING OR DAMAGED BEYOND REPAIR.
- CLEAN ALL EXISTING LIGHT FIXTURES THROUGHOUT, U.N.O.

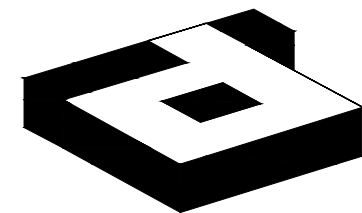

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SUITE #450  
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DRAWING TITLE:

GENERAL NOTES

DRAWING NUMBER:

**G0.1**

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CHAPTER 3: BUILDING BLOCKS

302 FLOOR OR GROUND SURFACES
302.1 CARPET, CARPET OR CARPET TILE SHALL BE SECURELY ATTACHED AND SHALL HAVE A FIRM CUSHION, PAD, OR BACKING OR NO CUSHION OR PAD.
302.2 VERTICAL CHANGES IN LEVEL OF 1/4 INCH (6.4 MM) HIGH MAXIMUM SHALL BE PERMITTED TO BE VERTICAL.
302.3 RAMP RANGES CHANGES IN LEVEL GREATER THAN 1/2 INCH (13 MM) HIGH SHALL BE PERMITTED.
302.4 TURNING SPACE
302.4.1 CIRCULAR SPACE
302.4.2 T-SHAPED SPACE

303 CLEAR FLOOR OR GROUND SPACE
303.1 CLEAR FLOOR OR GROUND SPACE SHALL BE 36 INCHES (915 MM) MINIMUM BY 48 INCHES (1220 MM) MINIMUM.
303.2 MANEUVERING CLEARANCE
303.2.1 FORWARD APPROACH
303.2.2 CLEARANCE IN AN ALCOVE, FORWARD APPROACH

304 DOOR SWING
304.1 DOOR SWING DOORS SHALL BE PERMITTED TO SWING INTO TURNING SPACES.
304.2 CLEAR FLOOR OR GROUND SPACE
304.3 KNEE CLEARANCE
304.3.1 MINIMUM REQUIRED DEPTH
304.3.2 MINIMUM REQUIRED DEPTH

305 KNEE CLEARANCE
305.1 MINIMUM REQUIRED DEPTH
305.2 MINIMUM REQUIRED DEPTH
305.3 MINIMUM REQUIRED DEPTH
305.4 MINIMUM REQUIRED DEPTH
305.5 MINIMUM REQUIRED DEPTH

306 PROTRUDING OBJECTS
306.1 PROTRUDING OBJECTS
306.2 PROTRUDING OBJECTS
306.3 PROTRUDING OBJECTS
306.4 PROTRUDING OBJECTS
306.5 PROTRUDING OBJECTS

307 POST-MOUNTED OBJECTS
307.1 POST-MOUNTED OBJECTS
307.2 POST-MOUNTED OBJECTS
307.3 POST-MOUNTED OBJECTS
307.4 POST-MOUNTED OBJECTS
307.5 POST-MOUNTED OBJECTS

308 REACH RANGES
308.1 REACH RANGES
308.2 REACH RANGES
308.3 REACH RANGES
308.4 REACH RANGES
308.5 REACH RANGES
































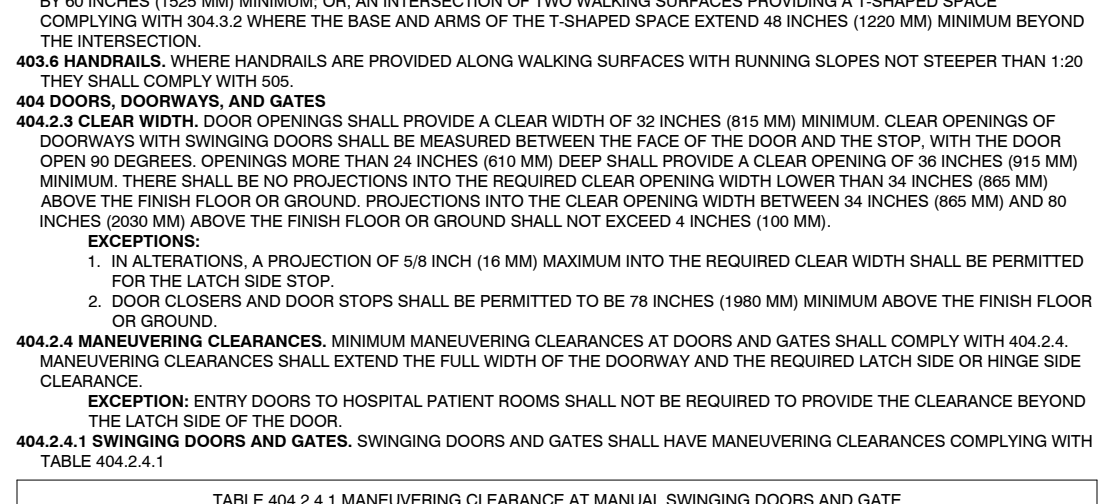


Table 404.2.1: MANEUVERING CLEARANCE AT MANUAL SWINGING DOORS AND GATE. Columns: TYPE OF USE, APPROACH DIRECTION, DOOR OR GATE SIDE, PERPENDICULAR TO DOORWAY, PARALLEL TO DOORWAY.

Table 404.2.2: MANEUVERING CLEARANCE AT DOORWAYS WITHOUT DOORS OR GATES, MANUAL SLIDE DOORS AND MANUAL SWINGING DOORS. Columns: APPROACH DIRECTION, PERPENDICULAR TO DOORWAY, PARALLEL TO DOORWAY.

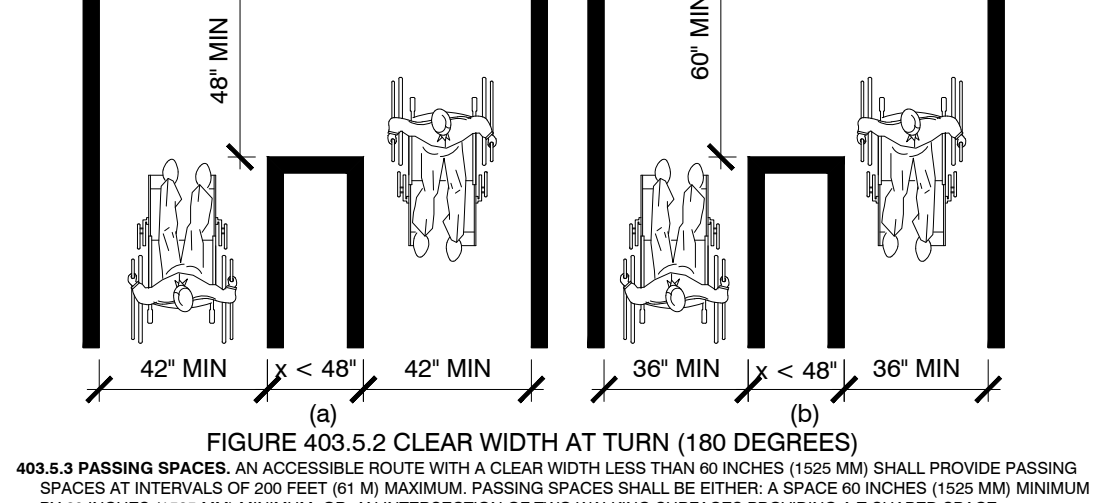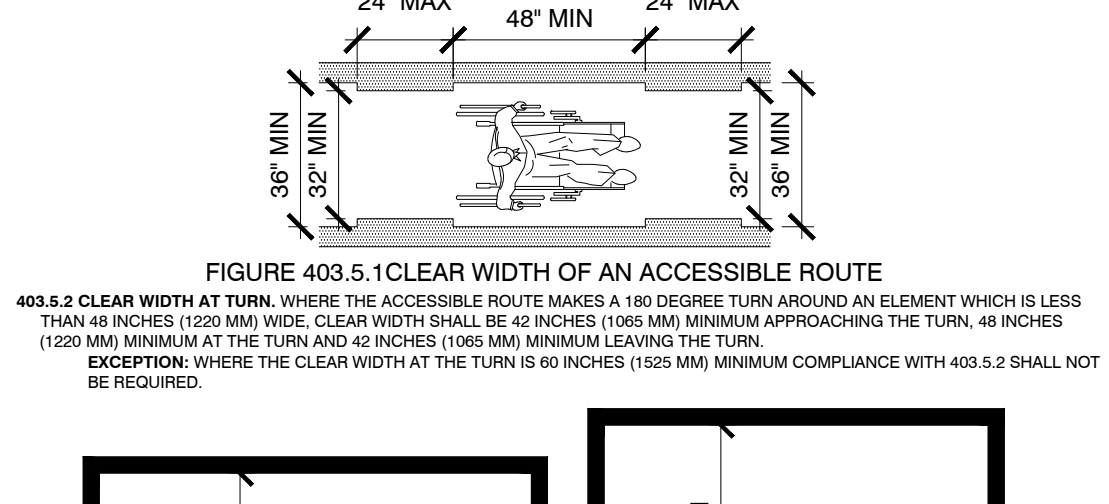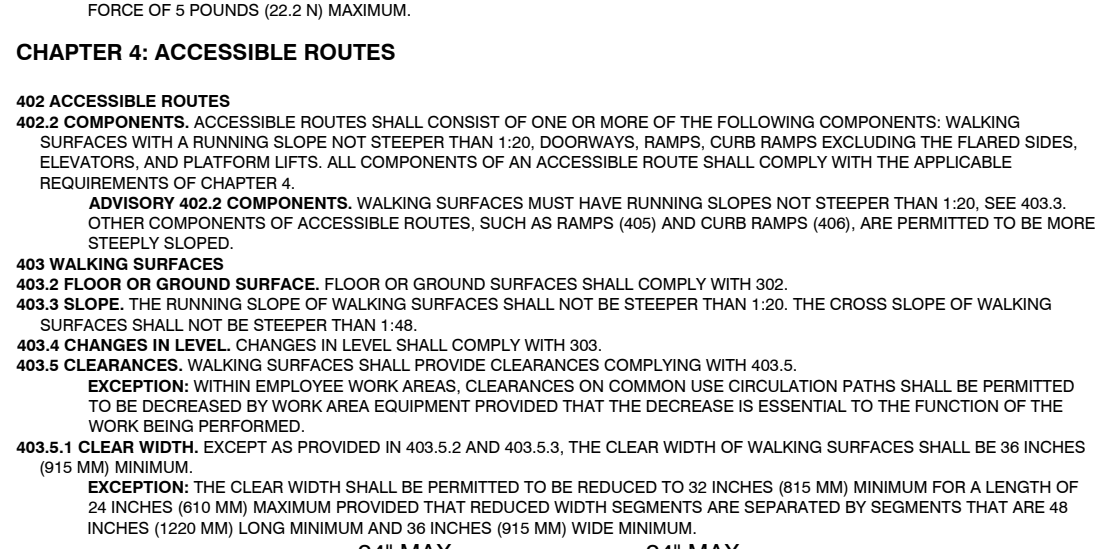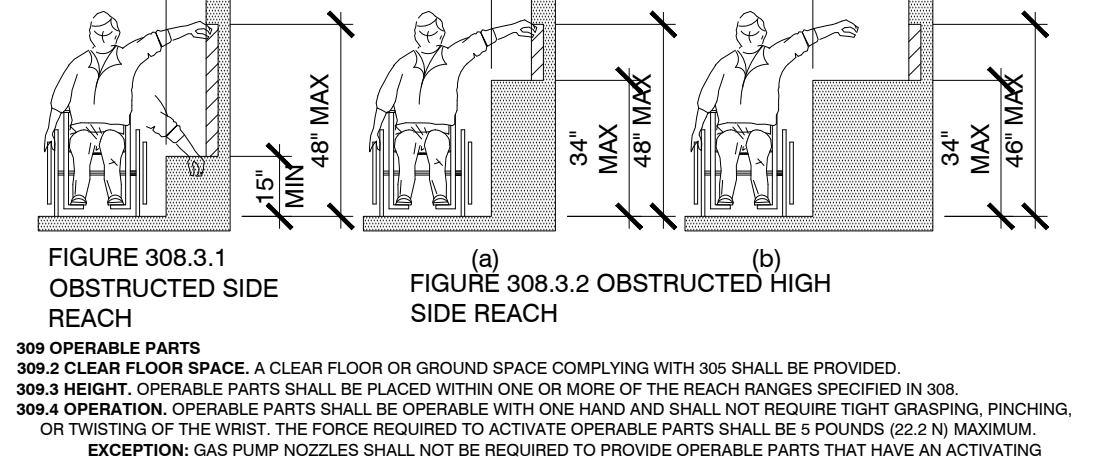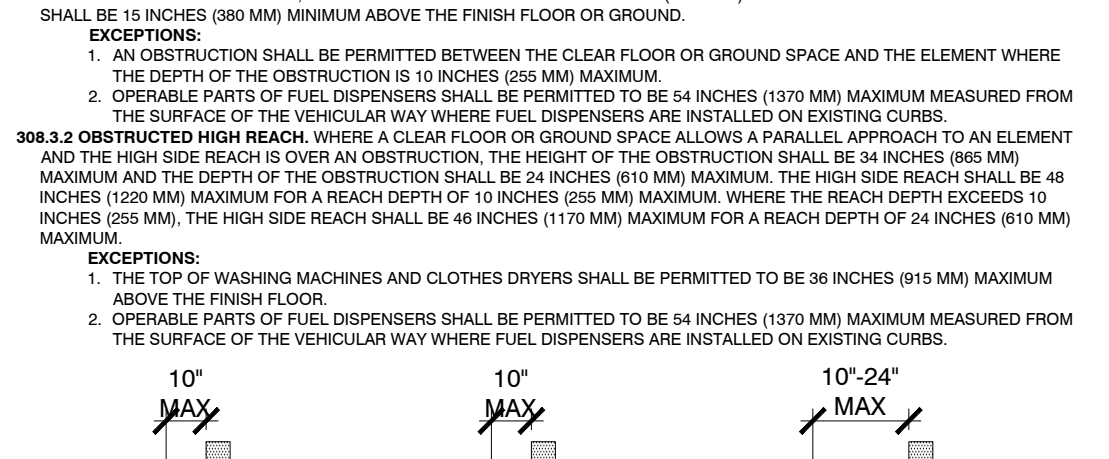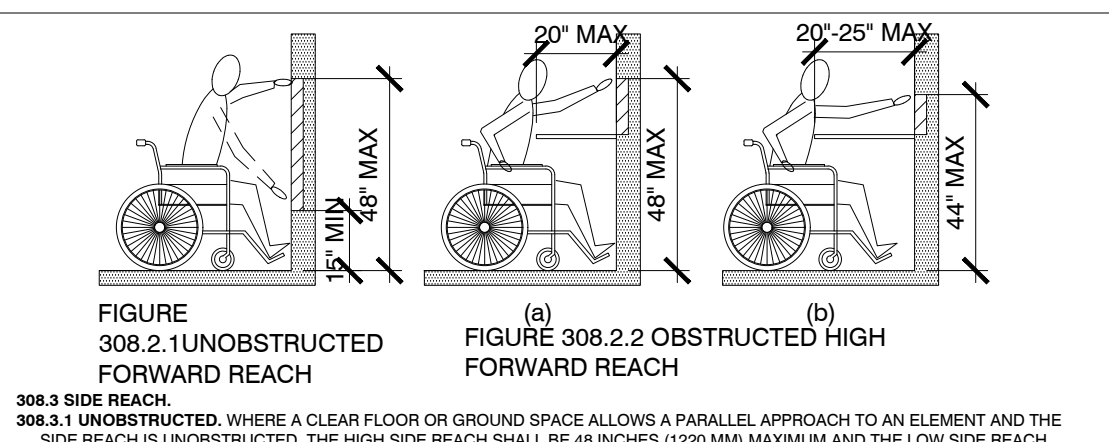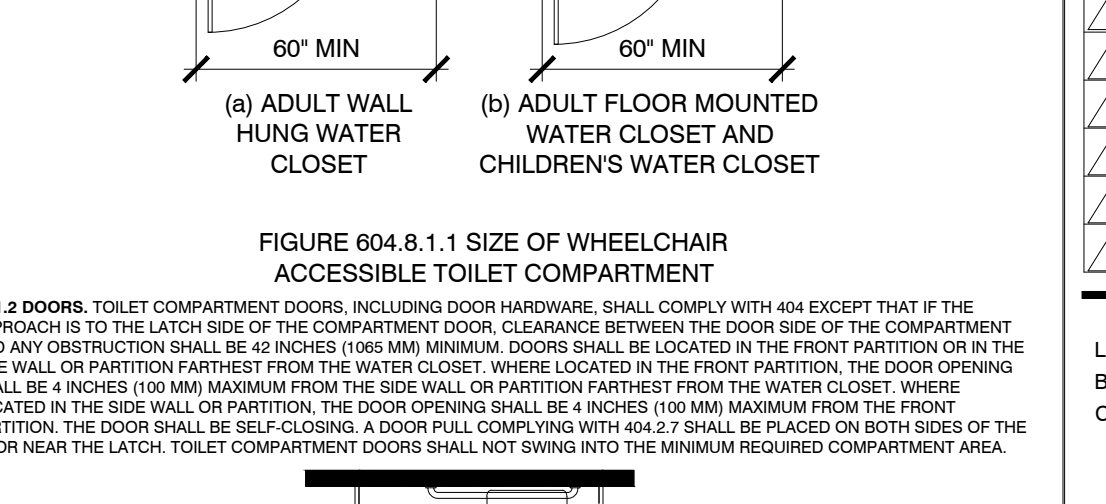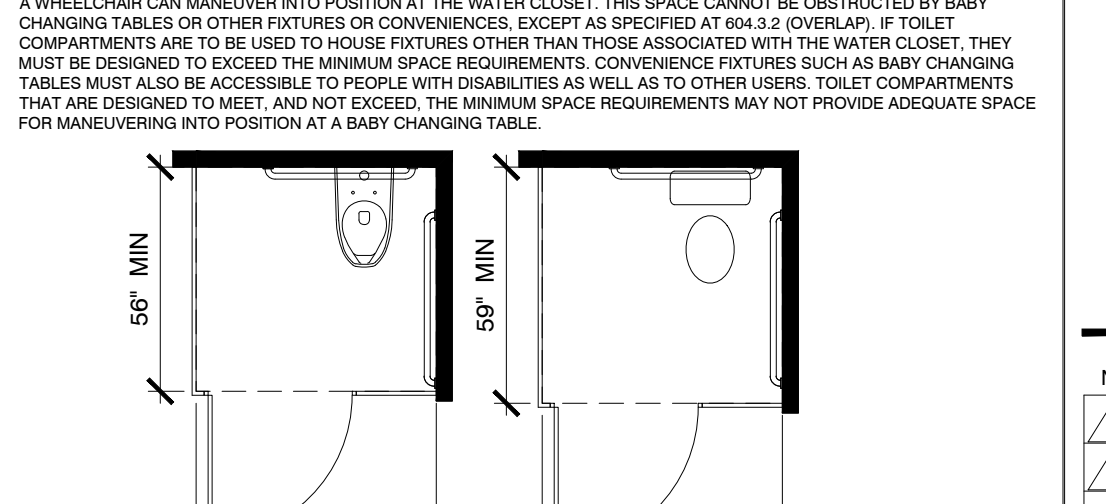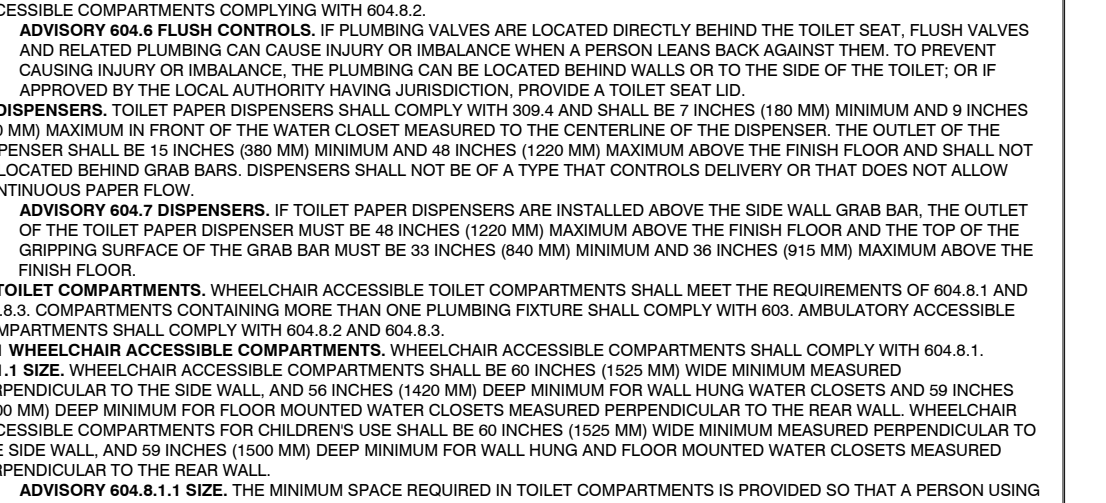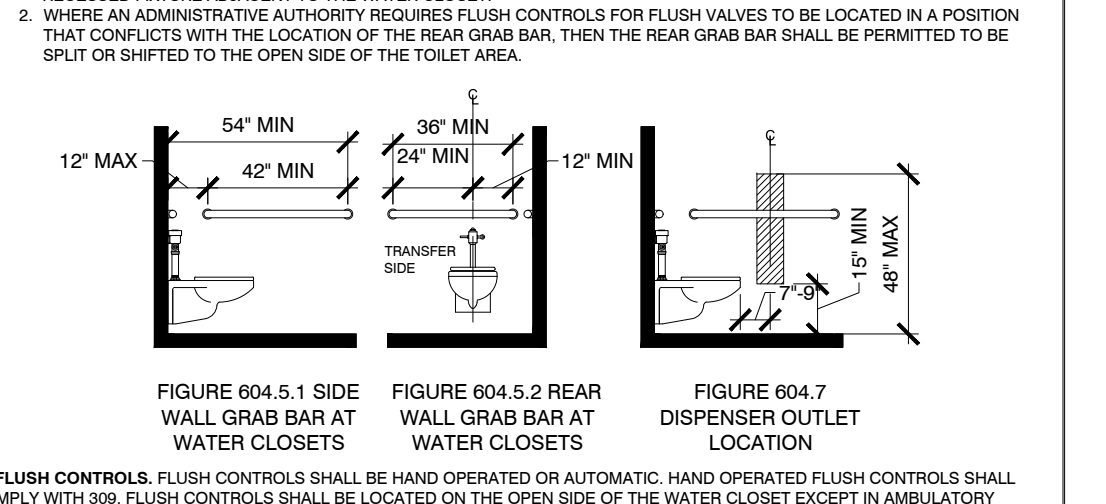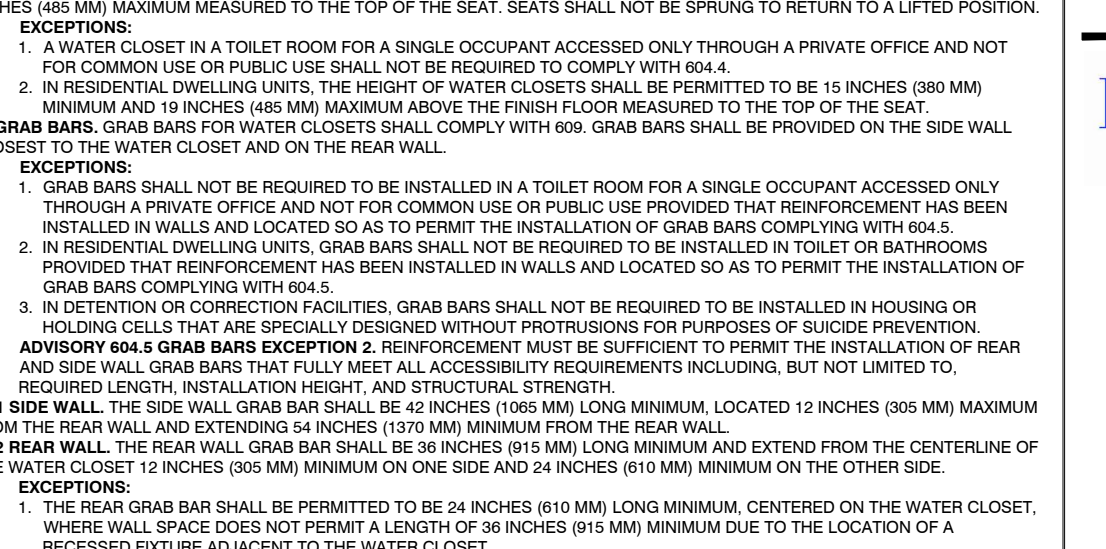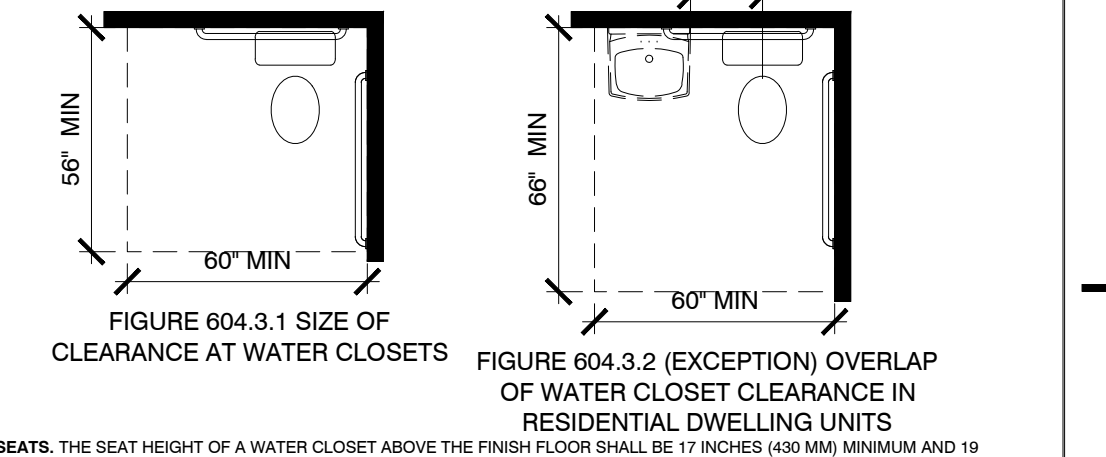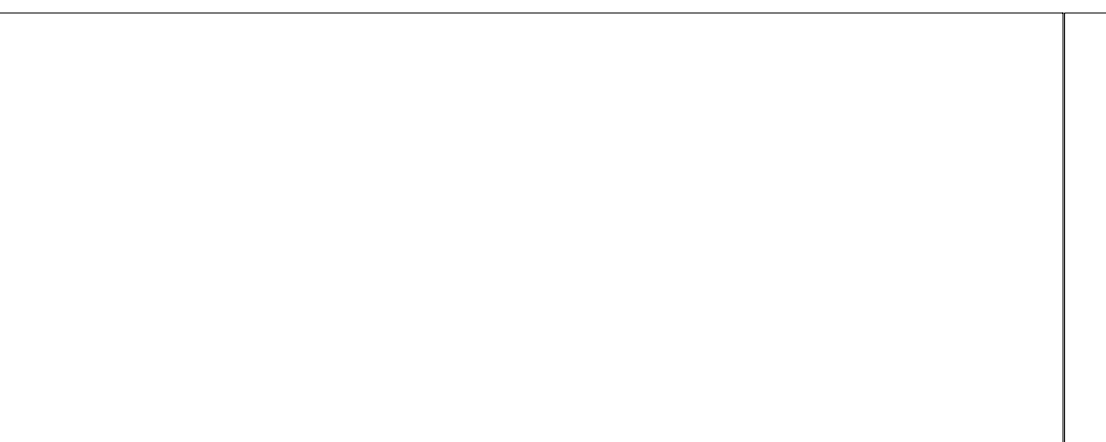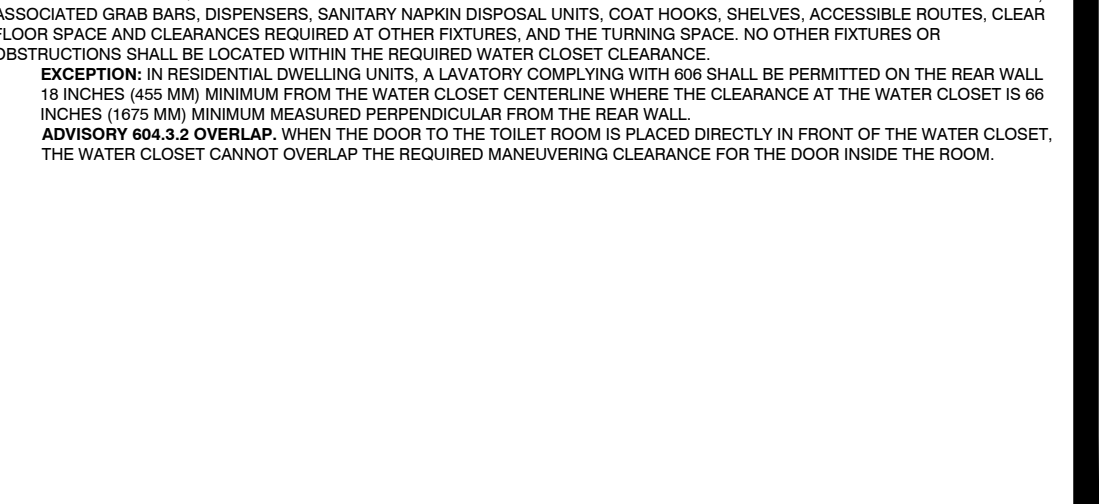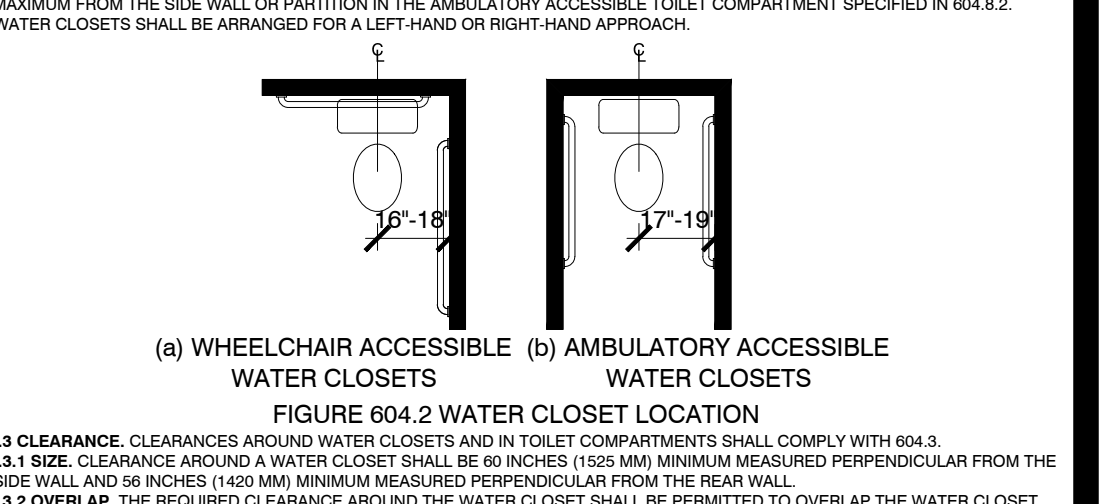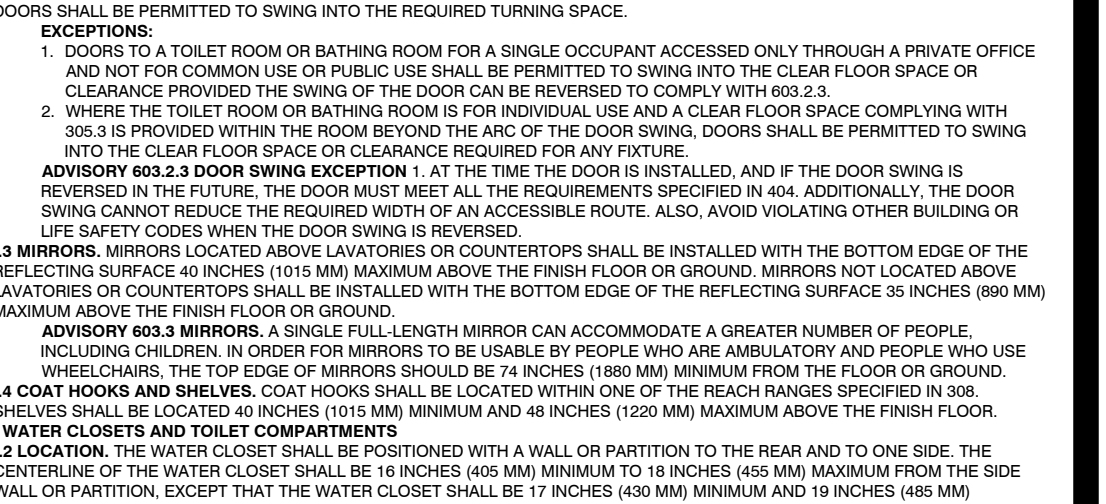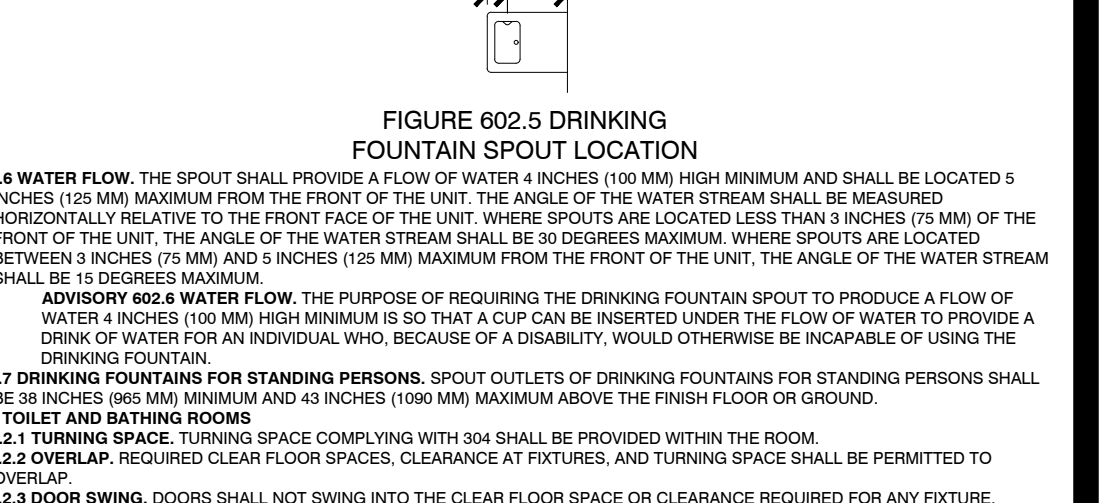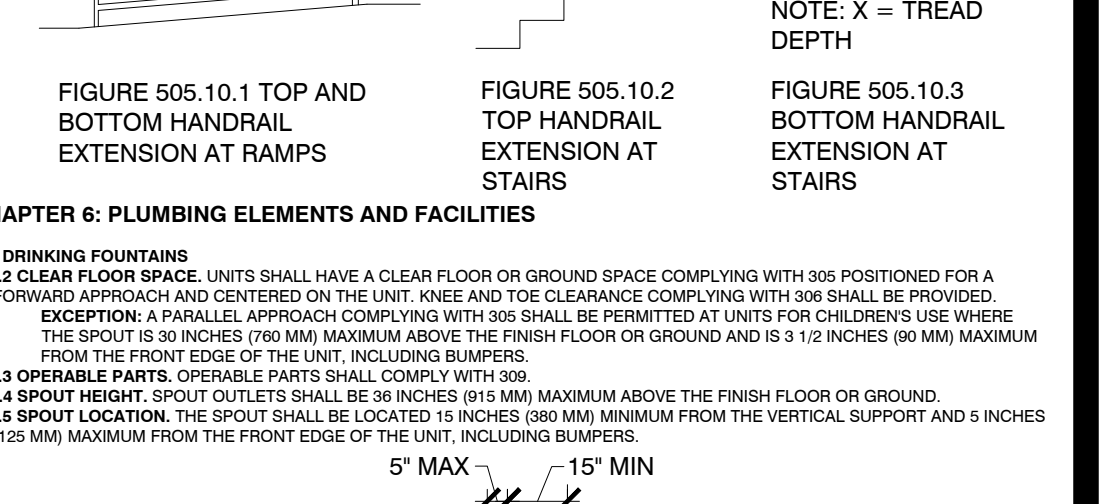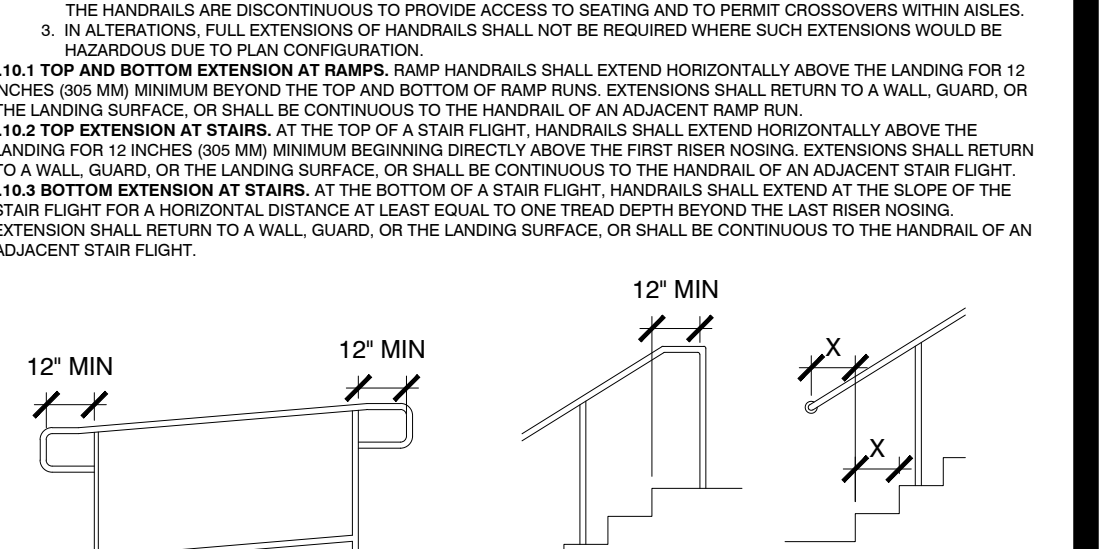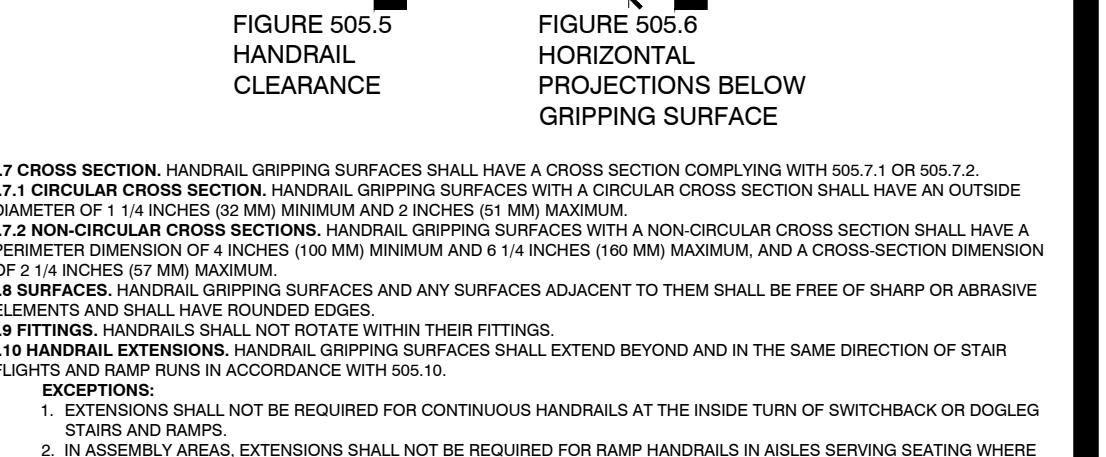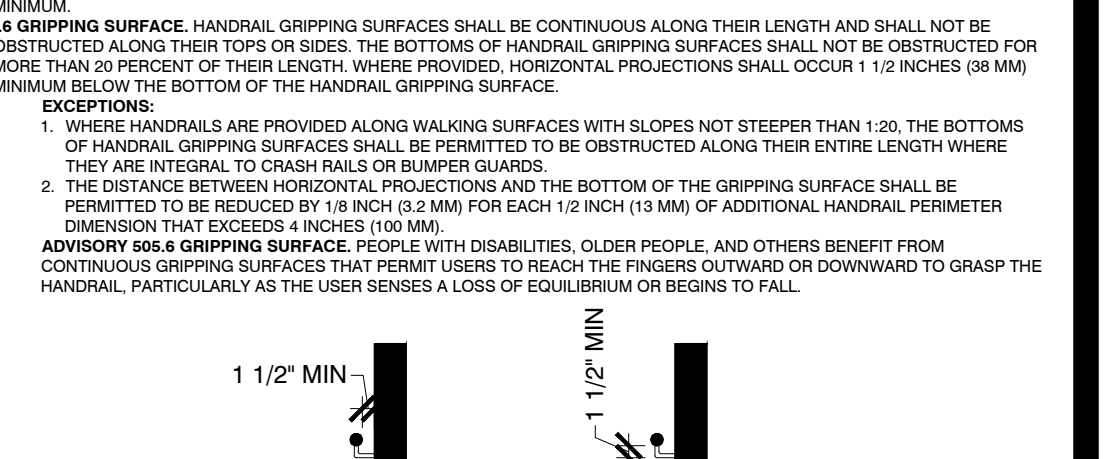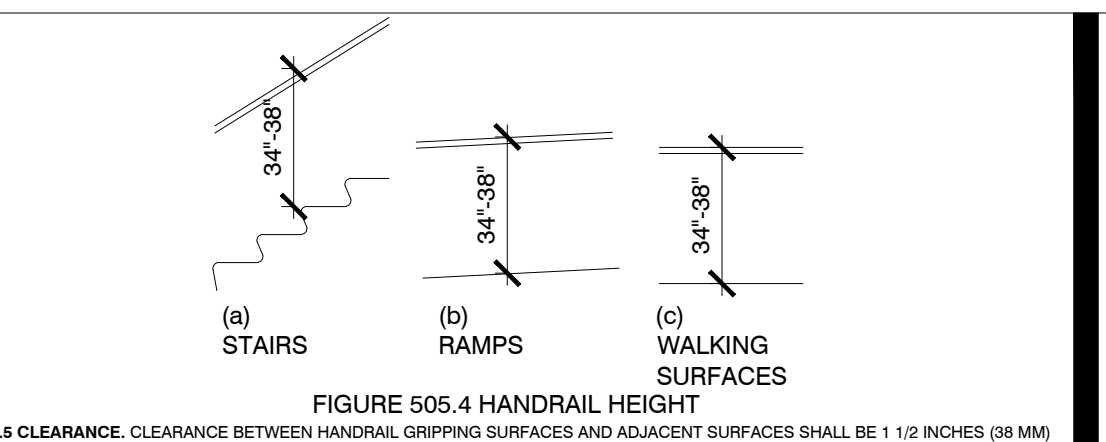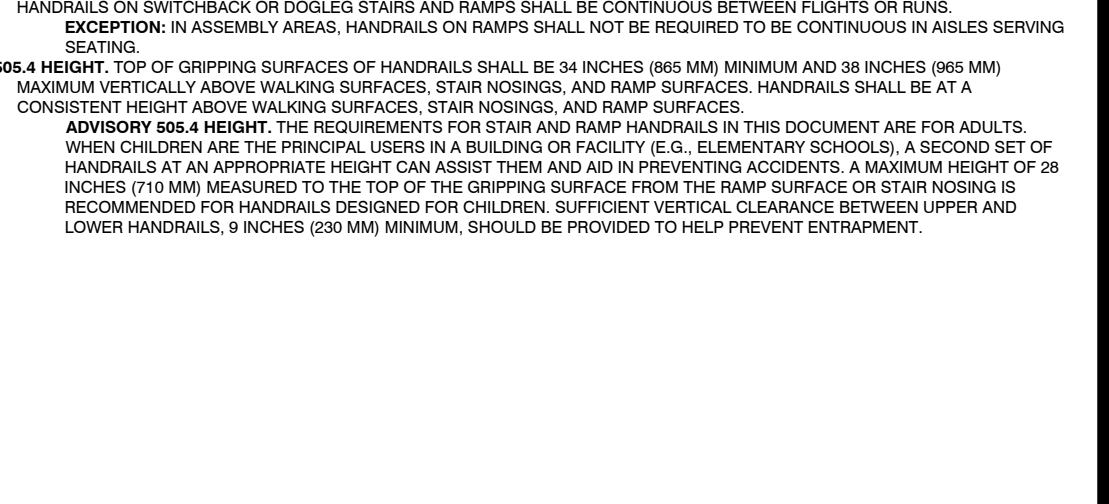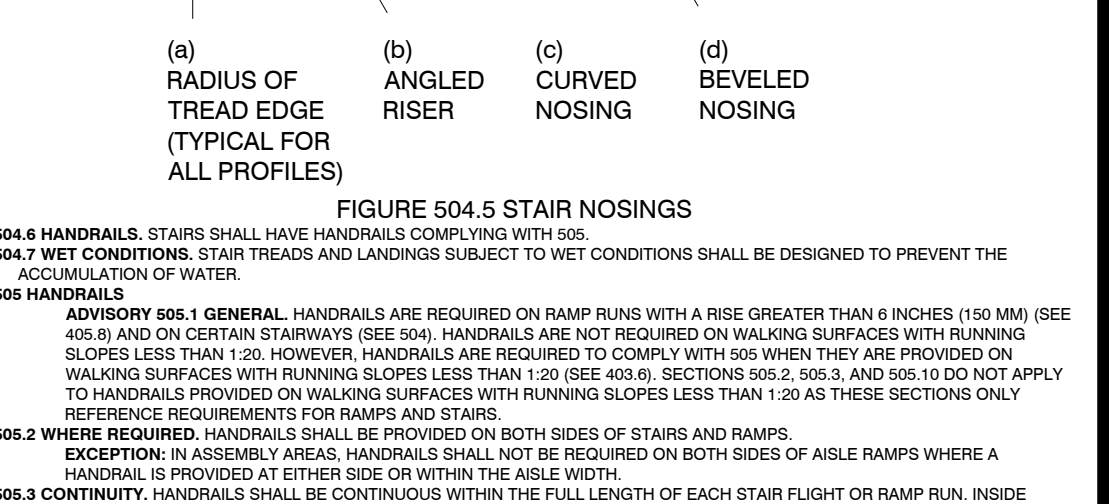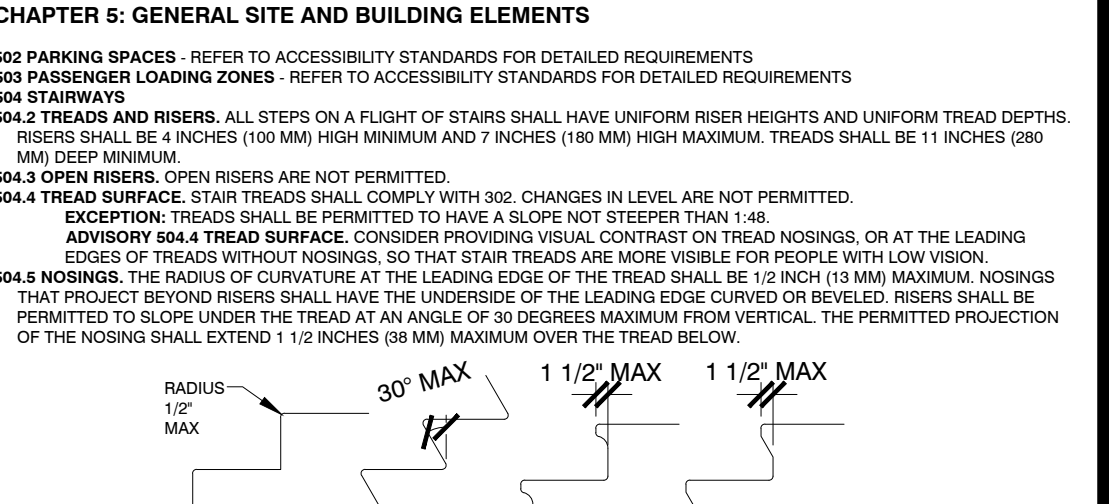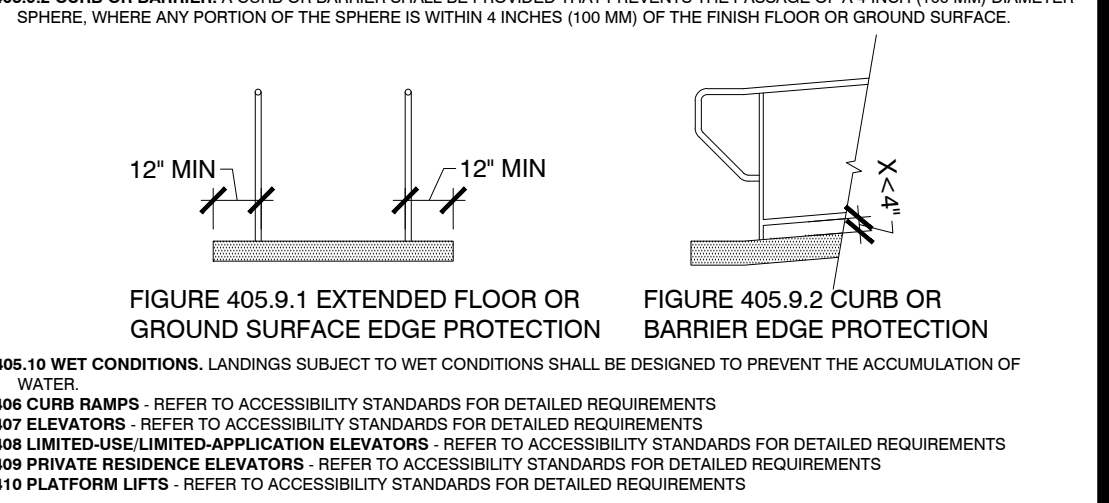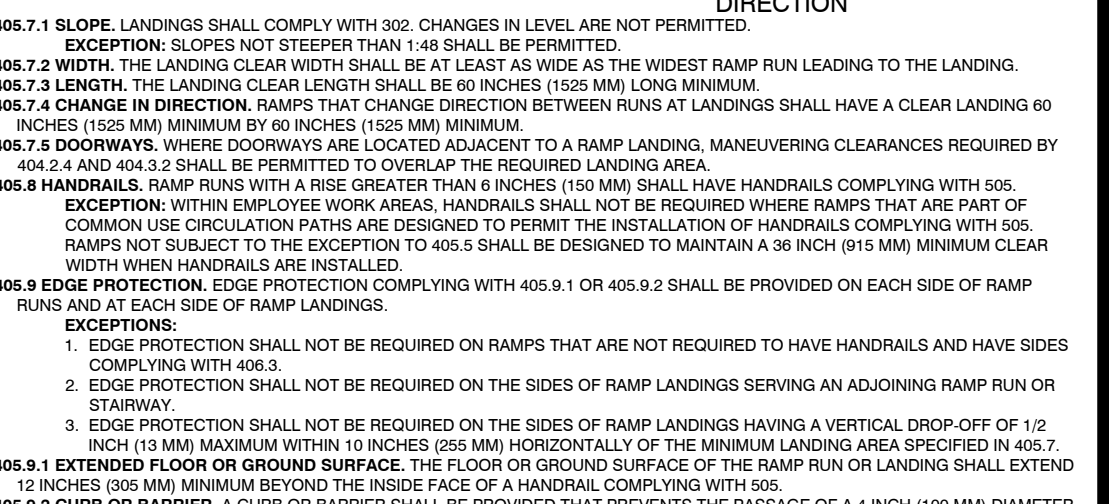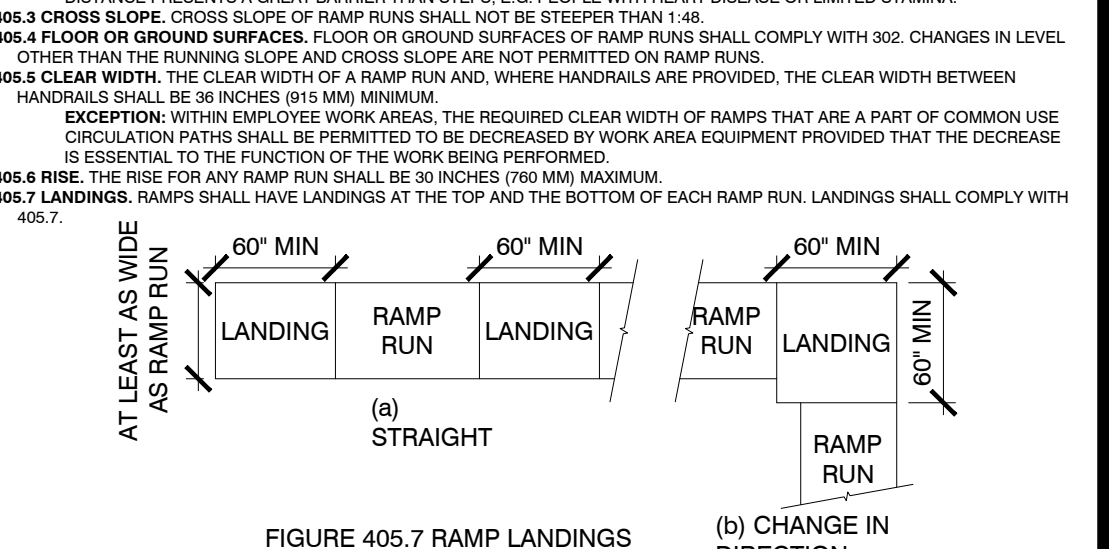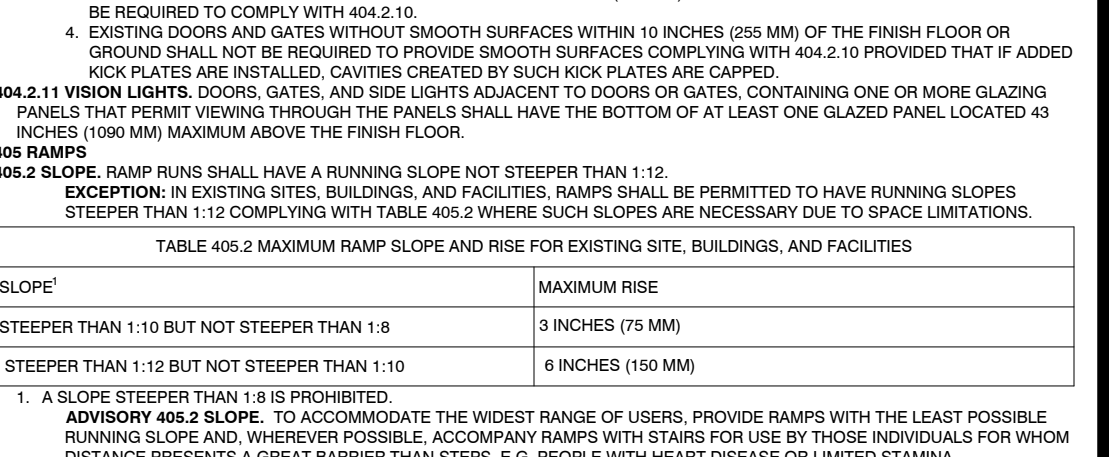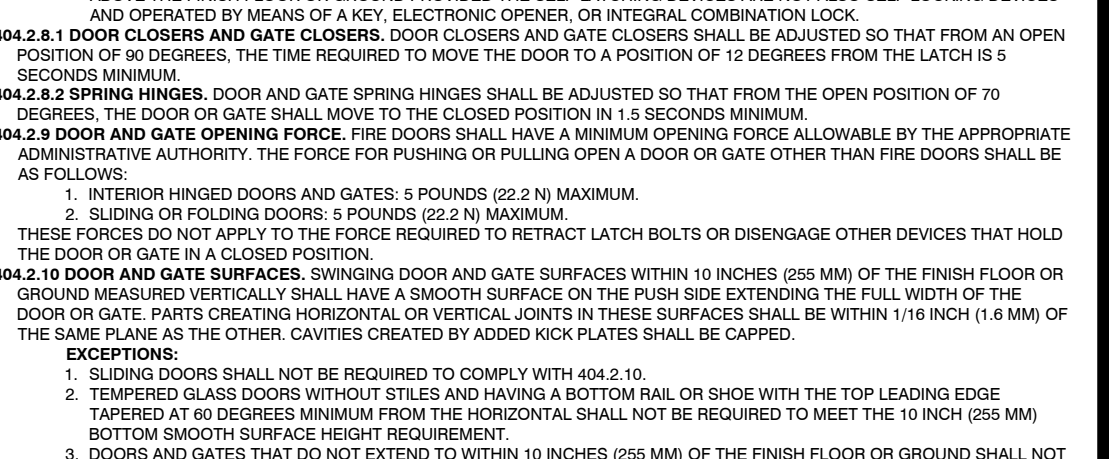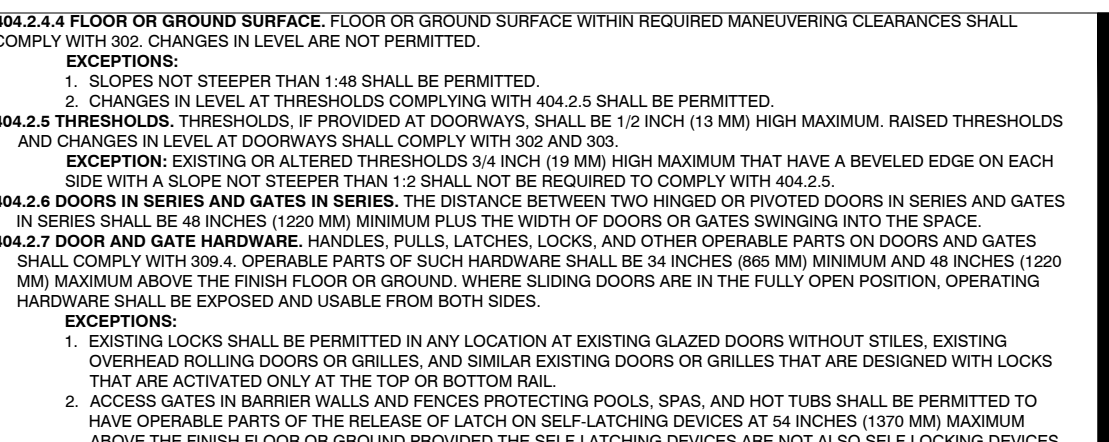

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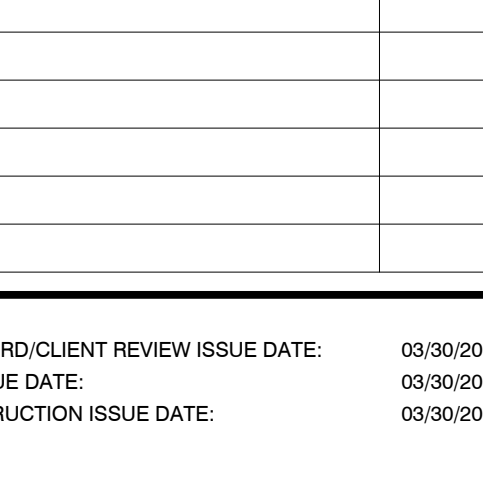
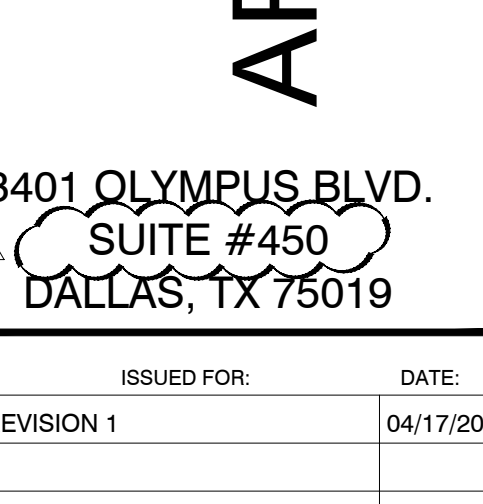


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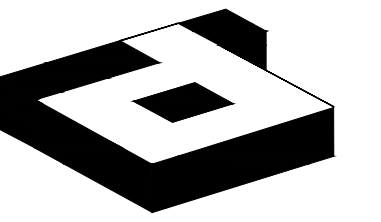
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Table with columns: NO., REVISION, ISSUED FOR, DATE. Row 1: REVISION 1, ISSUED FOR, DATE: 04/17/20




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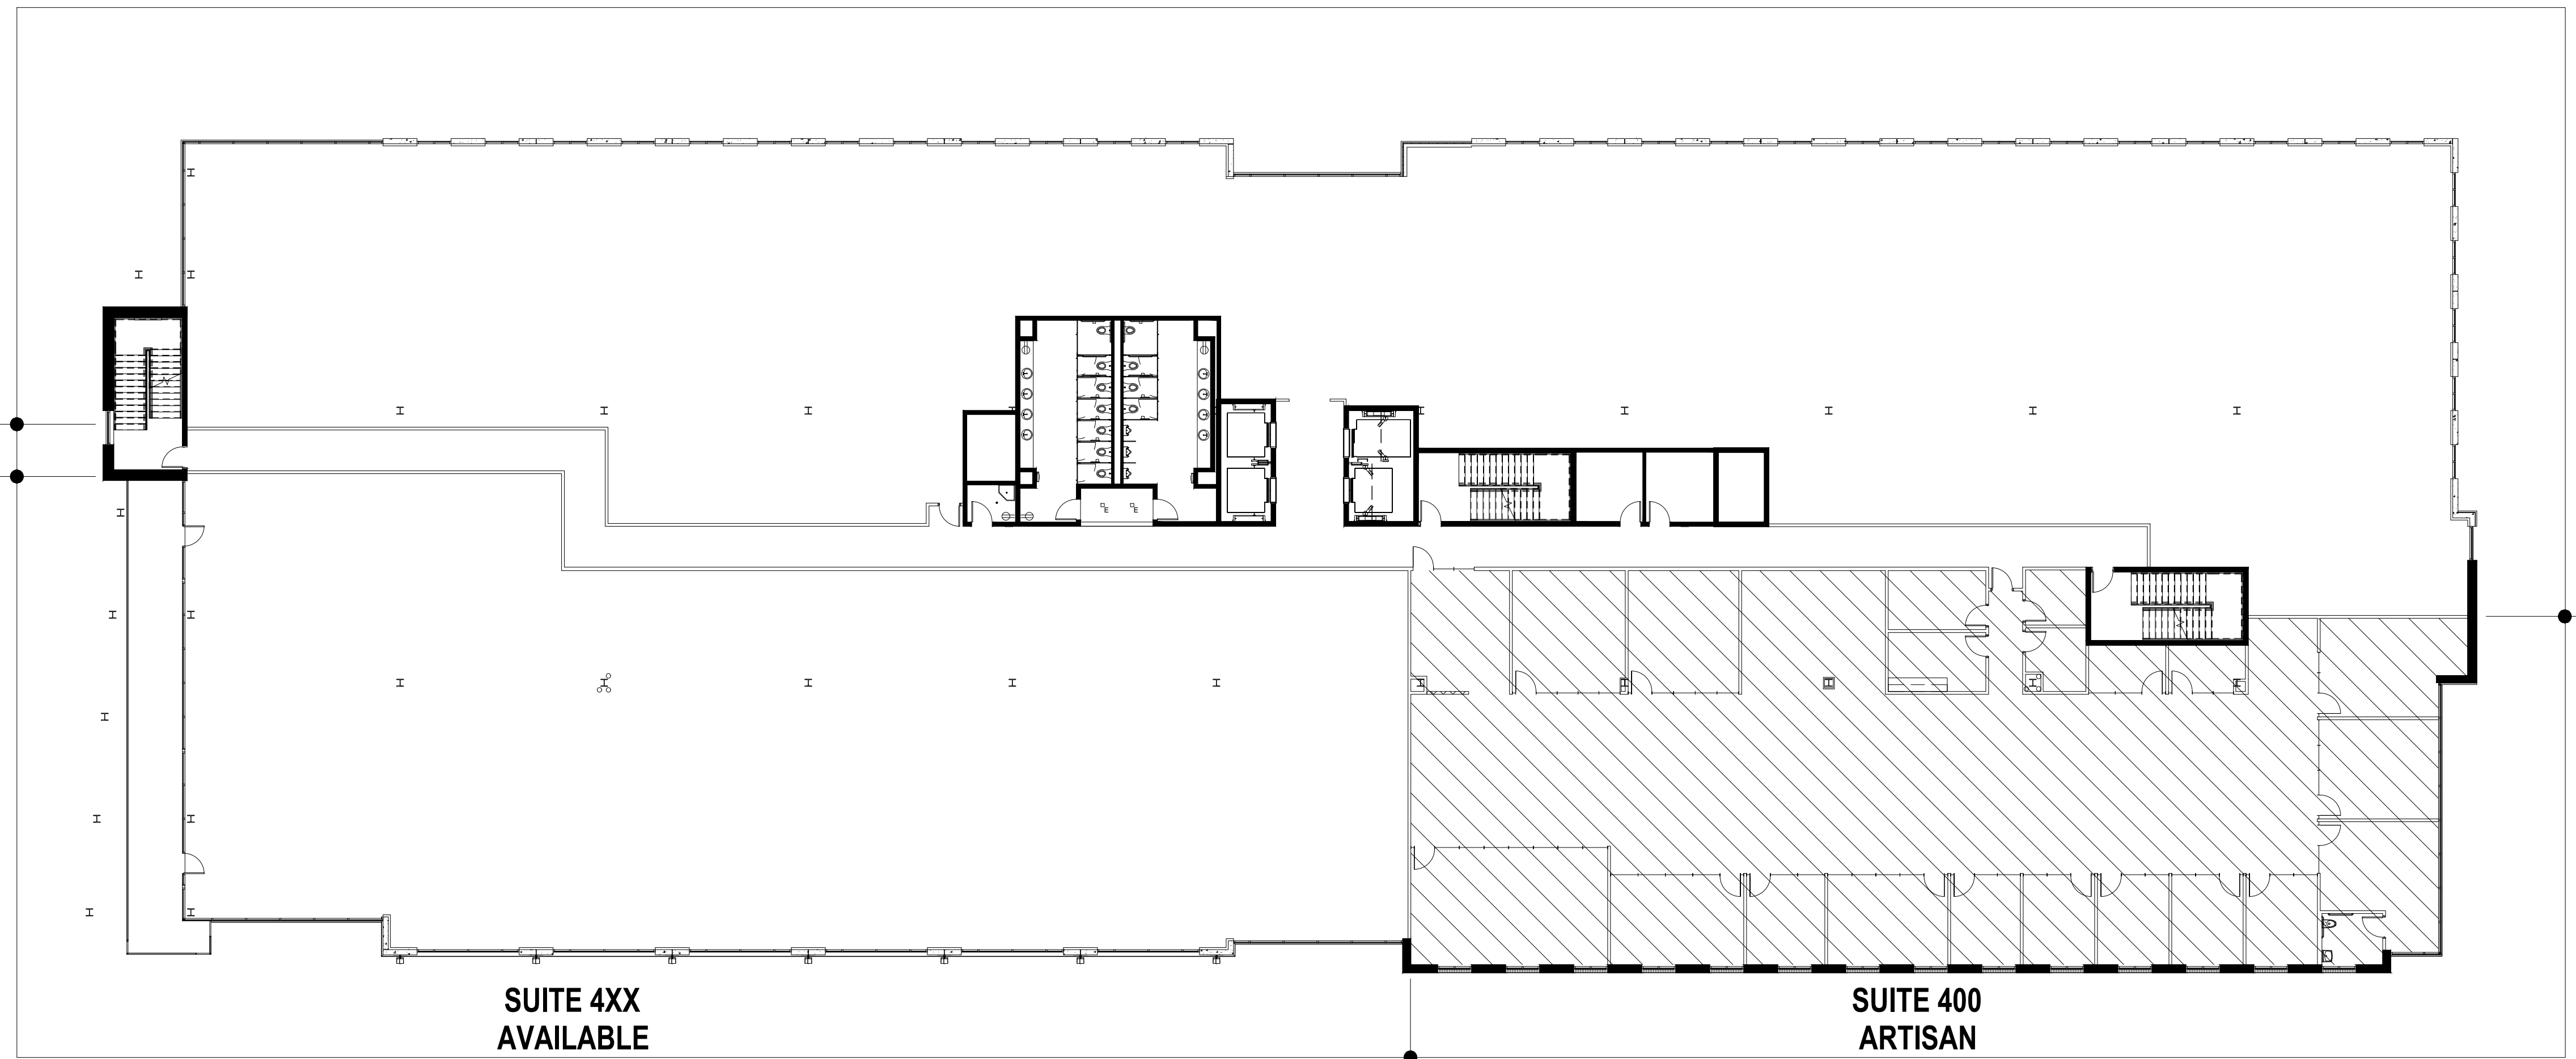
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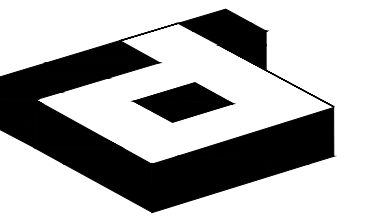


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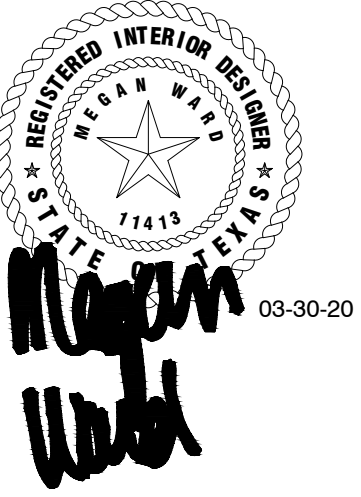


**01 KEY PLAN**  
SCALE: 1/16" = 1'-0"



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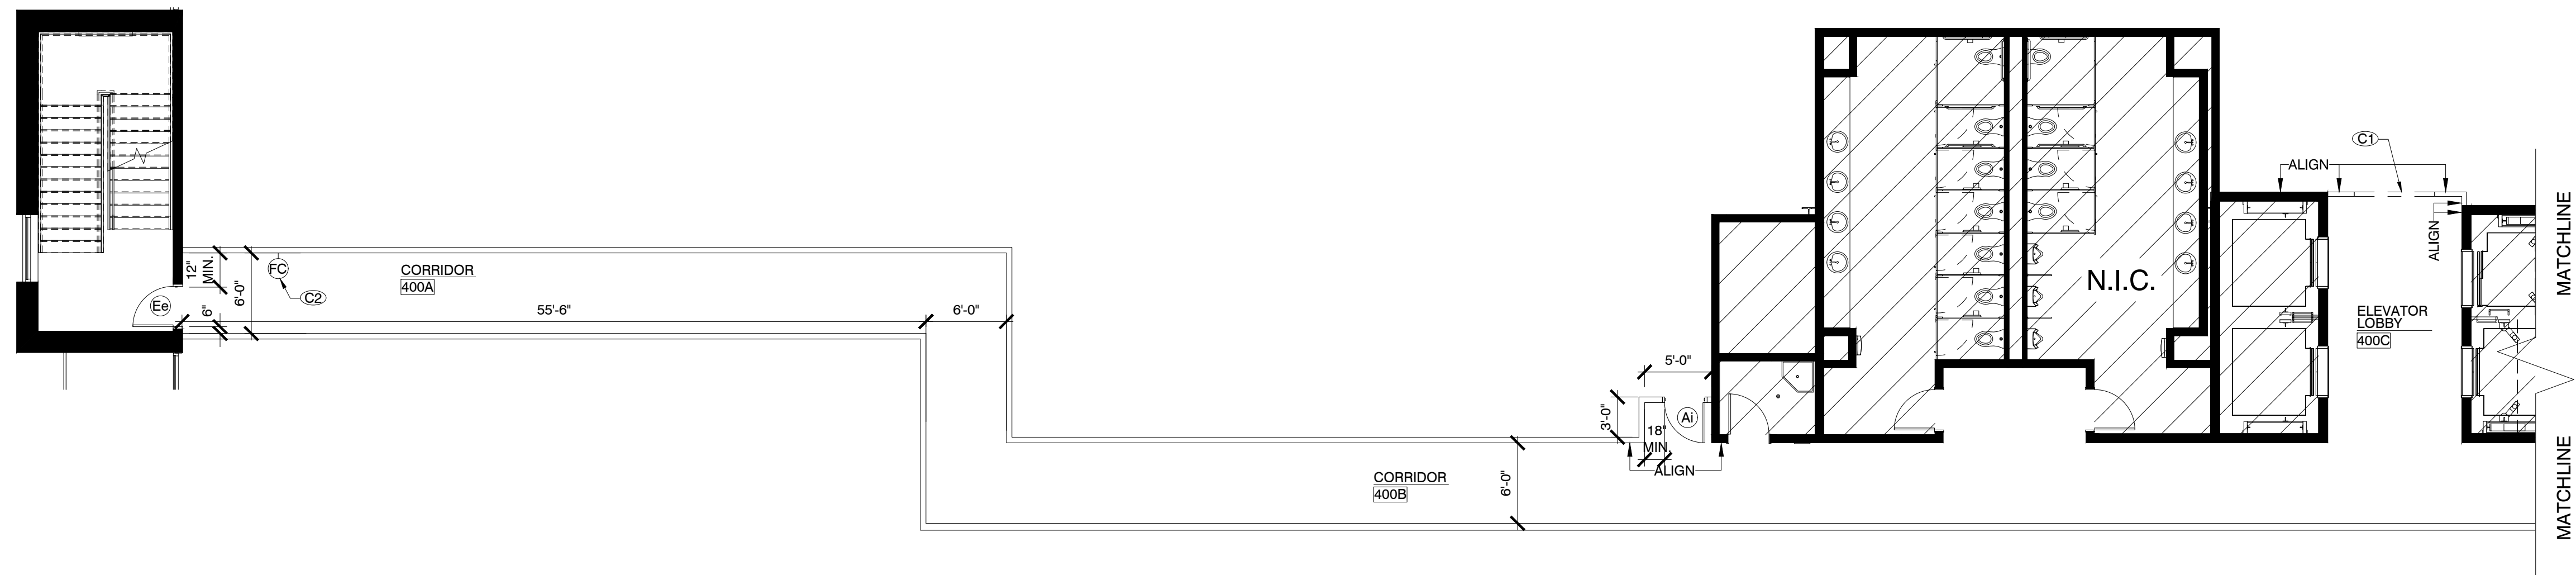
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**CONSTRUCTION PLAN**

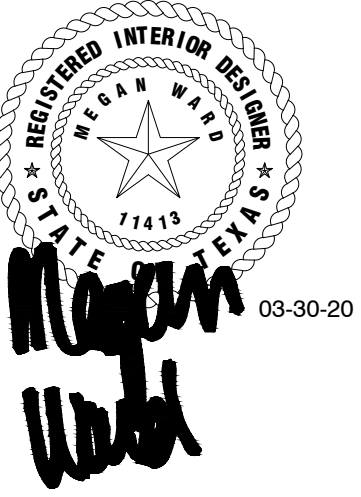DRAWING NUMBER:

**A2.0W**

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# 01 CONSTRUCTION PLAN

SCALE: 1/8" = 1'-0"

### BILLINGSLEY CONSTRUCTION NOTES:

- KEYING UNDER GC CONTRACT BY A-1 LOCKSMITHS AT INTERNATIONAL BUSINESS PARK AND BY WAYFAIR LOCKSMITH AT CYPRESS WATERS.
- SPECIFICATIONS FOR DOORS AND FRAMES:
  - DOOR FRAMES: RACO "CLASSIC PRESTIGE," OR APPROVED EQUAL, CLEAR ALUMINUM.
  - DOORS: 3'-0" X 9'-0" X 1-3/4" FIVE PLY SOLID CORE, FLUSH SLAB STAINED VENEER, WHITE OAK. STAIN FINISH: TBD OR MATCH EXISTING. VERIFY WITH LANDLORD FOR EXACT SPECIFICATIONS.
  - MORTISE SETS: SARGENT 8100 SERIES, LNH LEVER TRIM US26, POLISHED CHROME.
  - KEY: YALE GC KEYWAY.
  - HINGES: HAGER, MCKINNEY, OR STANLEY 4-1/2" X 4-1/2", 5-KNUCKLE, NON REMOVABLE PIN AT CORRIDORS.
  - 4-1/2" X 4-1/2", 5-KNUCKLE, NON-RISING PIN AT CORRIDORS. US26, POLISHED CHROME.
  - CLOSER: YALE TO MATCH EXISTING.
  - STOPS: FLOOR MOUNTED STOPS IN POLISHED OR SATIN STAINLESS STEEL.
- BCO TO PREFORM ASBESTOS REPORT.


### CONSTRUCTION NOTES:

- BULLETED NOTES ARE GENERAL CONDITIONS REQUIRED FOR THE PLAN. NUMBERED NOTATIONS REFERENCE SPECIFIC LOCATIONS ON THE DRAWINGS.
- REFERENCE SHEET A7.0 FOR PARTITION AND DOOR TYPE INFORMATION.
- PROVIDE 6" CLEAR DIMENSION AT ALL DOOR RETURN LOCATIONS, U.N.O. ALL DOORS TO BE UNDERCUT 1/2". U.N.O. ALL DOOR CLOSERS TO BE ADJUSTED TO MEET ADA/TAS REQUIREMENTS.
- SEE BUILDING MANAGER FOR LIST OF BUILDING STANDARDS FOR SPECIFICATIONS OF TYPICAL PUBLIC CORRIDOR AND DEMISING PARTITIONS.

### CONSTRUCTION KEYNOTES:


- C1. LEAVE OUT OPENING IN WALL FOR 6'-0" X 9'-0" FRAMELESS GLASS DOUBLE ENTRY DOORS. DOORS WILL BE PART OF A SEPARATE TENANT SCOPE. VERIFY EXACT LOCATION AND SIZE WITH BUILDING MANAGEMENT.
- C2. PROVIDE AND INSTALL NEW SEMI-RECESSED FIRE EXTINGUISHER CABINET WITH FIRE EXTINGUISHER. SPEC: LARSEN'S ARCHITECTURAL SERIES AL2409-R3 VERTICAL DUO ROUNDED TRIM, CLEAR ANODIZED ALUMINUM, OR APPROVED EQUAL REFERENCE 07/A6.0. EXACT LOCATION TO BE VERIFIED WITH FIRE MARSHALL PRIOR TO INSTALLATION.

CONSTRUCTION PLAN LEGEND	
SYMBOL	DESCRIPTION
NAME 0000	ROOM NAME/NUMBER
—	EXISTING PARTITION TO REMAIN
—	NEW DRYWALL PARTITION
-----	EXISTING LOW PARTITION, U.N.O.
-----	NEW LOW PARTITION, U.N.O.
=====	FRAMED GLAZING, U.N.O.
-----	FRAMELESS GLAZING, U.N.O.
Xx	DOOR AND FRAME WITH DOOR TYPE/HARDWARE SYMBOL
X	WALL TYPE SYMBOL
—	WATERLINE WITH SHUT OFF VALVE, U.N.O.
PB	EXISTING PHONE BOARD, U.N.O.
FC	SEMI RECESSED FIRE EXTINGUISHER CABINET, U.N.O.
X	NOTE REFERENCE
XXX.X	ELEVATION REFERENCE
XXX.X	DETAIL REFERENCE
XXX.X	SECTION REFERENCE
ALIGN	ALIGN TO FACE FINISH
X'-X'	DIMENSION TO INTERIOR FINISH FACE
X'-X' / CLR	CLEAR DIMENSION TO BE MAINTAINED
ALL SYMBOLS NOT NECESSARILY USED	

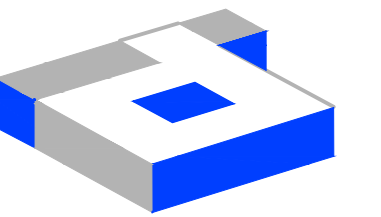

idGROUP

2641 IRVING BLVD.  
DALLAS, TEXAS 75207  
TEL: 214-638-6800 FAX: 214-689-0301

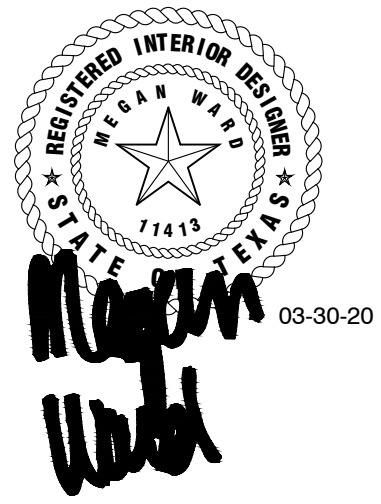

PROJECT NO.: 580-004  
DRAWN BY: RH  
CHECKED BY: MW  
TENANT R.S.F.: 9.452

**BILLINGSLEY**  
COMPANY

3401 OLYMPUS  
ARTISAN DESIGN GROUP

3401 OLYMPUS BLVD.  
SUITE #450  
DALLAS, TX 75019

NO.	ISSUED FOR:	DATE:
1	REVISION 1	04/17/20



LANDLORD/CLIENT REVIEW ISSUE DATE: 03/30/20  
BID ISSUE DATE: 03/30/20  
CONSTRUCTION ISSUE DATE: 03/30/20

DRAWING TITLE:  
**CONSTRUCTION PLAN**

DRAWING NUMBER:

**A2.0E**

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**01 CONSTRUCTION PLAN**  
SCALE: 1/8" = 1'-0"

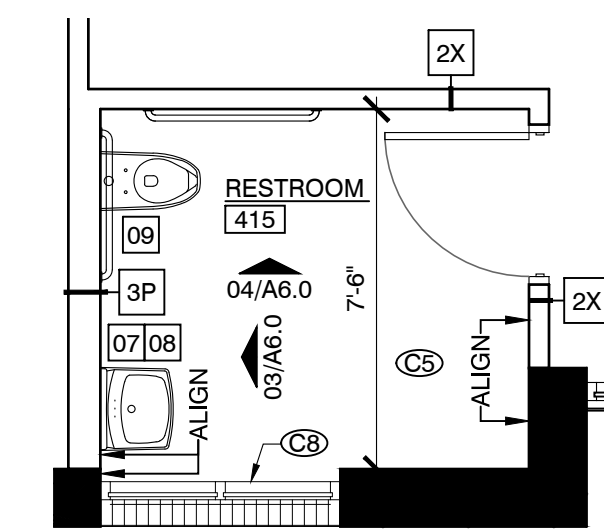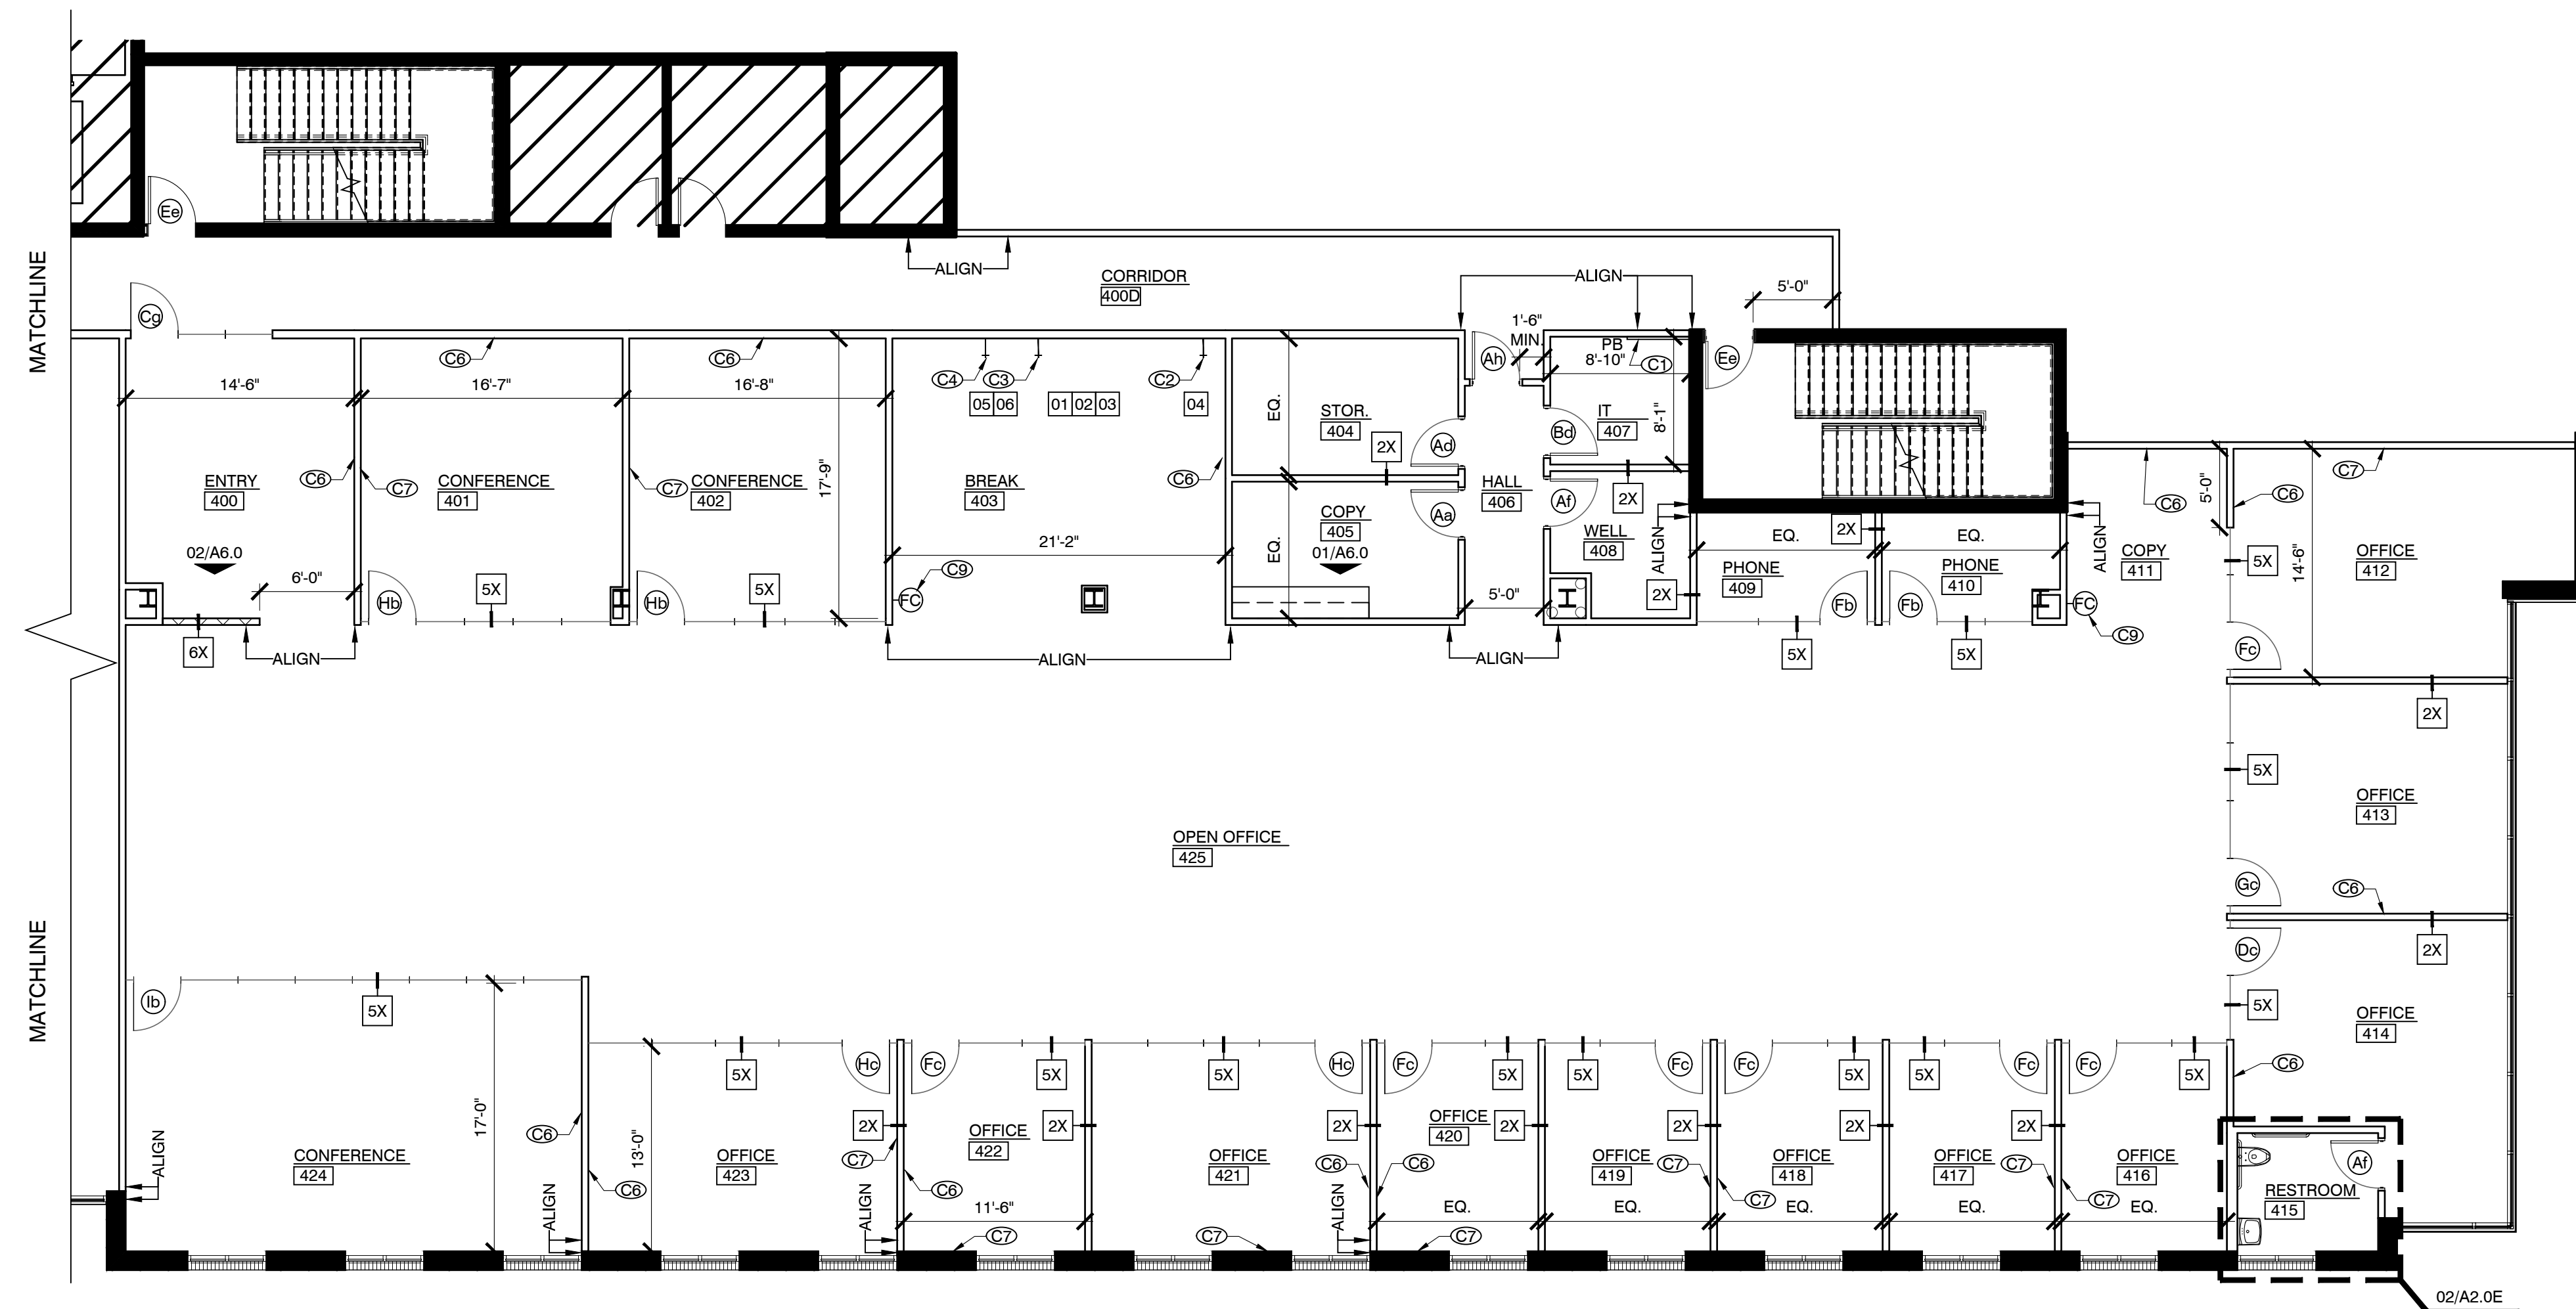**02 ENLARGED RESTROOM PLAN**  
SCALE: 1/8" = 1'-0"

**BILLINGSLEY CONSTRUCTION NOTES:**

- KEYING UNDER GC CONTRACT BY A-1 LOCKSMITHS AT INTERNATIONAL BUSINESS PARK AND BY WAYFAIR LOCKSMITH AT CYPRESS WATERS.
- SPECIFICATIONS FOR DOORS AND FRAMES:
  - DOOR FRAMES: RACO "CLASSIC PRESTIGE," OR APPROVED EQUAL, CLEAR ALUMINUM.
  - DOORS: 3'-0" X 9'-0" X 1-3/4" FIVE PLY SOLID CORE, FLUSH SLAB STAINED VENEER, WHITE OAK. STAIN FINISH: TBD OR MATCH EXISTING. VERIFY WITH LANDLORD FOR EXACT SPECIFICATIONS.
  - MORTISE SETS: SARGENT 8100 SERIES, LNH LEVER TRIM US26, POLISHED CHROME.
  - KEY: YALE GC KEYWAY.
  - HINGES: HAGER, MCKINNEY, OR STANLEY 4-1/2" X 4-1/2", 5-KNUCKLE, NON-REMOVABLE PIN AT CORRIDORS.
  - 4-1/2" X 4-1/2", 5-KNUCKLE, NON-RISING PIN AT CORRIDORS. US26, POLISHED CHROME.
  - CLOSER: YALE TO MATCH EXISTING.
  - STOPS: FLOOR MOUNTED STOPS IN POLISHED OR SATIN STAINLESS STEEL.
- BCO TO PREFORM ASBESTOS REPORT.
- EXTERIOR WINDOW TREATMENTS: MECHOSHADE, MANUAL ROLLER BY SOL PURCHASED BY TENANT THROUGH LANDLORD.

**CONSTRUCTION NOTES:**

- REFERENCE SHEET A7.0 FOR PARTITION AND DOOR TYPE INFORMATION.
- PROVIDE 6" CLEAR DIMENSION AT ALL DOOR RETURN LOCATIONS. U.N.O. ALL DOORS TO BE UNDERCUT 3". U.N.O. ALL DOOR CLOSERS TO BE ADJUSTED TO MEET ADA/TAS REQUIREMENTS.
- CENTER NEW PARTITIONS AT EXTERIOR MULLIONS, U.N.O.
- PROVIDE AND INSTALL PLUMBING FIXTURES AND APPLIANCES AS INDICATED ON PLAN. REFERENCE PLUMBING AND APPLIANCE SCHEDULES.
- SEE BUILDING MANAGER FOR LIST OF BUILDING STANDARDS FOR SPECIFICATIONS OF TYPICAL PUBLIC CORRIDOR AND DEMISING PARTITIONS.
- PROVIDE COPOLYMER STRIPS AT ALL BUTT-JOINT GLASS SEAMS.
- PROVIDE MINIMAL FURRING AT ALL EXPOSED COLUMNS THROUGHOUT.

**CONSTRUCTION KEYNOTES:**

- C1. PROVIDE 4'-0" X 4'-0", 3/4" FIRE RATED PLYWOOD PHONE BOARD MOUNTED HORIZONTALLY TIGHT TO CEILING. PAINT TO MATCH ADJACENT WALL. DO NOT PAINT OVER FIRE RATING LABEL.
- C2. PROVIDE 3/4" COLD WATER LINE FOR REFRIGERATOR. COORDINATE EXACT LOCATION WITH TENANT PROVIDED MILLWORK.
- C3. PROVIDE 3/4" COLD WATER LINE FOR ICE MAKER. COORDINATE EXACT LOCATION WITH TENANT PROVIDED MILLWORK.
- C4. PROVIDE 3/4" COPPER WATER LINE FOR TENANT SUPPLIED COFFEE SERVICE. COORDINATE EXACT LOCATION WITH TENANT PROVIDED MILLWORK.
- C5. PROVIDE REQUIRED SLOPE IN FLOOR AND FLOOR DRAIN AT RESTROOM, AS REQUIRED.
- C6. PROVIDE BLOCKING IN WALL FOR TENANT PROVIDED TELEVISION. VERIFY EXACT LOCATION AND HEIGHT WITH TENANT.
- C7. PROVIDE BLOCKING IN WALL FOR GLASS BOARDS. VERIFY EXACT LOCATION AND HEIGHT WITH TENANT. SPECIFICATION: XXX
- C8. PROVIDE VINYL FILM AT EXTERIOR WINDOW AT RESTROOM 414. COORDINATE EXACT SPECIFICATION WITH BUILDING MANAGEMENT.
- C9. PROVIDE AND INSTALL NEW SEMI-RECESSED FIRE EXTINGUISHER CABINET WITH FIRE EXTINGUISHER. SPEC: LARSEN'S ARCHITECTURAL SERIES AL2408-R3 VERTICAL D/O D ROUNDED TRIM. CLEAR ANODIZED ALUMINUM, OR APPROVED EQUAL REFERENCE 07/A6.0.


PLUMBING SCHEDULE					
KEY:	XX	ITEM	MRF.	MODEL	COLOR/FIN. DESCRIPTION
01		SINGLE SINK	ELKAY	ELUHAD211555 LUSTERSTONE	STAINLESS STEEL UNDER MOUNT SINK WITH PERFECT DRAIN 23.5" X 18.25" X 5.3/8" COORDINATE INSTALLATION WITH TENANT PROVIDED MILLWORK
02		FAUCET	AMERICAN STANDARD	EDGEWATER 4932.410	STAINLESS STEEL SINGLE HOLE, PULL DOWN FAUCET COORDINATE INSTALLATION WITH TENANT PROVIDED MILLWORK
03		WATER HEATER	BUILDING STANDARD		UNDERCOUNTER, TANK-TYPE. SIZED TO MATCH USE.

APPLIANCE SCHEDULE					
KEY:	XX	ITEM	MRF.	MODEL	COLOR/FIN. DESCRIPTION
04		REFRIGERATOR	GENERAL ELECTRIC	GSS25GSHSS	STAINLESS STEEL FULL-HEIGHT, SIDE-BY-SIDE, 69-1/2"H X 35-1/4"D X 35-3/4"W
05		ICEMAKER	HOSHIZAKI	C-80BAJ-AD	STAINLESS STEEL UNDERCOUNTER, REQUIRES 1/4" COLD WATER LINE & DRAIN. 31-1/2"H X 14-7/8"W X 22-5/8"D COORDINATE INSTALLATION WITH TENANT PROVIDED MILLWORK
06		MICROWAVE	GE PROFILE SERIES	PES7227SLSS	STAINLESS STEEL TENANT PROVIDED 22 CU. FT. COUNTERTOP SENSOR MICROWAVE, 24" X 13-1/2" X 18-1/2" COORDINATE INSTALLATION WITH TENANT PROVIDED MILLWORK

RESTROOM PLUMBING SCHEDULE					
KEY:	XX	ITEM	MRF.	MODEL	COLOR/FIN. DESCRIPTION
07		LAVATORY	AMERICAN STANDARD	MURRO 0958.008EC SHROUD0059.02 OEC	WHITE WALL-MOUNT SINK W/SHROUD, FAUCET HOLES ON 8" CENTERS, VITREOUS CHINA
08		LAVATORY FAUCET	AMERICAN STANDARD	MONTERREY 6409.171	POLISHED CHROME TOP MOUNT, 8" CENTERSET GOOSENECK, WRIST BLADE HANDLES
09		TOILET	AMERICAN STANDARD	MADERA 2854.528	WHITE 1.28 GPF FLOOR-MOUNTED, ELONGATED BOWL, PRESSURE ASSISTED FLUSH VALVE, TOP SPUD, EVERCLEAN


**CONSTRUCTION PLAN LEGEND**

SYMBOL	DESCRIPTION
NAME 000	ROOM NAME/NUMBER
—	EXISTING PARTITION TO REMAIN
—	NEW DRYWALL PARTITION
—	EXISTING LOW PARTITION, U.N.O.
—	NEW LOW PARTITION, U.N.O.
—	FRAMED GLAZING, U.N.O.
—	FRAMELESS GLAZING, U.N.O.
⊗	DOOR AND FRAME WITH DOOR TYPE/HARDWARE SYMBOL
X	WALL TYPE SYMBOL
→	WATERLINE WITH SHUT OFF VALVE, U.N.O.
—PB	EXISTING PHONE BOARD, U.N.O.
⊖	SEMI RECESSED FIRE EXTINGUISHER CABINET, U.N.O.
⊗	NOTE REFERENCE
X/XXX	ELEVATION REFERENCE
X/XXX	DETAIL REFERENCE
X/XXX	SECTION REFERENCE
↑ALIGN	ALIGN TO FACE FINISH
↑X-X	DIMENSION TO INTERIOR FINISH FACE
↑X-X CLR	CLEAR DIMENSION TO BE MAINTAINED
ALL SYMBOLS NOT NECESSARILY USED	

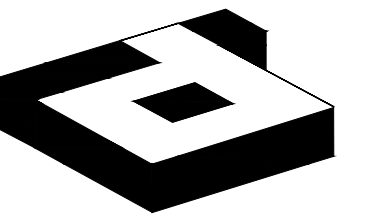

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TEL: 214-638-6800 FAX: 214-689-0301

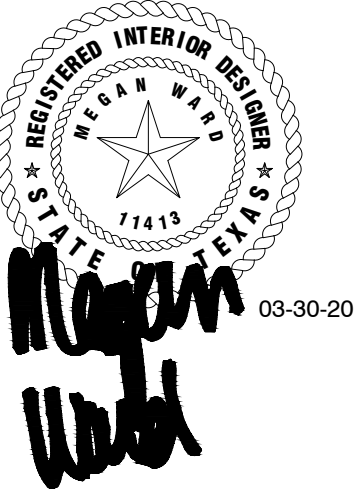

PROJECT NO.: 580-004  
DRAWN BY: RH  
CHECKED BY: MW  
TENANT R.S.F.: 9,452

**BILLINGSLEY**  
COMPANY

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ARTISAN DESIGN GROUP

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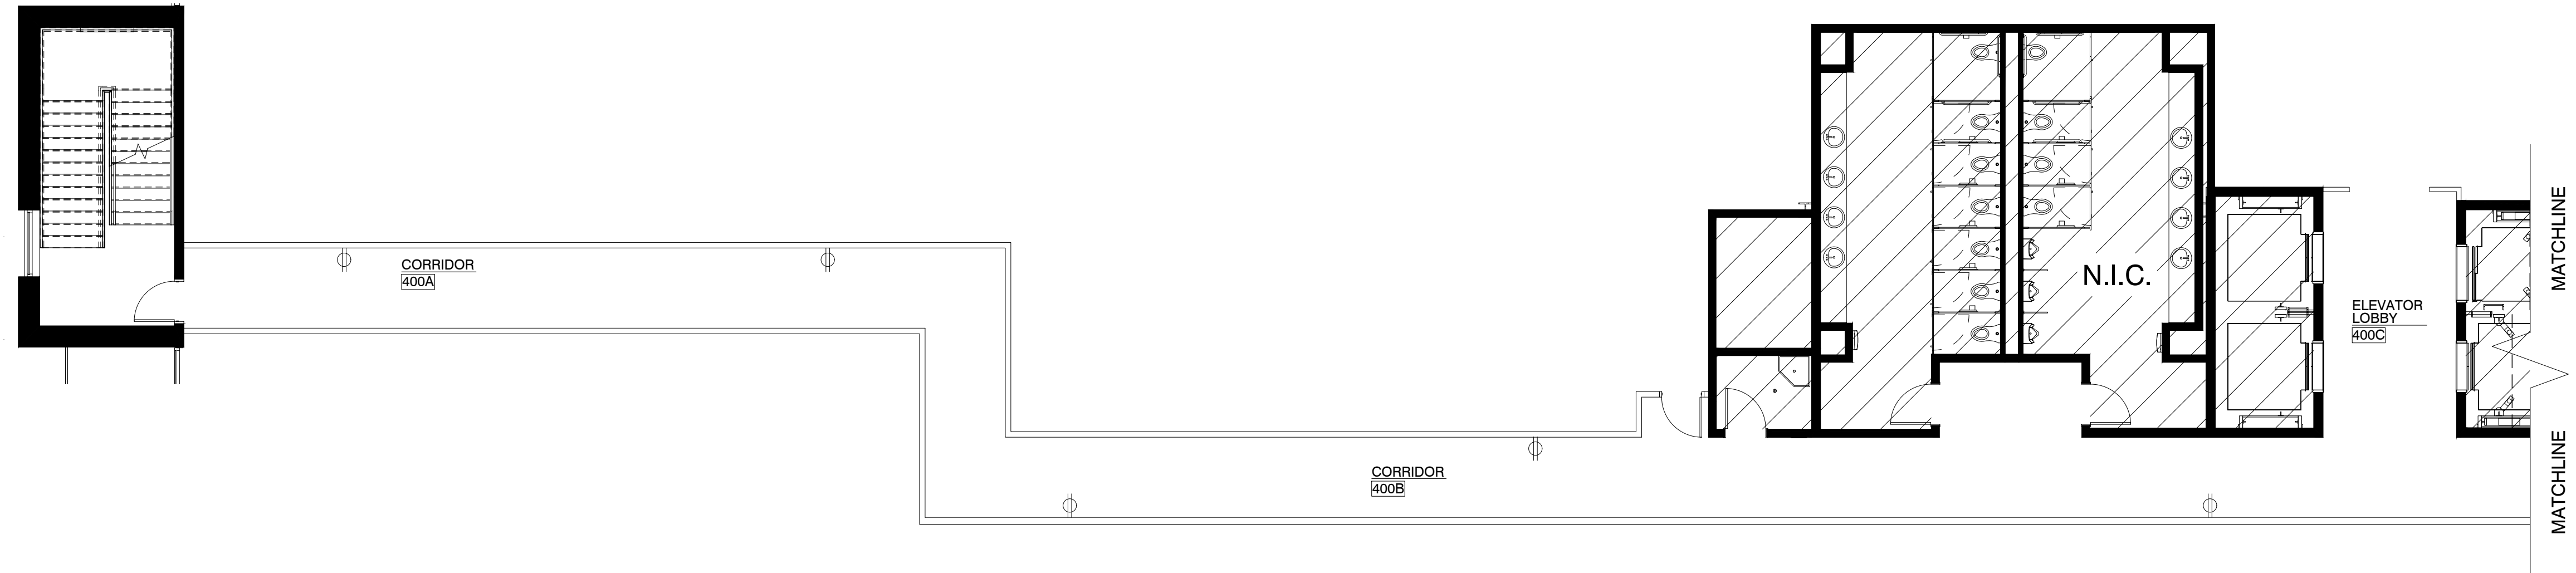
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**POWER & COMMUNICATION PLAN**


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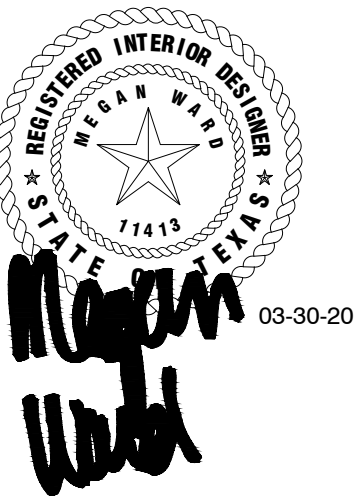
**01 POWER & COMMUNICATION PLAN**  
SCALE: 1/8" = 1'-0"

POWER & COMMUNICATION LEGEND	
SYMB.	DESCRIPTION
NAME 000	ROOM NAME/NUMBER
E	EXISTING ITEM
D	EXISTING ITEM TO BE REMOVED ALL OTHERS ARE EXISTING TO REMAIN
⊕	WALL MOUNTED DUPLEX ELECTRICAL CIRCUIT
⊕⊕	WALL MOUNTED QUADRADUPLEX ELECTRICAL CIRCUIT
⊕⊕⊕	WALL MOUNTED DEDICATED DUPLEX ELECTRICAL CIRCUIT
⊕⊕⊕⊕	WALL MOUNTED DEDICATED QUADRADUPLEX ELECTRICAL CIRCUIT
⊕⊕⊕	208/220 VOLT ELECTRICAL OUTLET
○	BLANK PLATE
⊕	WALL-MOUNTED VOICE/DATA OUTLET
⊕	WALL-MOUNTED DATA OUTLET
⊕	WALL-MOUNTED VOICE OUTLET
⊕K	KEYPAD
⊕TV	HDMI CONNECTION
⊕CR	TENANT-PROVIDED CARD READER TO BE TIED INTO BUILDING FIRE ALARM SYSTEM
⊕PB	PUSH BUTTON DOOR RELEASE
⊕	CEILING-MOUNTED JUNCTION BOX FOR TELEPHONE, DATA, ELECTRICAL - HARDWIRED TO TENANT PROVIDED POWER POLE. SUBSCRIPT INDICATES NUMBER OF STATIONS SERVED.
⊕	RECESSED FLOOR-MOUNTED POKE-THRU DEVICE FOR TELEPHONE, DATA, ELECTRICAL - HARDWIRED TO TENANT PROVIDED FURNITURE SUBSCRIPT INDICATES NUMBER OF STATIONS SERVED.
⊕	WALL MOUNTED FURNITURE FEED FOR ELECTRICAL - HARDWIRED TO TENANT PROVIDED FURNITURE. SUBSCRIPT INDICATES NUMBER OF STATIONS SERVED.
⊕	WALL MOUNTED FURNITURE FEED FOR VOICE/DATA - HARDWIRED TO TENANT PROVIDED FURNITURE. SUBSCRIPT INDICATES NUMBER OF STATIONS SERVED.
⊕	RECESSED FLOOR-MOUNTED ELECTRICAL, VOICE/DATA OUTLET
+XX	INDICATES MOUNTING HEIGHT IN INCHES
GFI	INDICATES GROUND FAULT INTERRUPTOR
IG	ISOLATED GROUND OUTLET
⊕X	NOTE REFERENCE
ALL SYMBOLS NOT NECESSARILY USED	



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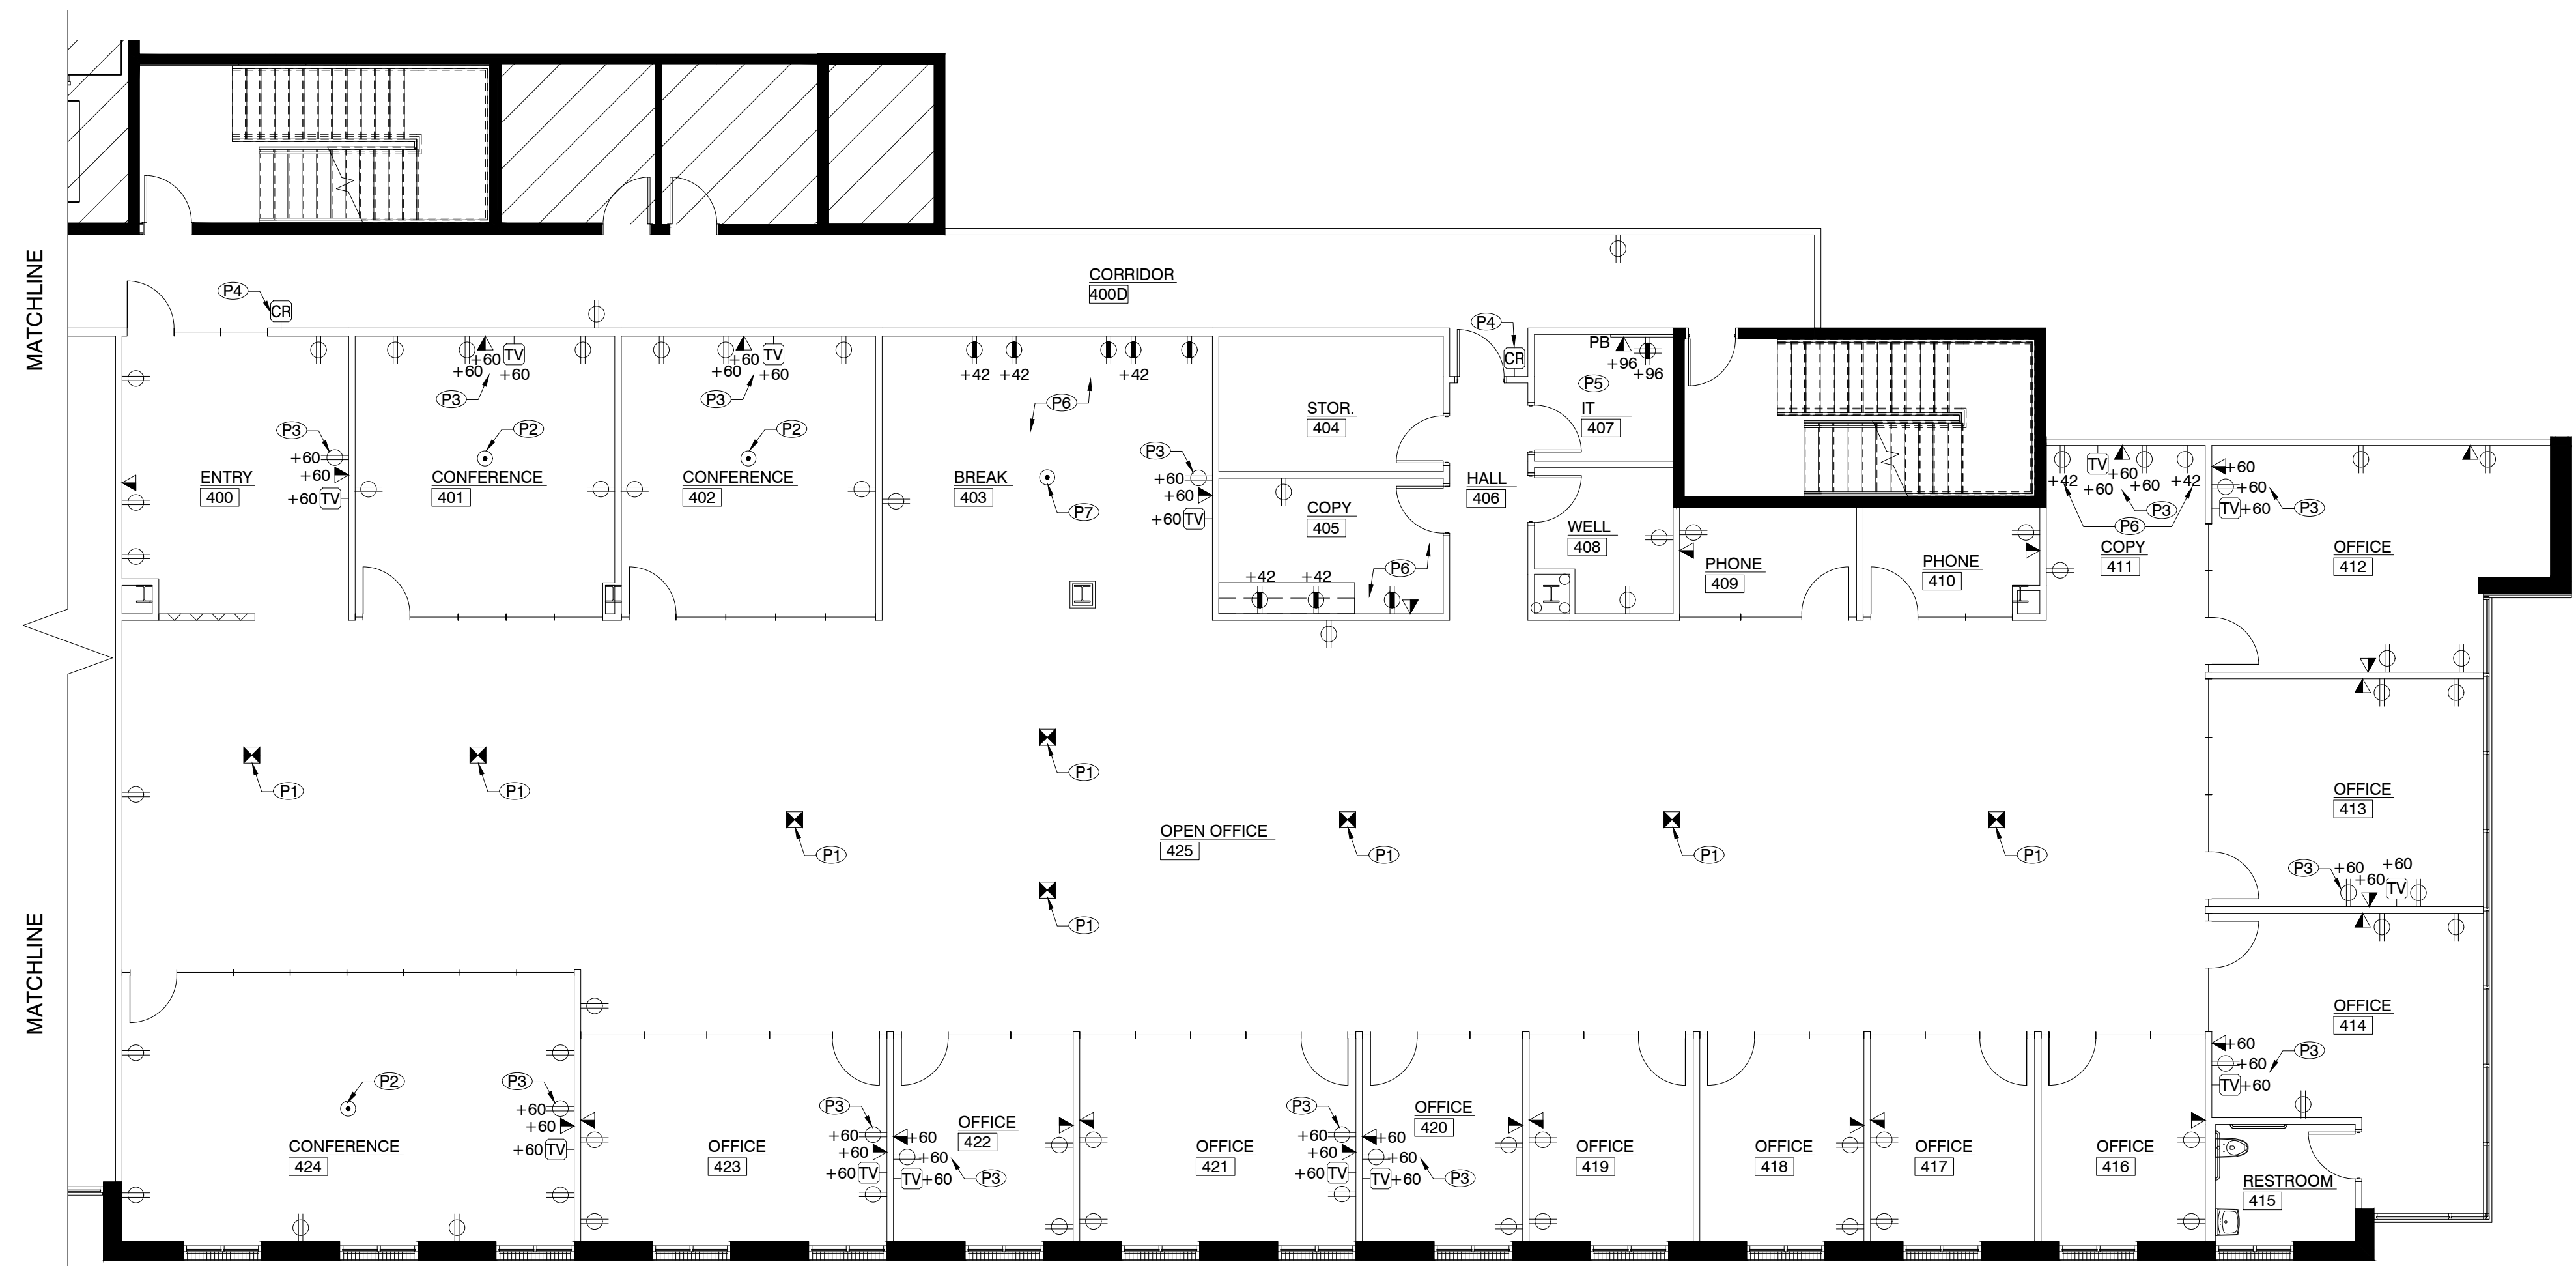
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DRAWING TITLE:  
**POWER & COMMUNICATION PLAN**

DRAWING NUMBER:  
**A2.2E**
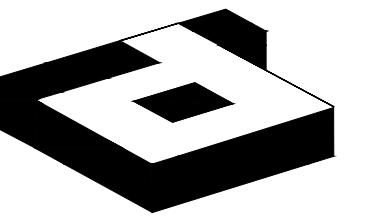
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# 01 POWER & COMMUNICATION PLAN

SCALE: 1/8" = 1'-0"

### POWER / COMMUNICATION NOTES:


- VERIFY ALL FLOOR CORING WITH THE TENANT, STRUCTURAL ENGINEER, FURNITURE VENDOR AND LANDLORD PRIOR TO INSTALLATION. ALL LOCATIONS TO BE IDENTIFIED AND APPROVED BY TENANT PRIOR TO INSTALLATION. ALL CORING TO BE SEALED PER APPLICABLE CODE.
- IF REQUIRED, CONTRACTOR TO X-RAY SLAB TO DETECT LOCATIONS OF EXISTING STRUCTURAL AND ELECTRICAL SYSTEMS BEFORE ALL CORING WORK. VERIFY WITH BUILDING MANAGEMENT.
- CONTRACTOR TO PROVIDE ELECTRICAL FOR ALL INSTALLED APPLIANCES.
- ALL LOW VOLTAGE NETWORK/AV CABLING IS THE RESPONSIBILITY OF THE TENANT.
- ALL OUTLETS ABOVE TENANT PROVIDED COUNTER TOP AT BREAK 403 ARE FOR DEDICATED USE AND ARE NOT CONVENIENCE OUTLETS. COORDINATE EXACT LOCATIONS WITH TENANT PROVIDED MILLWORK.

### POWER / COMMUNICATION KEYNOTES:

- P1. PROVIDE RECESSED FLOOR-MOUNTED POKE THROUGH DEVICE FOR TELEPHONE, DATA, AND ELECTRICAL. TO BE HARDWIRED TO TENANT PROVIDED PANEL SYSTEM. SUBSCRIPT INDICATES NUMBER OF STATIONS BEING SERVED. VERIFY NUMBER OF TELEPHONE, DATA, AND ELECTRICAL OUTLETS REQUIRED AT EACH WORK STATION WITH TENANT. VERIFY EXACT LOCATION WITH TENANT/TENANTS FURNITURE VENDOR. ELECTRICAL CONTRACTOR TO BE RESPONSIBLE FOR CONNECTION TO TENANT'S PANEL SYSTEM.
- P2. PROVIDE RECESSED CORE DRILL AT CONFERENCE ROOMS 401, 402 & 424. FLOOR CORE TO CONTAIN (1) DUPLEX OUTLET AND (1) VOICE/DATA OUTLET. COORDINATE EXACT LOCATIONS WITH TENANT AND BUILDING ENGINEER. PROVIDE ADDITIONAL CORE IN SLAB AT PHONE BOARD LOCATION AS REQUIRED.
- P3. PROVIDE ELECTRICAL OUTLET, DATA OUTLET AND CONDUIT FOR HDMI CONNECTION TO TELEVISION FOR TENANT PROVIDED TELEVISION. COORDINATE WITH TENANT FOR EXACT LOCATIONS. RECEPTACLES TO BE RECESSED.
- P4. PROVIDE POWER FOR TENANT CARD READER ACCESS SYSTEM. VERIFY EXACT LOCATION WITH TENANT. COORDINATE WITH TENANT'S SECURITY VENDOR.
- P5. COORDINATE EXACT ELECTRICAL REQUIREMENTS AT IT 407 WITH TENANT.
- P6. COORDINATE ELECTRICAL LOCATIONS WITH TENANT PROVIDED MILLWORK AT BREAK 403 AND COPY 411.
- P7. COORDINATE CORE DRILLING LOCATIONS WITH NEW TENANT PROVIDED ISLAND. VERIFY EXACT ISLAND OUTLET LOCATIONS WITH TENANT.


### POWER & COMMUNICATION LEGEND

SYMB.	DESCRIPTION
000	ROOM NAME/NUMBER
E	EXISTING ITEM
D	EXISTING ITEM TO BE REMOVED
⊕	WALL MOUNTED DUPLEX ELECTRICAL CIRCUIT
⊕⊕	WALL MOUNTED QUADRADUPLEX ELECTRICAL CIRCUIT
⊕⊕⊕	WALL MOUNTED DEDICATED DUPLEX ELECTRICAL CIRCUIT
⊕⊕⊕⊕	WALL MOUNTED DEDICATED QUADRADUPLEX ELECTRICAL CIRCUIT
⊕⊕⊕⊕⊕	208/220 VOLT ELECTRICAL OUTLET
○	BLANK PLATE
◀	WALL-MOUNTED VOICE/DATA OUTLET
◀◀	WALL-MOUNTED DATA OUTLET
◀◀◀	WALL-MOUNTED VOICE OUTLET
[K]	KEYPAD
[TV]	HDMI CONNECTION
[CR]	TENANT-PROVIDED CARD READER TO BE TIED INTO BUILDING FIRE ALARM SYSTEM
[PB]	PUSH BUTTON DOOR RELEASE
⊕	CEILING-MOUNTED JUNCTION BOX FOR TELEPHONE, DATA, ELECTRICAL - HARDWIRED TO TENANT PROVIDED POWER POLE. SUBSCRIPT INDICATES NUMBER OF STATIONS SERVED.
⊕	RECESSED FLOOR-MOUNTED POKE-THRU DEVICE FOR TELEPHONE, DATA, ELECTRICAL - HARDWIRED TO TENANT PROVIDED FURNITURE. SUBSCRIPT INDICATES NUMBER OF STATIONS SERVED.
⊕	WALL-MOUNTED FURNITURE FEED FOR ELECTRICAL - HARDWIRED TO TENANT PROVIDED FURNITURE. SUBSCRIPT INDICATES NUMBER OF STATIONS SERVED.
⊕	WALL-MOUNTED FURNITURE FEED FOR VOICE/DATA - HARDWIRED TO TENANT PROVIDED FURNITURE. SUBSCRIPT INDICATES NUMBER OF STATIONS SERVED.
○	RECESSED FLOOR-MOUNTED ELECTRICAL, VOICE/DATA OUTLET
+XX	INDICATES MOUNTING HEIGHT IN INCHES
GFI	INDICATES GROUND FAULT INTERRUPTOR
IG	ISOLATED GROUND OUTLET
⊗	NOTE REFERENCE
ALL SYMBOLS NOT NECESSARILY USED	

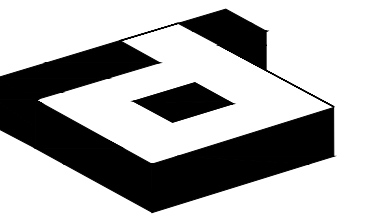

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TENANT R.S.F.: 9,452

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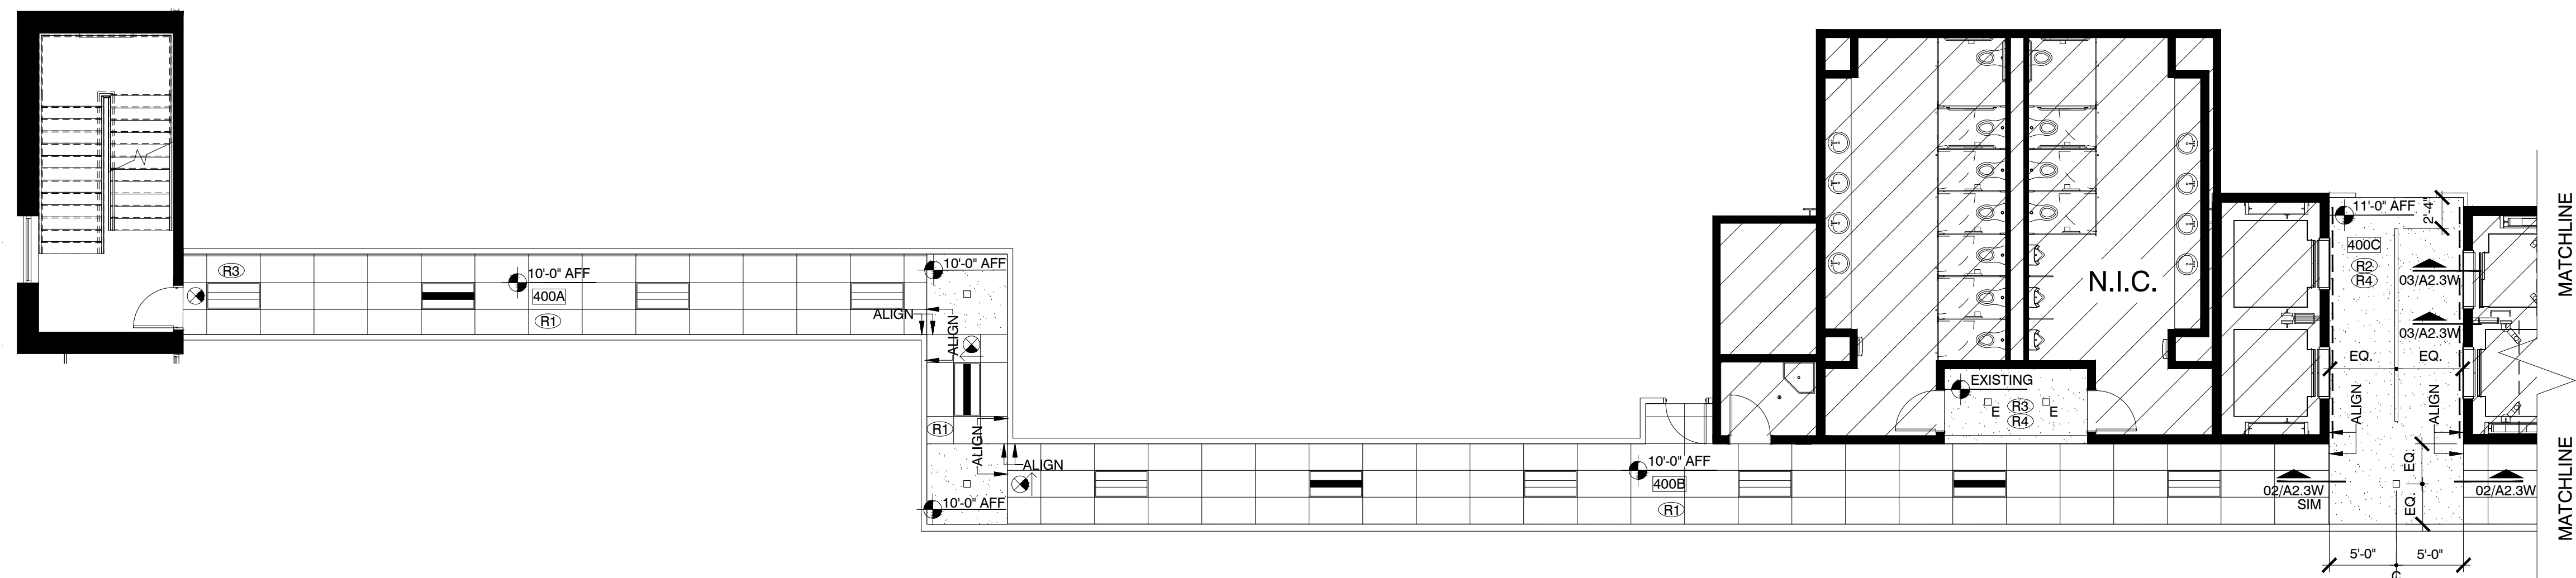
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LANDLORD/CLIENT REVIEW ISSUE DATE: 03/30/20  
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DRAWING TITLE:  
**REFLECTED CEILING PLAN**

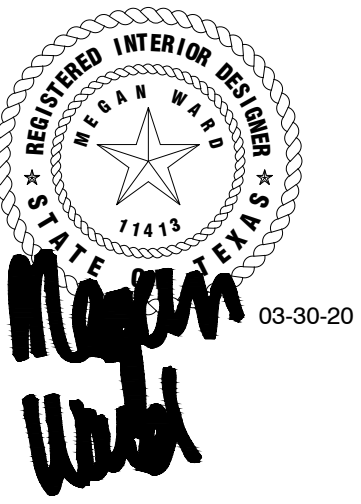
DRAWING NUMBER:  
**A2.3W**

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### 01 REFLECTED CEILING PLAN

SCALE: 1/8" = 1'-0"



#### REFLECTED CEILING NOTES:

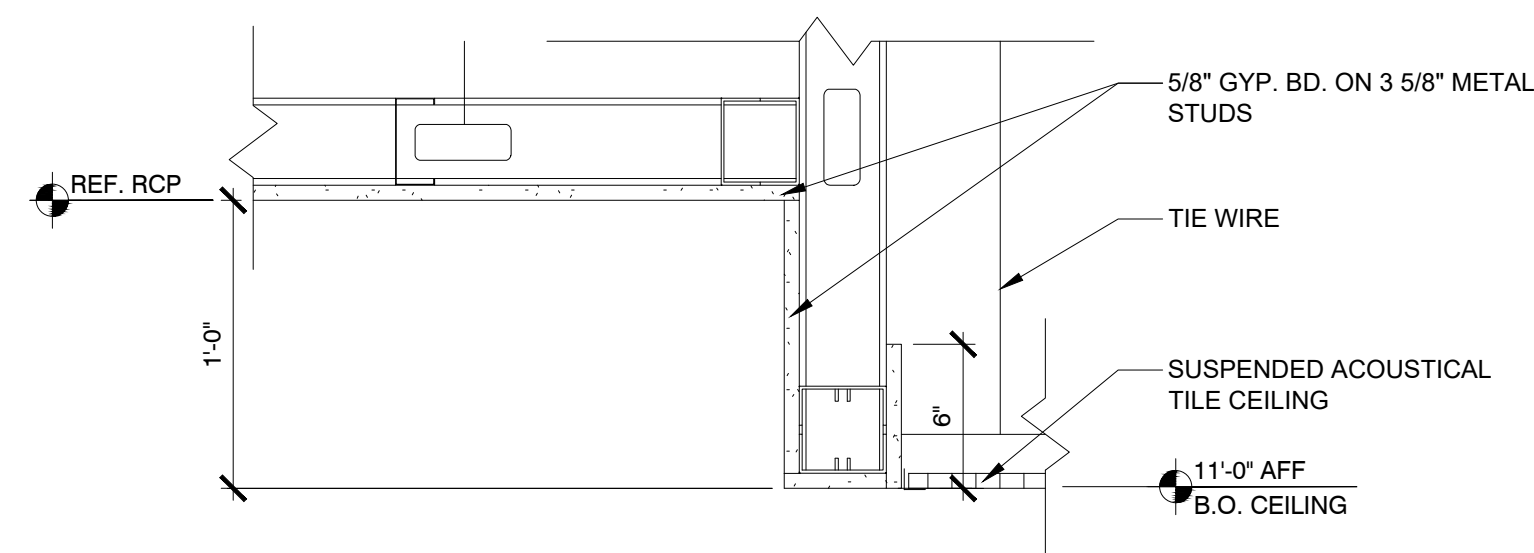• PROVIDE NEW BUILDING STANDARD GRID AND TILE AT COMMON CORRIDOR. SPECIFICATION: GRID - ARMSTRONG PRELUDE XL, 15/16", WHITE, EXPOSED TEE SYSTEM  
2X4 CEILING TILE - ARMSTRONG, ULTIMA, SQUARE LAY-IN REGULAR 15/16"  
VERIFY EXACT SPECIFICATION WITH BUILDING MANAGEMENT.

• THERMOSTATS TO BE PLACED AWAY FROM CENTERS OF ALL WALLS. PLACEMENT TO COMPLY WITH ALL CODES. WHERE POSSIBLE, COORDINATE WITH TENANT FOR DESIRED LOCATIONS.

• ALL THERMOSTATS LOCATED ON EXTERIOR WALLS TO HAVE HARD CONDUIT RUN FOR CONTROL WIRING, U.O.N.  
• PROVIDE NEW LIGHT FIXTURES THROUGHOUT. REFERENCE LIGHTING SCHEDULE.

• ALL LIGHTING RECONFIGURATIONS TO MEET MOST CURRENT INTERNATIONAL ENERGY CONSERVATION CODE AND ANY OF ITS AMENDMENTS. SQUARE FOOTAGE USED FOR ENERGY CALCULATIONS IS 1,911.

• PROVIDE EXIT SIGNS AND 24 HOUR LIGHTS ON EMERGENCY CIRCUITS. SPECIFICATION: EXIT SIGN CLEAR LUCITE GREEN

• CONTRACTOR TO VERIFY ALL SWITCH LOCATIONS DO NOT FALL BEHIND DOOR SWINGS.  
• 24 HOUR LIGHT FIXTURES MUST BE ON EMERGENCY CIRCUITS.

• REWORK SPRINKLER HEADS AS REQUIRED. EXACT SPRINKLER LOCATIONS SHALL BE DETERMINED BY A STATE LICENSED SPRINKLER CONTRACTOR TO COMPLY WITH LOCAL BUILDING AND FIRE CODES. IF REQUIRED, CONTRACTOR TO REVISE EXISTING LAYOUT TO CONFORM TO NFPA.

• ALL LIGHT SWITCHES TO BE LABELED WITH CIRCUIT NUMBERS. SWITCHES TO BE NUMBERED ON BACK OF PLATES.

• ALL J-BOXES IN CEILING REQUIRE FLAGGING OF THE MC CABLE WITH LABELING OF THE PANEL WITH CIRCUIT NUMBER INCLUDED.

• GC REQUIRED TO RETAIN A TEST AND BALANCE REPORT FROM NATIONAL TAB.

• GC IS REQUIRED TO CONTRACT WITH CLIMATEC FOR HVAC CONTROL VENDOR.

• VERIFY ALL CEILING HEIGHTS AT ALL COMMON AREAS WITH BUILDING MANAGEMENT PRIOR TO INSTALLATION.

#### REFLECTED CEILING KEYNOTES:

R1. NEW CEILING GRID AND LIGHT FIXTURES TO BE CENTERED IN CORRIDOR.

R2. COORDINATE WITH BUILDING MANAGEMENT FOR DESIRED LOCATION FOR SWITCH IN PUBLIC CORRIDOR.

R3. EXISTING CEILING AND LIGHT TO REMAIN WHERE INDICATED.

R4. PAINT GYPSUM BOARD CEILING TO MATCH ADJACENT GRID AND CEILING. VERIFY EXACT PAINT COLOR WITH BUILDING MANAGEMENT.

#### LIGHTING SCHEDULE

SYMBOL	DESCRIPTION
	NEW LED BLDG. STD. 2' X 4' LIGHT FIXTURE. LOWER CASE LETTER INDICATES CIRCUIT MFR: COOPER LIGHTING, METALUX, MTO, 24SR-LD1-48-C-UNV-L830-CD1-U
	NEW LED BLDG. STD. 2' X 4' LIGHT FIXTURE ON BUILDING EMERGENCY SYSTEM MFR: COOPER LIGHTING, METALUX, MTO, 24SR-LD1-48-C-UNV-L830-CD1-U
	NEW 6" LED BLDG. STD DOWNLIGHT: MFR: LITHONIA, LDN6SO-35/20-LS6AR-LSS-MVOLT-GZ1 CENTERED IN GYPSUM SOFFIT, U.N.O.
	NEW LED BLDG. STD LIGHT FIXTURE: MFR: FOCAL POINT, SEEM 4 LED, FSM4L-FL-1000LF-35K-1C-UNV-LD1-XFF-WH-14-4"
	NEW LED BLDG. STD LIGHT TAPE LIGHT: MFR: ACOLYTE, CH-AC2-F-S2-90-IP20-24-3-25-X-ND-38"


#### REFLECTED CEILING PLAN LEGEND

SYMBOL	DESCRIPTION
	ROOM NUMBER
	EXISTING ITEM TO REMAIN
	EXISTING TO BE REMOVED OR RELOCATED
	ALL OTHERS ARE NEW
	NEW 2' X 2' CEILING GRID, U.N.O.
	NEW 2' X 4' CEILING GRID, U.N.O.
	5/8" GYPSUM BOARD CEILING/SOFFIT
	EXPOSED CEILING/OPEN TO DECK
	LIGHT SWITCH R INDICATES REMOVE AND PATCH WALL
	DIMMER SWITCH, LOWER CASE LETTER INDICATES CIRCUIT
	3-WAY SWITCH, LOWER CASE LETTER INDICATES CIRCUIT
	BLDG. STANDARD EXIT SIGN
	CEILING TRANSITION
	BLDG. STANDARD EXHAUST FAN WITH SWITCH AS REQUIRED BY CODE - WHITE
	CEILING HEIGHT INDICATOR
	NOTE REFERENCE

ALL SYMBOLS NOT NECESSARILY USED

### 02 CEILING DETAIL


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### 03 LIGHT COVE DETAIL

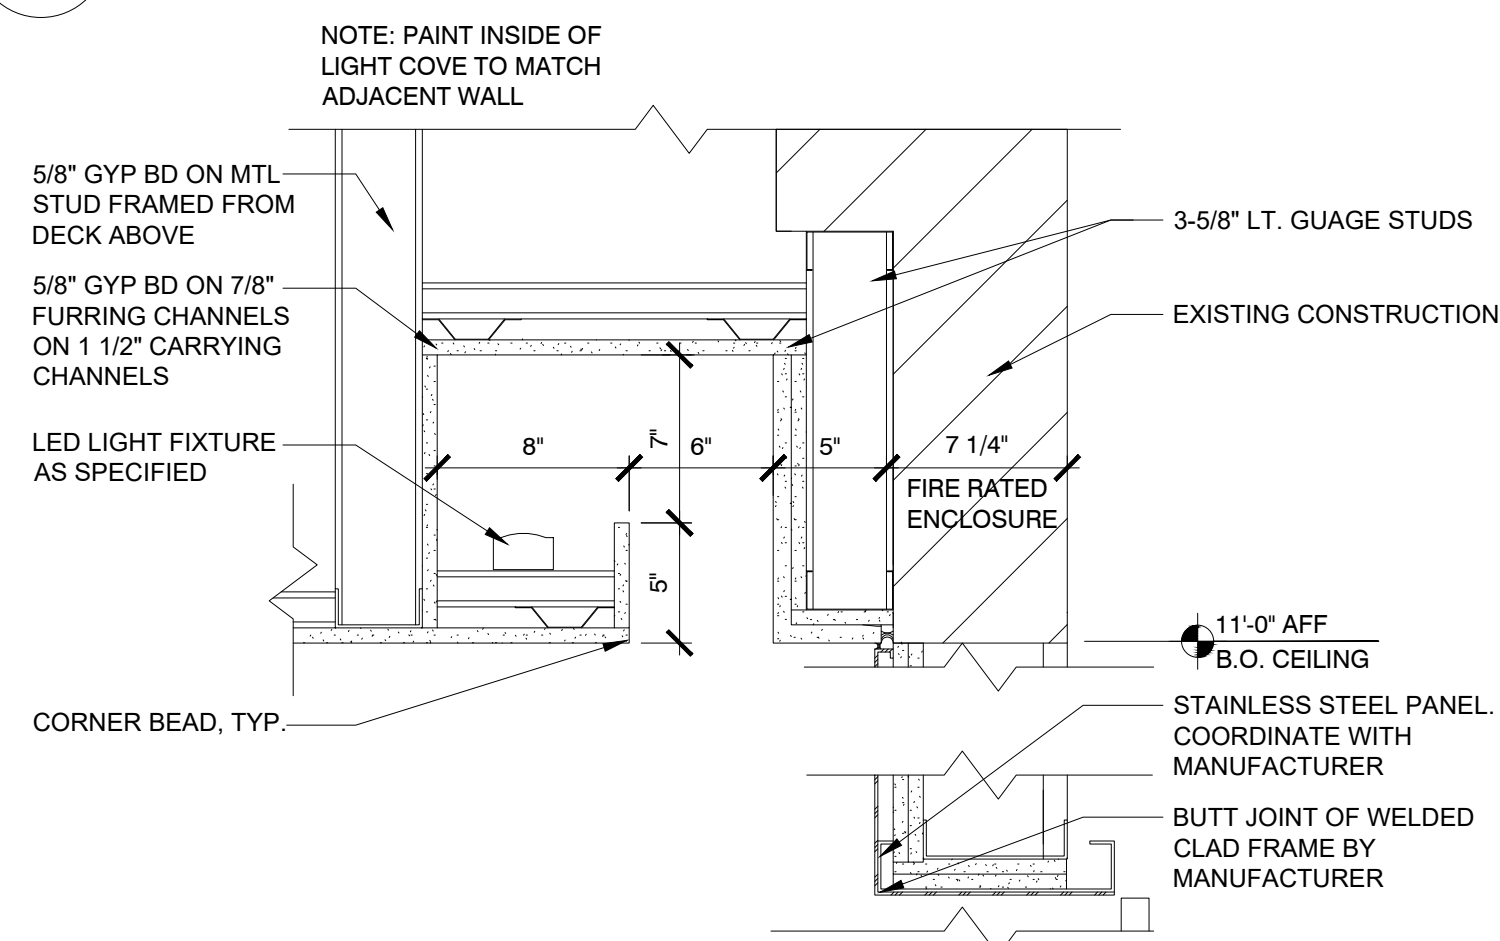
SCALE: 1 1/2" = 1'-0"





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2641 IRVING BLVD.  
DALLAS, TEXAS 75207  
TEL: 214-638-6800 FAX: 214-689-0301

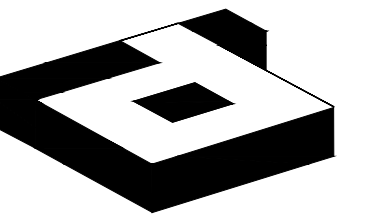

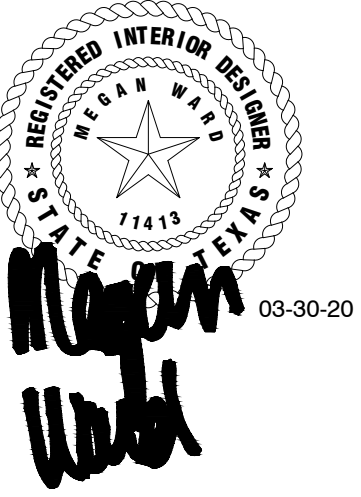PROJECT NO.: 580-004  
DRAWN BY: RH  
CHECKED BY: MW  
TENANT R.S.F.: 9,452

**BILLINGSLEY**  
COMPANY

3401 OLYMPUS  
ARTISAN DESIGN GROUP

3401 OLYMPUS BLVD.  
SUITE #450  
DALLAS, TX 75019


NO.	ISSUED FOR:	DATE:
1	REVISION 1	04/17/20

LANDLORD/CLIENT REVIEW ISSUE DATE: 03/30/20  
BID ISSUE DATE: 03/30/20  
CONSTRUCTION ISSUE DATE: 03/30/20

DRAWING TITLE:  
REFLECTED CEILING PLAN

DRAWING NUMBER:  
**A2.3E**

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# 01 REFLECTED CEILING PLAN

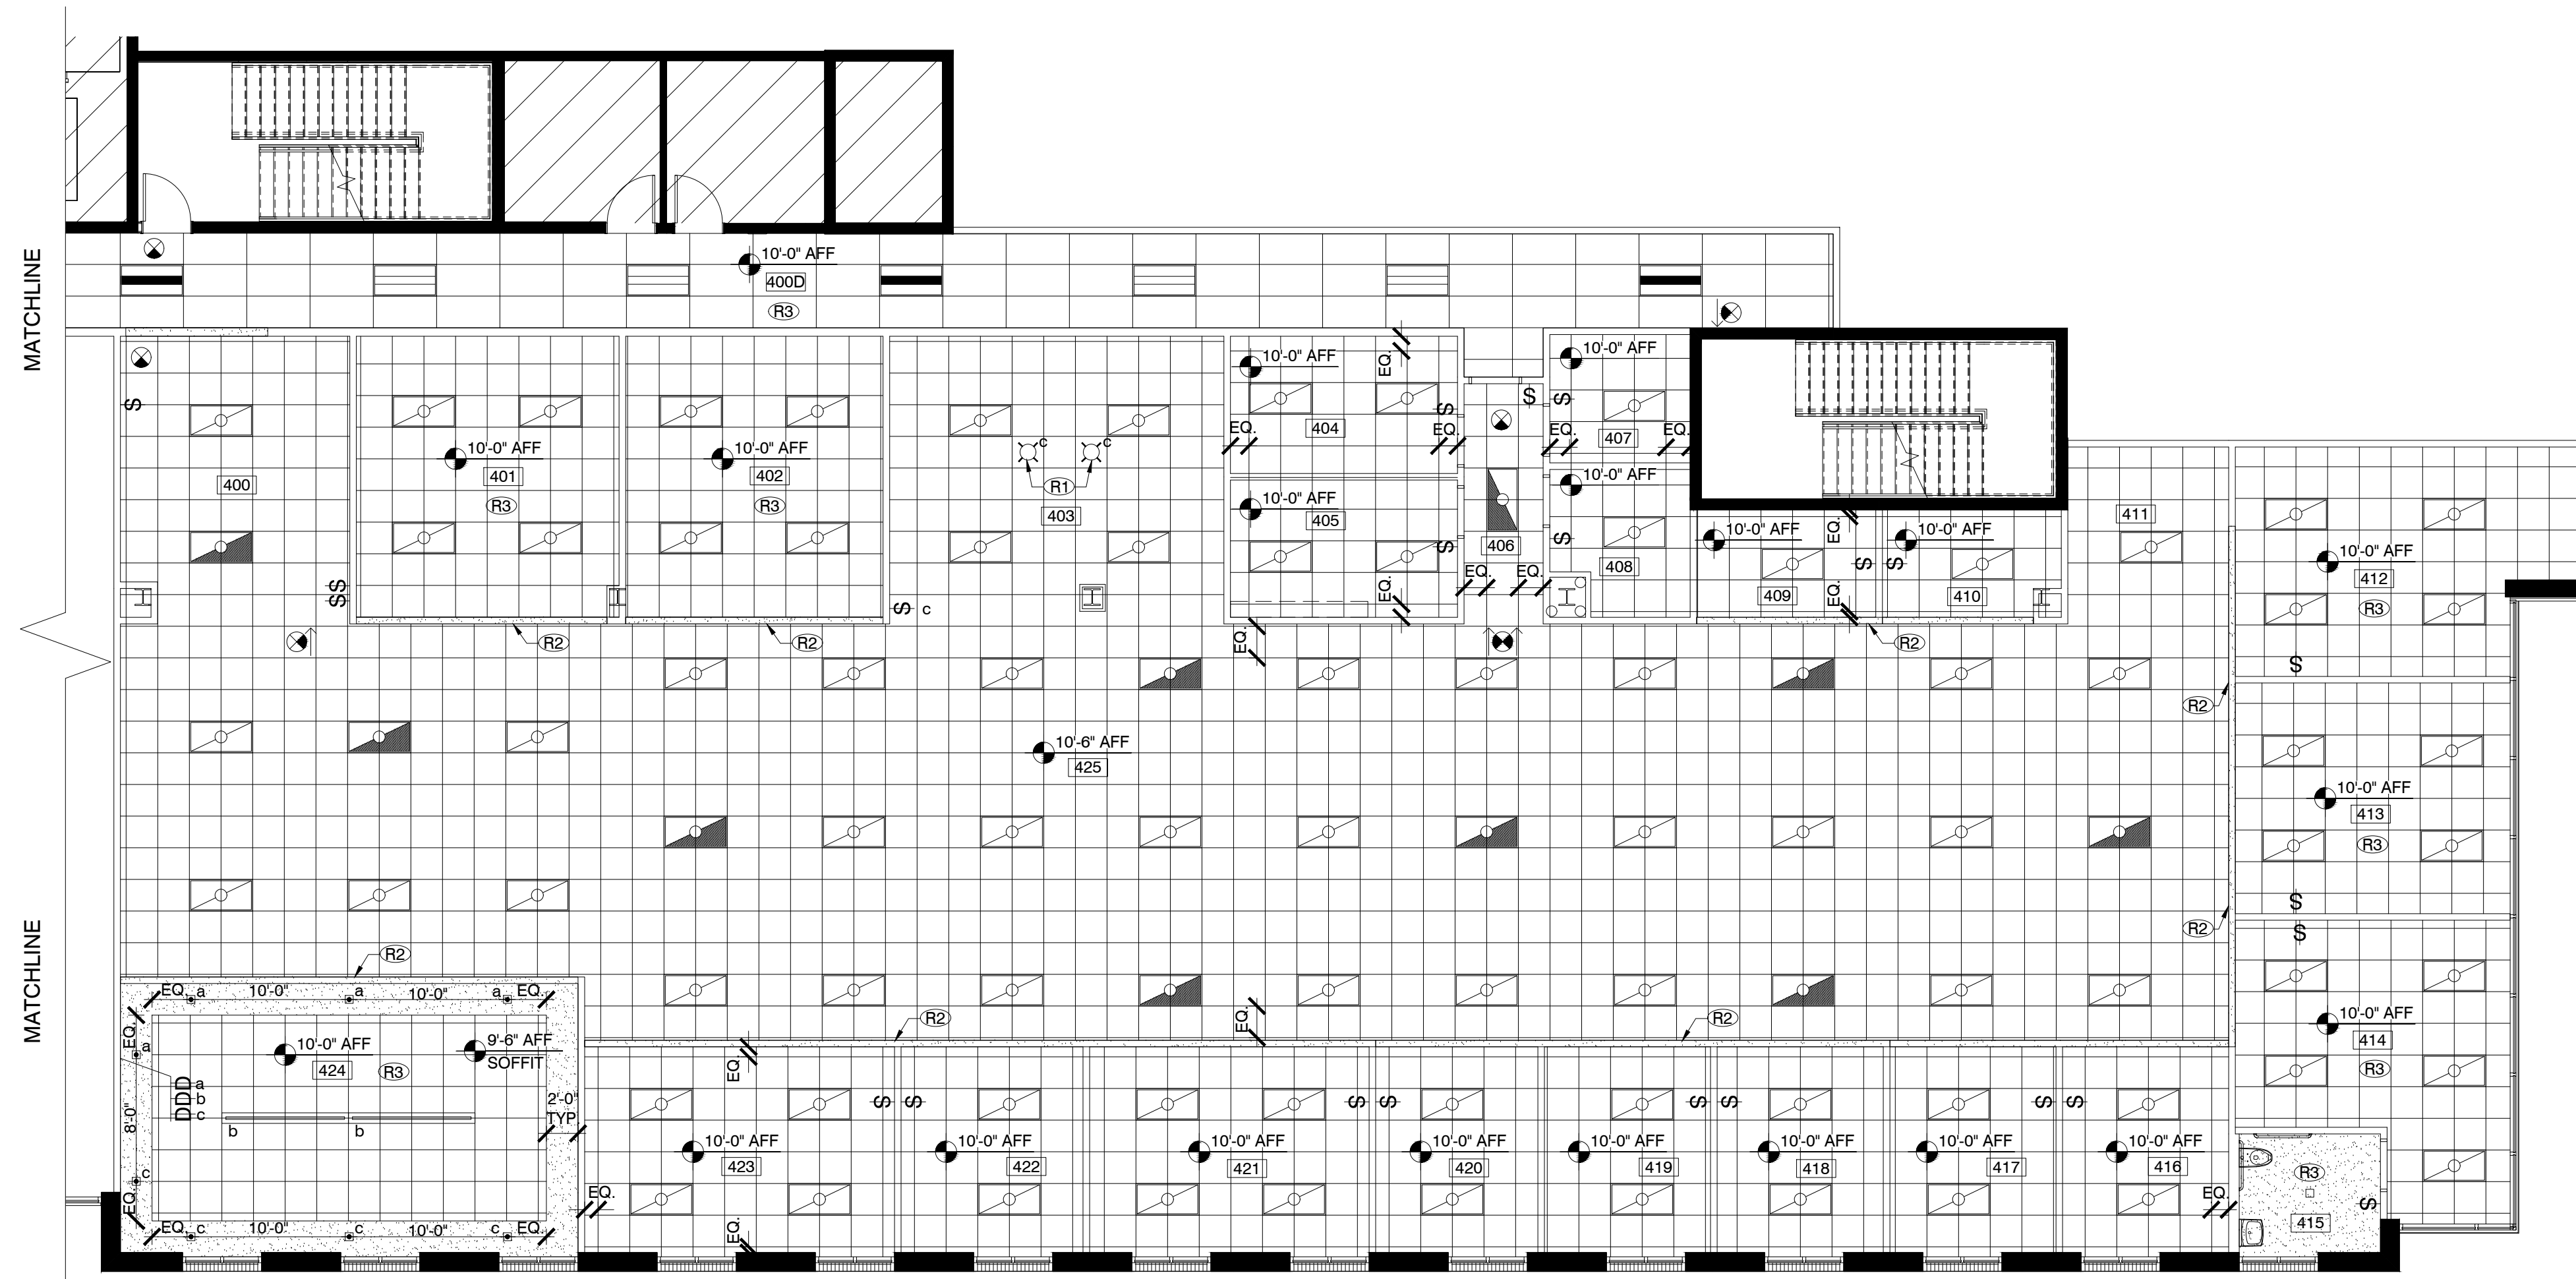SCALE: 1/8" = 1'-0"

### REFLECTED CEILING NOTES:

- PROVIDE NEW 2X2 BUILDING STANDARD GRID AND TILE THROUGHOUT, U.N.O. SPECIFICATION: GRID - ARMSTRONG 15/16", WHITE. 2X2 CEILING TILE - ARMSTRONG, 1774 DUNE, TEGULAR 15/16". VERIFY EXACT SPECIFICATION WITH BUILDING MANAGEMENT.
- PROVIDE NEW 2X4 BUILDING STANDARD CEILING GRID AND TILE AT COMMON CORRIDOR. SPECIFICATION: GRID - ARMSTRONG PRELUDE XL, 15/16", WHITE, EXPOSED TEE SYSTEM. 2X4 CEILING TILE - ARMSTRONG, ULTIMA, SQUARE LAY-IN TEGULAR 15/16". VERIFY EXACT SPECIFICATION WITH BUILDING MANAGEMENT.
- THERMOSTATS TO BE PLACED AWAY FROM CENTERS OF ALL WALLS. PLACEMENT TO COMPLY WITH ALL CODES, WHERE POSSIBLE, COORDINATE WITH TENANT FOR DESIRED LOCATIONS.
- ALL THERMOSTATS LOCATED ON EXTERIOR WALLS TO HAVE HARD CONDUIT RUN FOR CONTROL WIRING, U.O.N.
- PROVIDE NEW LIGHT FIXTURES THROUGHOUT. REFERENCE LIGHTING SCHEDULE.
- ALL LIGHTING RECONFIGURATIONS TO MEET MOST CURRENT INTERNATIONAL ENERGY CONSERVATION CODE AND ANY OF ITS AMENDMENTS. SQUARE FOOTAGE USED FOR ENERGY CALCULATIONS IS 8,373.
- PROVIDE EXIT SIGNS AND 24 HOUR LIGHTS ON EMERGENCY CIRCUITS. SPECIFICATION: EXIT SIGN CLEAR LUCITE GREEN.
- VERIFY ALL LISTED SUSPENDED PENDANT FIXTURE MOUNTING HEIGHTS WITH TENANT.
- CONTRACTOR TO VERIFY ALL SWITCH LOCATIONS DO NOT FALL BEHIND DOOR SWINGS.
- 24 HOUR LIGHT FIXTURES MUST BE ON EMERGENCY CIRCUITS.
- REWORK SPRINKLER HEADS AS REQUIRED. EXACT SPRINKLER LOCATIONS SHALL BE DETERMINED BY A STATE LICENSED SPRINKLER CONTRACTOR TO COMPLY WITH LOCAL BUILDING AND FIRE CODES. IF REQUIRED, CONTRACTOR TO REVISE EXISTING LAYOUT TO CONFORM TO NFPA. RAISE SPRINKLER LINES AS REQUIRED TO MEET SPECIFIED CEILING HEIGHTS.
- VERIFY ALL CEILING HEIGHTS AT ALL COMMON AREAS WITH BUILDING MANAGEMENT PRIOR TO INSTALLATION.

### REFLECTED CEILING NOTES CONT.:

- ALL LIGHT SWITCHES TO BE LABELED WITH CIRCUIT NUMBERS. SWITCHES TO BE NUMBERED ON BACK OF PLATES.
  - ALL J-BOXES IN CEILING REQUIRE FLAGGING OF THE MC CABLE WITH LABELING OF THE PANEL WITH CIRCUIT NUMBER INCLUDED.
  - GC REQUIRED TO RETAIN A TEST AND BALANCE REPORT FROM NATIONAL TAB.
  - GC IS REQUIRED TO CONTRACT WITH CLIMATEC FOR HVAC CONTROL VENDOR.
- REFLECTED CEILING KEYNOTES:**
- R1. PENDANT LIGHT FIXTURES TO BE CENTERED OVER TENANT PROVIDED MILLWORK PIECE AT BREAK 403. COORDINATE WITH TENANT FOR EXACT LOCATION.
  - R2. GYPSUM BOARD HEADERS AT GLASS WALL SYSTEM LOCATIONS TO BE PAINTED TO MATCH ADJACENT WALL.
  - R3. NEW CEILING GRID AND LIGHT FIXTURES TO BE CENTERED IN ROOM INDICATED.


### LIGHTING SCHEDULE

SYMBOL	DESCRIPTION
[Symbol]	NEW LED BLDG. STD. 2' X 4' LIGHT FIXTURE, LOWER CASE LETTER INDICATES CIRCUIT MFR: COOPER LIGHTING, METALUX, MTO, 24SR-LD1-48-C-UNV-L830-CD1-U
[Symbol]	NEW LED BLDG. STD. 2' X 4' LIGHT FIXTURE ON BUILDING EMERGENCY SYSTEM MFR: COOPER LIGHTING, METALUX, MTO, 24SR-LD1-48-C-UNV-L830-CD1-U
[Symbol]	NEW LED BLDG. STD. 2' X 4' LIGHT FIXTURE, LOWER CASE LETTER INDICATES CIRCUIT MFR: LITHONIA - AVANTE, PRODUCT #: 2AVL4-40L-MDR-EZ1-LP835
[Symbol]	NEW LED BLDG. STD. 2' X 4' LIGHT FIXTURE ON BUILDING EMERGENCY SYSTEM MFR: LITHONIA - AVANTE, PRODUCT #: 2AVL4-40L-MDR-EZ1-LP835
[Symbol]	NEW LED BLDG. STD DOWNLIGHT: MFR: LITHONIA, LDN6SQ-35/20-LS6AR-LSS-MVOLT-QZ1 FINISH: WHITE, CENTERED IN GYPSUM SOFFIT, U.N.O.
[Symbol]	NEW LED BLDG. STD DIRECT/INDIRECT LINEAR PENDANT, 8' LONG. SPEC: FINELITE (HP-2) PENDANT, #HP-2-ID-16-S-S-835-TG-F-96-120-SC, COLOR: MATTE WHITE, BOTTOM OF FIXTURE MOUNTED AT 9'-0" AFF
[Symbol]	PENDANT FIXTURE, CENTERED IN TILE, U.N.O. BOTTOM OF FIXTURE MOUNTED AT 9'-0" AFF. VERIFY EXACT SPECIFICATION WITH BUILDING MANAGEMENT.

### REFLECTED CEILING PLAN LEGEND


SYMBOL	DESCRIPTION
[Symbol]	ROOM NUMBER
E	EXISTING ITEM TO REMAIN
D	EXISTING TO BE REMOVED OR RELOCATED
[Symbol]	ALL OTHERS ARE NEW
[Symbol]	NEW 2' X 2' CEILING GRID, U.N.O.
[Symbol]	NEW 2' X 4' CEILING GRID, U.N.O.
[Symbol]	5/8" GYPSUM BOARD CEILING/SOFFT
[Symbol]	EXPOSED CEILING/OPEN TO DECK
[Symbol]	LIGHT SWITCH R INDICATES REMOVE AND PATCH WALL
[Symbol]	DIMMER SWITCH, LOWER CASE LETTER INDICATES CIRCUIT
[Symbol]	3-WAY SWITCH, LOWER CASE LETTER INDICATES CIRCUIT
[Symbol]	BLDG. STANDARD EXIT SIGN
[Symbol]	CEILING TRANSITION
[Symbol]	BLDG. STANDARD EXHAUST FAN WITH SWITCH AS REQUIRED BY CODE - WHITE
[Symbol]	CEILING HEIGHT INDICATOR
[Symbol]	NOTE REFERENCE

ALL SYMBOLS NOT NECESSARILY USED

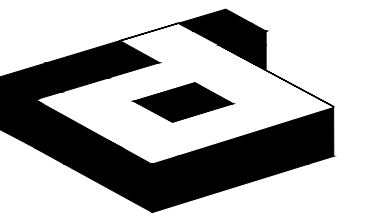

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DALLAS, TEXAS 75207  
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PROJECT NO.: 580-004  
DRAWN BY: RH  
CHECKED BY: MW  
TENANT R.S.F.: 9,452

**BILLINGSLEY**  
COMPANY

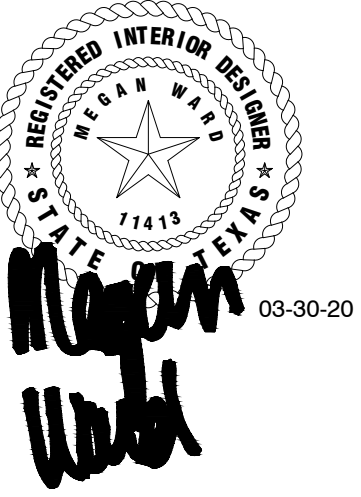3401 OLYMPUS  
ARTISAN DESIGN GROUP

3401 OLYMPUS BLVD.  
SUITE #450  
DALLAS, TX 75019


NO.	ISSUED FOR:	DATE:
1	REVISION 1	04/17/20

LANDLORD/CLIENT REVIEW ISSUE DATE: 03/30/20  
BID ISSUE DATE: 03/30/20  
CONSTRUCTION ISSUE DATE: 03/30/20

DRAWING TITLE:  
**FINISH PLAN**

DRAWING NUMBER:  
**A2.5W**

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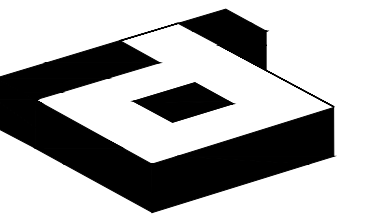
**01 FINISH PLAN**  
SCALE: 1/8" = 1'-0"

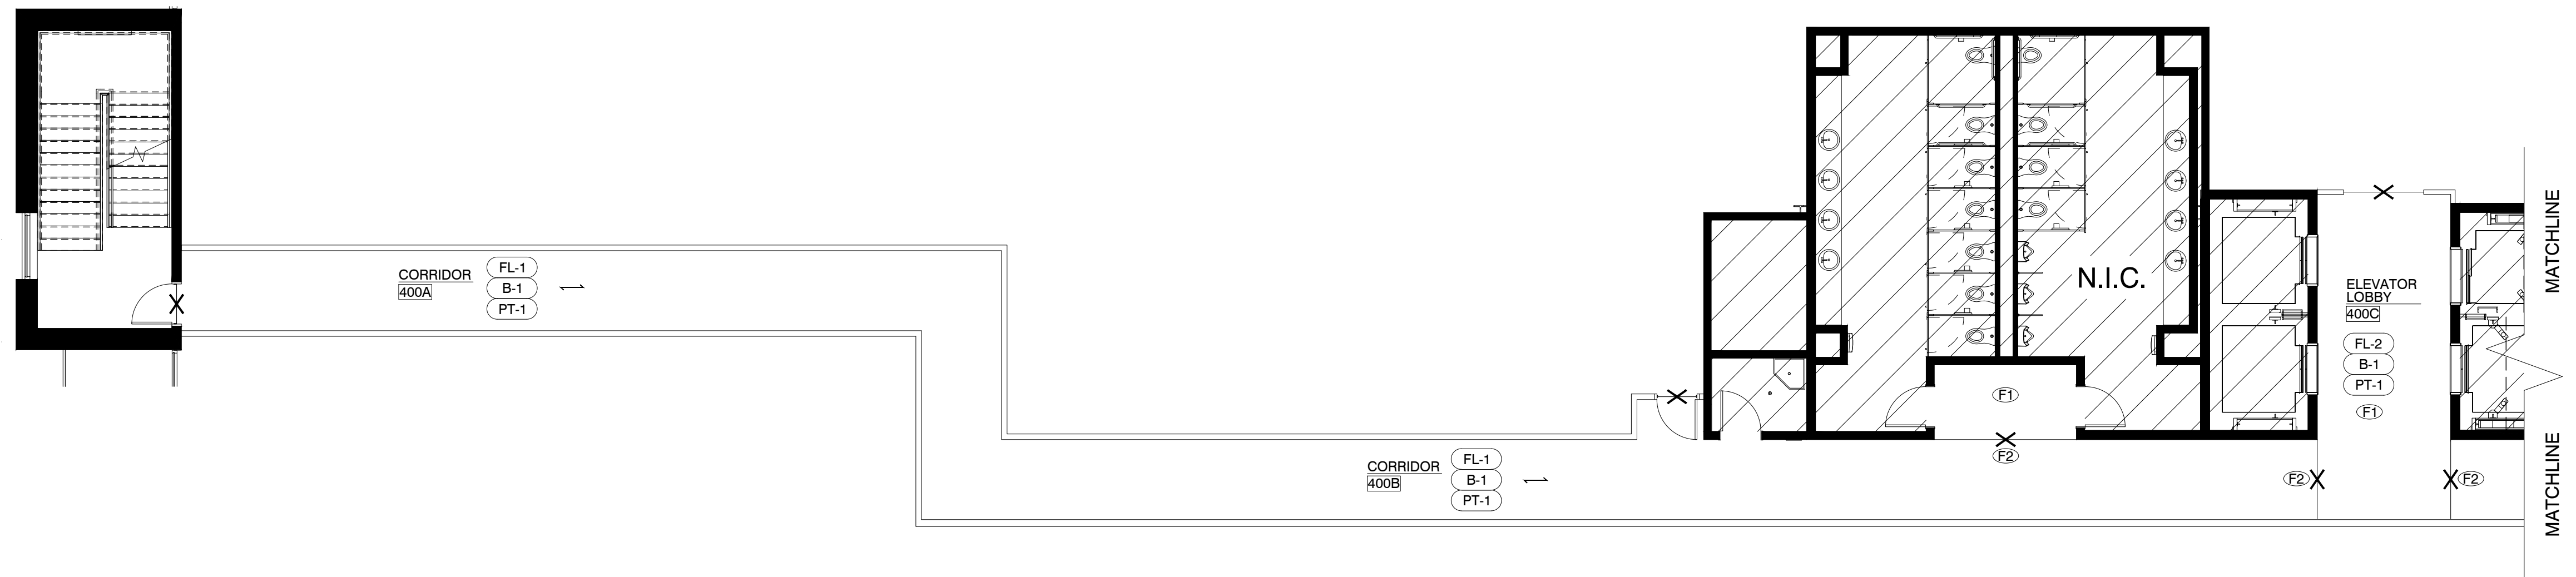- FINISH NOTES:**
- WHERE REQUIRED AT AREAS OF CONSTRUCTION, FURNISH AND INSTALL BUILDING STANDARD FINISHES IN COMMON AREAS. COORDINATE WITH LANDLORD FOR SPECIFICATIONS.
  - FLOAT AND SCRAPE FLOOR TO BE LEVEL AND PREPARE FOR NEW SCHEDULED FINISH.
  - CONTRACTOR TO RESERVE SPECIFIED FLOORING AND BASE UPON BEING AWARDED THE JOB TO ENSURE AVAILABILITY AND TIMELY INSTALLATION. SUBSTITUTIONS ARE NOT PERMITTED UNLESS APPROVED BY TENANT, AND/OR LANDLORD.
  - PROVIDE BUILDING STANDARD TEXTURE AND PAINT THROUGHOUT, U.N.O.
  - ALL PAINTED WALLS SHALL RECEIVE TWO COATS OF LATEX PAINT IN BUILDING STANDARD FINISH. TOUCH-UP OR RE-PAINT ALL WALLS AS NEEDED AFTER COMPLETION OF TENANT LEASE SPACE.
  - TOUCH UP DOORS AT COMMON AREAS AS REQUIRED. ENSURE LIKE NEW CONDITION.
  - REFLOAT ALL EXISTING WALLS DUE TO DEMOLITION AS REQUIRED FOR NEW SCHEDULED FINISH.

- FINISH KEYNOTES:**
- F1. PAINT GYPSUM BOARD HEADER AT CEILING TO MATCH ADJACENT CEILING TILE.
- F2. PROVIDE TRANSITION STRIPS AT ALL CARPET TO CONCRETE TRANSITIONS. ENSURE ALL CARPET THREADS ARE TRIMMED CLOSELY. SPECIFICATION: SCHLUTER, RENO-TK (STAINLESS STEEL).

FINISH SCHEDULE					
FLOORING SCHEDULE					
FL-#	MATERIAL	MRF.	PATTERN/#	COLOR	REMARKS
FL-1	CARPET TILE (24x24)	SHAW CONTRACT	BEYOND THE FOLD 5T058	GRIT 59530	THROUGHOUT, U.N.O. FOR PREFERRED PRICING CONTACT: DAVID GRANT, MOHAWK GROUP, 214.725.9974; david_grant@mohawkind.com
FL-2	DIAMOND POLISHED CONCRETE	T.B.S.	T.B.S.	T.B.S.	INSTALLATION: T.B.D.
BASE SCHEDULE					
B-#	MATERIAL	MRF.	MFR. #	COLOR	REMARKS
B-1	RUBBER	JOHNSONITE	MANDALAY	WHITE	4" STRAIGHT BASE AT CARPET AND COVE AT CONCRETE. CONTINUOUS ROLL, CUTS AT CORNERS ONLY, ENSURE SEAMLESS TRANSITION.
PAINT SCHEDULE					
PT-#	MATERIAL	MRF.	MFR. #	COLOR	REMARKS
PT-1	LATEX	PRATT & LAMBERT	2314-FB	SEED PEARL WHITE	GENERAL PAINT THROUGHOUT, U.N.O. BUILDING STANDARD FINISH

FINISH PLAN LEGEND	
SYMBOL	DESCRIPTION
NAME 000	ROOM NAME/NUMBER
xxx	FINISH SPECIFICATION
wc-x	WALL FINISH SPECIFICATION
✱	FLOOR FINISH TRANSITION. 'E' INDICATES EXISTING TO REMAIN
↔	FLOORING DIRECTION
X	NOTE REFERENCE
ALL SYMBOLS NOT NECESSARILY USED	



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2641 IRVING BLVD.  
DALLAS, TEXAS 75207  
TEL: 214-638-6800 FAX: 214-689-0301



PROJECT NO.: 580-004  
DRAWN BY: RH  
CHECKED BY: MW  
TENANT R.S.F.: 9,452

**BILLINGSLEY**  
COMPANY

3401 OLYMPUS  
ARTISAN DESIGN GROUP

3401 OLYMPUS BLVD.  
SUITE #450  
DALLAS, TX 75019

NO.	ISSUED FOR:	DATE:
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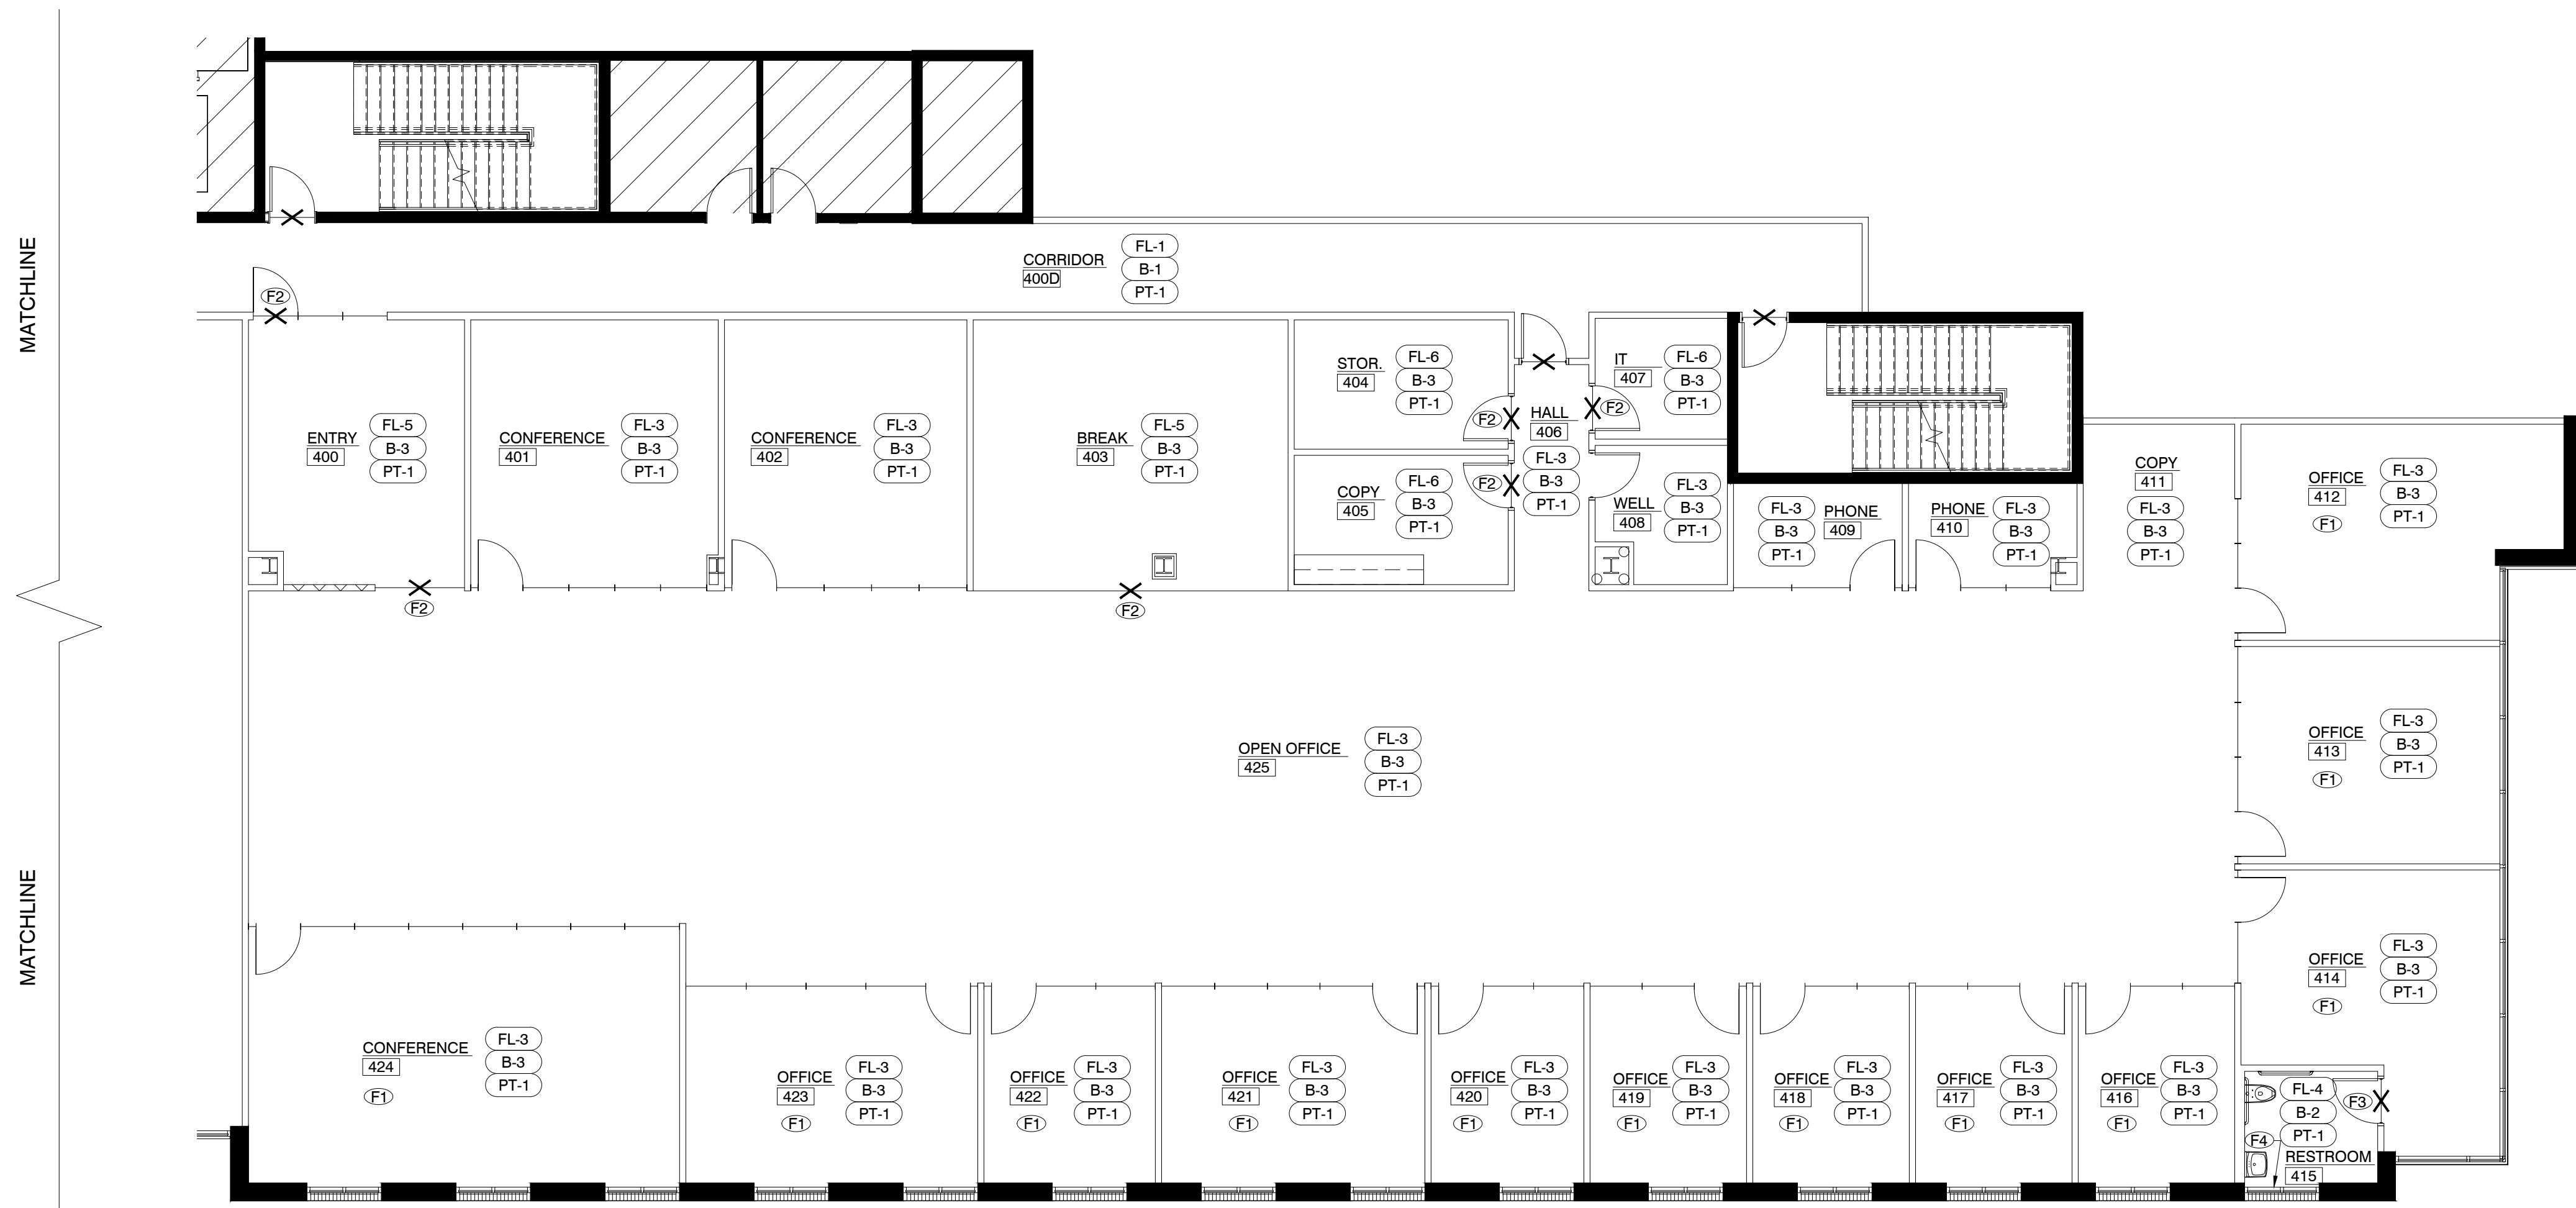
LANDLORD/CLIENT REVIEW ISSUE DATE: 03/30/20  
BID ISSUE DATE: 03/30/20  
CONSTRUCTION ISSUE DATE: 03/30/20

DRAWING TITLE:  
**FINISH PLAN**

DRAWING NUMBER:

**A2.5E**

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# 01 FINISH PLAN

SCALE: 1/8" = 1'-0"

### FINISH NOTES:

• WHERE REQUIRED AT AREAS OF CONSTRUCTION, FURNISH AND INSTALL BUILDING STANDARD FINISHES IN COMMON AREAS. COORDINATE WITH LANDLORD FOR SPECIFICATIONS.

• FLOAT AND SCRAPE FLOOR TO BE LEVEL AND PREPARE FOR NEW SCHEDULED FINISH.

• CONTRACTOR TO RESERVE SPECIFIED FLOORING AND BASE UPON BEING AWARDED THE JOB TO ENSURE AVAILABILITY AND TIMELY INSTALLATION. SUBSTITUTIONS ARE NOT PERMITTED UNLESS APPROVED BY TENANT, AND/OR LANDLORD.

• PROVIDE BUILDING STANDARD TEXTURE AND PAINT THROUGHOUT, U.N.O.

• ALL PAINTED WALLS SHALL RECEIVE TWO COATS OF LATEX PAINT IN BUILDING STANDARD FINISH. TOUCH-UP OR RE-PAINT ALL WALLS AS NEEDED AFTER COMPLETION OF TENANT LEASE SPACE.

• TOUCH UP DOORS AT COMMON AREAS AS REQUIRED. ENSURE LIKE NEW CONDITION.

• REFLOAT ALL EXISTING WALLS DUE TO DEMOLITION AS REQUIRED FOR NEW SCHEDULED FINISH.

• TENANT TO PROVIDE ALL FLOORING MATERIALS AT SUITE. COORDINATE WITH TENANT FOR MATERIALS AND INSTALLATION RESPONSIBILITIES.

### FINISH KEYNOTES:

F1. PROVIDE MANUAL ROLLERSHADES AT GLASS PANELS AT ROOM INDICATED. SPECIFICATION TO BE: MECHOSHADES (OR EQUAL). VERIFY EXACT COLOR AND FINISH WITH TENANT.

F2. PROVIDE TRANSITION STRIPS AT ALL CARPET TO VINYL TRANSITIONS. ENSURE ALL CARPET THREADS ARE TRIMMED CLOSELY.

F3. PROVIDE TRANSITION STRIPS AT ALL CARPET TO TILE TRANSITIONS. ENSURE ALL CARPET THREADS ARE TRIMMED CLOSELY. SPECIFICATION: SCHLUTER, RENO-TK (STAINLESS STEEL).

F4. PROVIDE VINYL FILM AT RESTROOM EXTERIOR WINDOW. COORDINATE EXACT DESIGN AND LOCATION WITH BUILDING MANAGEMENT.

FINISH SCHEDULE					
FLOORING SCHEDULE					
FL-#	MATERIAL	MRF.	PATTERN/#	COLOR	REMARKS
FL-1	CARPET TILE (24x24)	SHAW CONTRACT	BEYOND THE FOLD ST058	GRIT 59530	AT CORRIDOR. FOR PREFERRED PRICING CONTACT: DAVID GRANT, MOHAWK GROUP, 214.725.9974; david_grant@mowhahkind.com
FL-2	DIAMOND POLISHED CONCRETE	T.B.S.	T.B.S.	T.B.S.	INSTALLATION: T.B.D.
FL-3	CARPET TILE (24x24)	T.B.S.	T.B.S.	T.B.S.	THROUGHOUT, U.N.O.
FL-4	PORCELAIN TILE (12X24)	T.B.S.	T.B.S.	T.B.S.	AT RESTROOM. INSTALLATION: T.B.D. GROUT: T.B.D.
FL-5	LVT	T.B.S.	T.B.S.	T.B.S.	AT BREAK ROOM AND ENTRY. INSTALLATION: T.B.D.
FL-6	VCT (12X12)	ARMSTRONG	STANDARD EXCELON	51915 CHARCOAL	IT AND STORAGE ROOMS. INSTALLATION: 1/4 TURN FOR PREFERRED PRICING CONTACT: DENNIS SCOTT, ARMSTRONG FLOORING 972.841.2951; dlscott@armstrongflooring.com


BASE SCHEDULE					
B-#	MATERIAL	MRF.	MFR. #	COLOR	REMARKS
B-1	RUBBER	JOHNSONITE	MANDALAY	WHITE	4" STRAIGHT BASE AT CARPET AND COVE AT CONCRETE. CONTINUOUS ROLL. CUTS AT CORNERS ONLY. ENSURE SEAMLESS TRANSITION.
B-2	PORCELAIN TILE (12X24)	T.B.S.	T.B.S.	T.B.S.	AT RESTROOM. INSTALLATION: T.B.D. GROUT: T.B.D.
B-3	RUBBER	T.B.S.	T.B.S.	T.B.S.	4" STRAIGHT BASE AT CARPET AND COVE AT LVT/VCT. CONTINUOUS ROLL. CUTS AT CORNERS ONLY. ENSURE SEAMLESS TRANSITION.

PAINT SCHEDULE					
PT-#	MATERIAL	MRF.	MFR. #	COLOR	REMARKS
PT-1	LATEX	PRATT & LAMBERT	2314-FB	SEED PEARL WHITE	GENERAL PAINT THROUGHOUT, U.N.O. BUILDING STANDARD FINISH
PT-2	LATEX	T.B.S.	T.B.S.	T.B.S.	ACCENT PAINT, BUILDING STANDARD FINISH. VERIFY LOCATION WITH TENANT.
PT-3	LATEX ENAMEL	T.B.S.	T.B.S.	T.B.S.	ELEVATOR DOORS, FRAMES, HOLLOW METAL FRAMES

PLASTIC LAMINATE SCHEDULE					
PL-#	MATERIAL	MRF.	PATTERN/#	COLOR	REMARKS
PL-1	PLASTIC LAMINATE	T.B.S.	T.B.S.	T.B.S.	AT COUNTERTOP AND BACKSPLASH
PL-2	PLASTIC LAMINATE	T.B.S.	T.B.S.	T.B.S.	AT BASE AND UPPER CABINETS


WALLCOVERING SCHEDULE					
WC-#	MATERIAL	MRF.	PATTERN/#	COLOR	REMARKS
WC-1	PORCELAIN TILE (12X24)	T.B.S.	T.B.S.	T.B.S.	AT RESTROOM. INSTALLATION: T.B.D. GROUT: T.B.D.

FINISH PLAN LEGEND	
SYMBOL	DESCRIPTION
NAME 000	ROOM NAME/NUMBER
XX.X	FINISH SPECIFICATION
WC.X	WALL FINISH SPECIFICATION
*-*	FLOOR FINISH TRANSITION, 'E' INDICATES EXISTING TO REMAIN
↔	FLOORING DIRECTION
ⓧ	NOTE REFERENCE
ALL SYMBOLS NOT NECESSARILY USED	

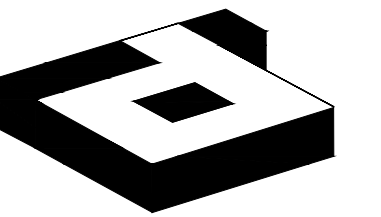

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DALLAS, TEXAS 75207  
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PROJECT NO.: 580-004  
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TENANT R.S.F.: 9,452

**BILLINGSLEY**  
COMPANY

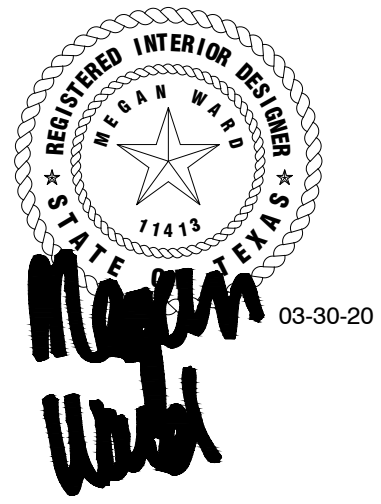3401 OLYMPUS  
ARTISAN DESIGN GROUP

3401 OLYMPUS BLVD.  
SUITE #450  
DALLAS, TX 75019

NO.	ISSUED FOR:	DATE:
△	REVISION 1	04/17/20
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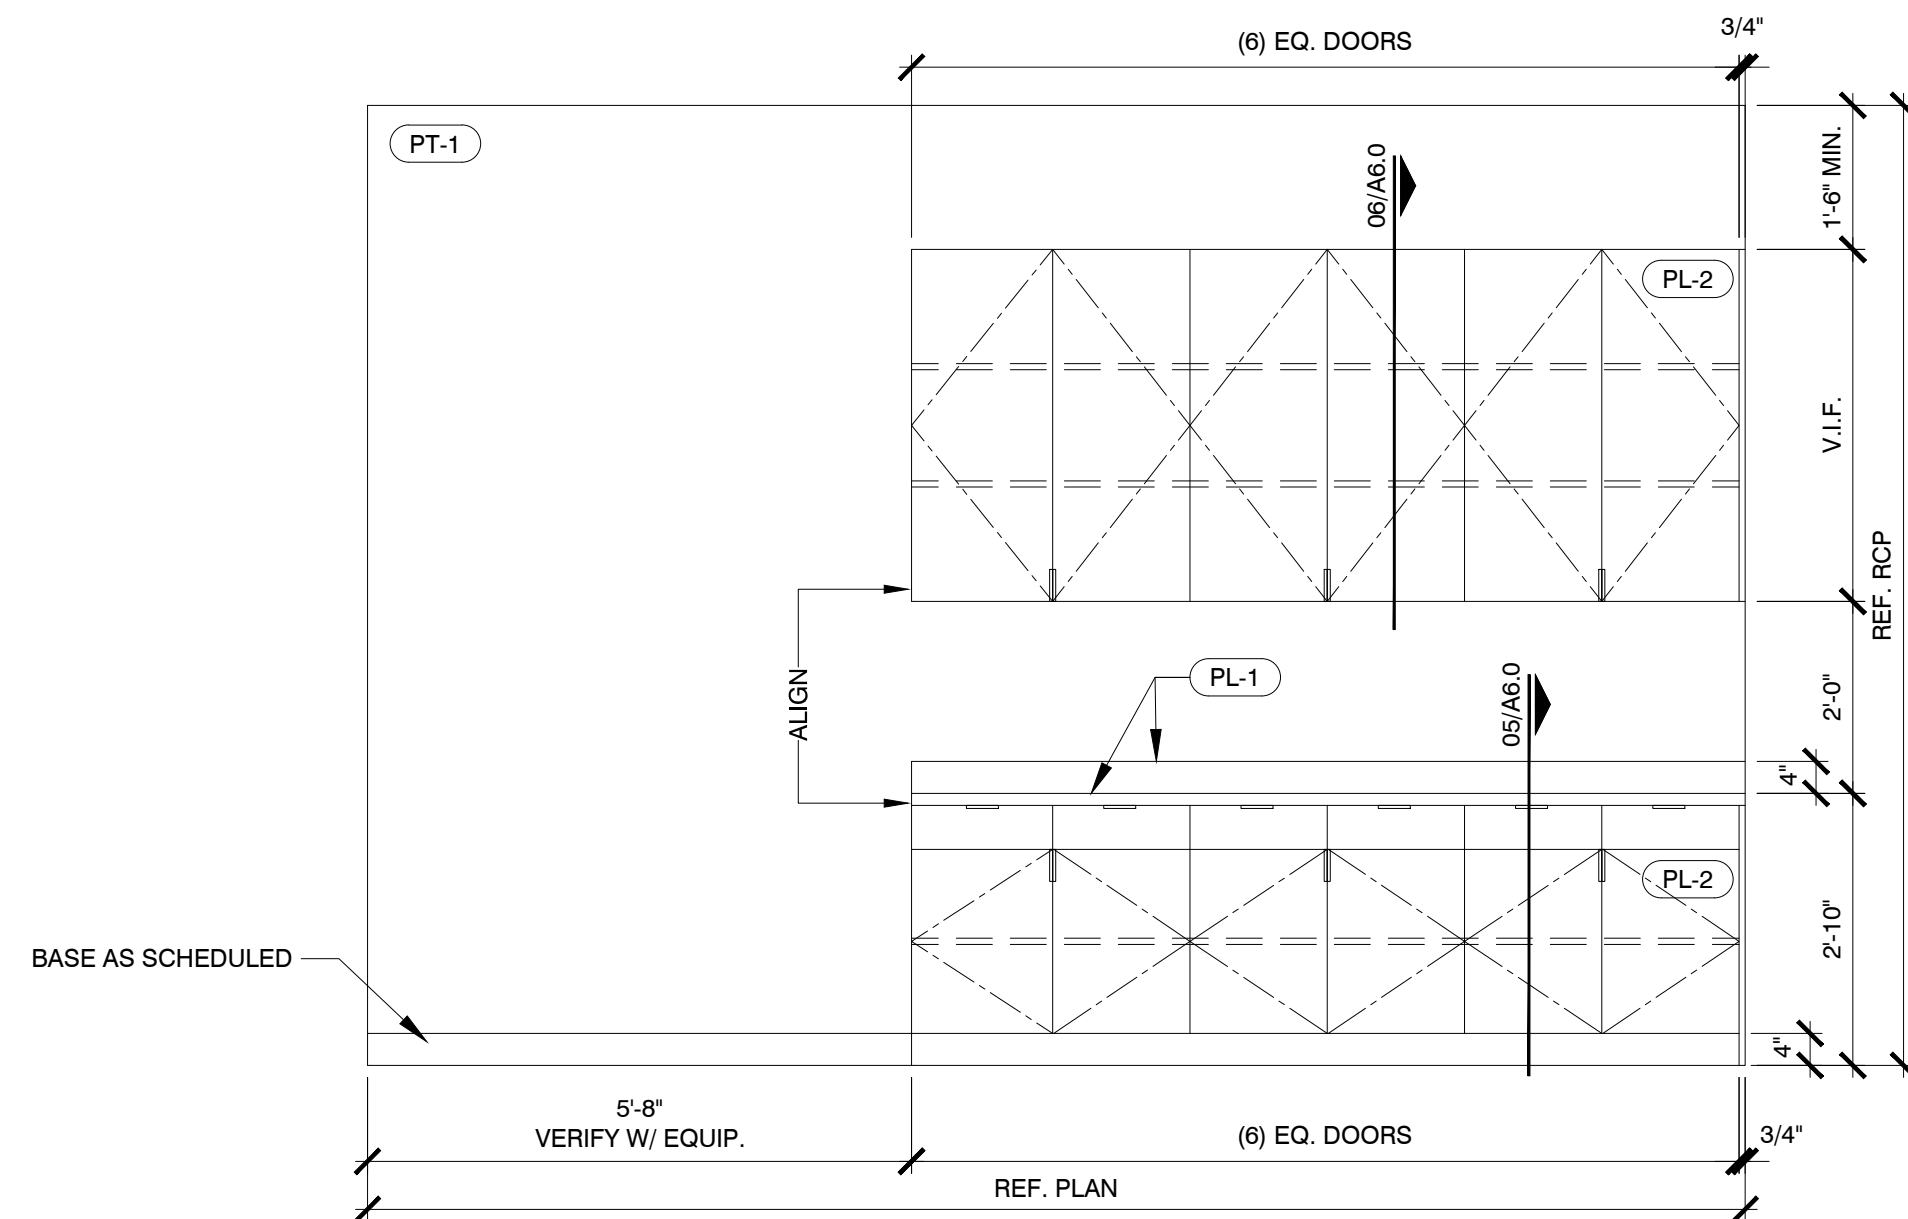
LANDLORD/CLIENT REVIEW ISSUE DATE: 03/30/20  
BID ISSUE DATE: 03/30/20  
CONSTRUCTION ISSUE DATE: 03/30/20

DRAWING TITLE:  
**INTERIOR ELEVATIONS  
& SECTIONS**


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**A6.0**


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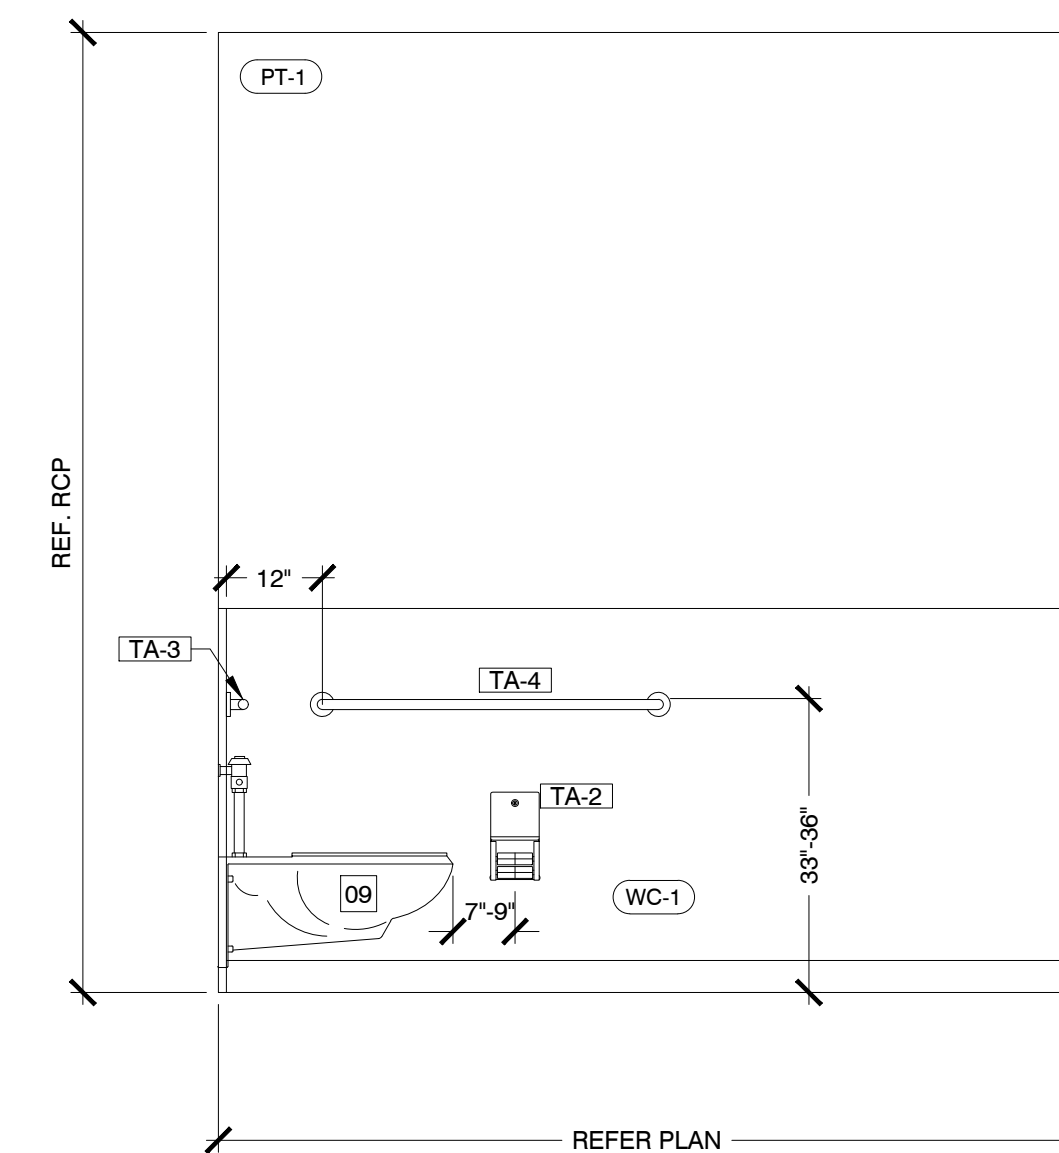
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SCALE: 1/2" = 1'-0"




**02 ELEVATION @ ENTRY**  
SCALE: 1/2" = 1'-0"

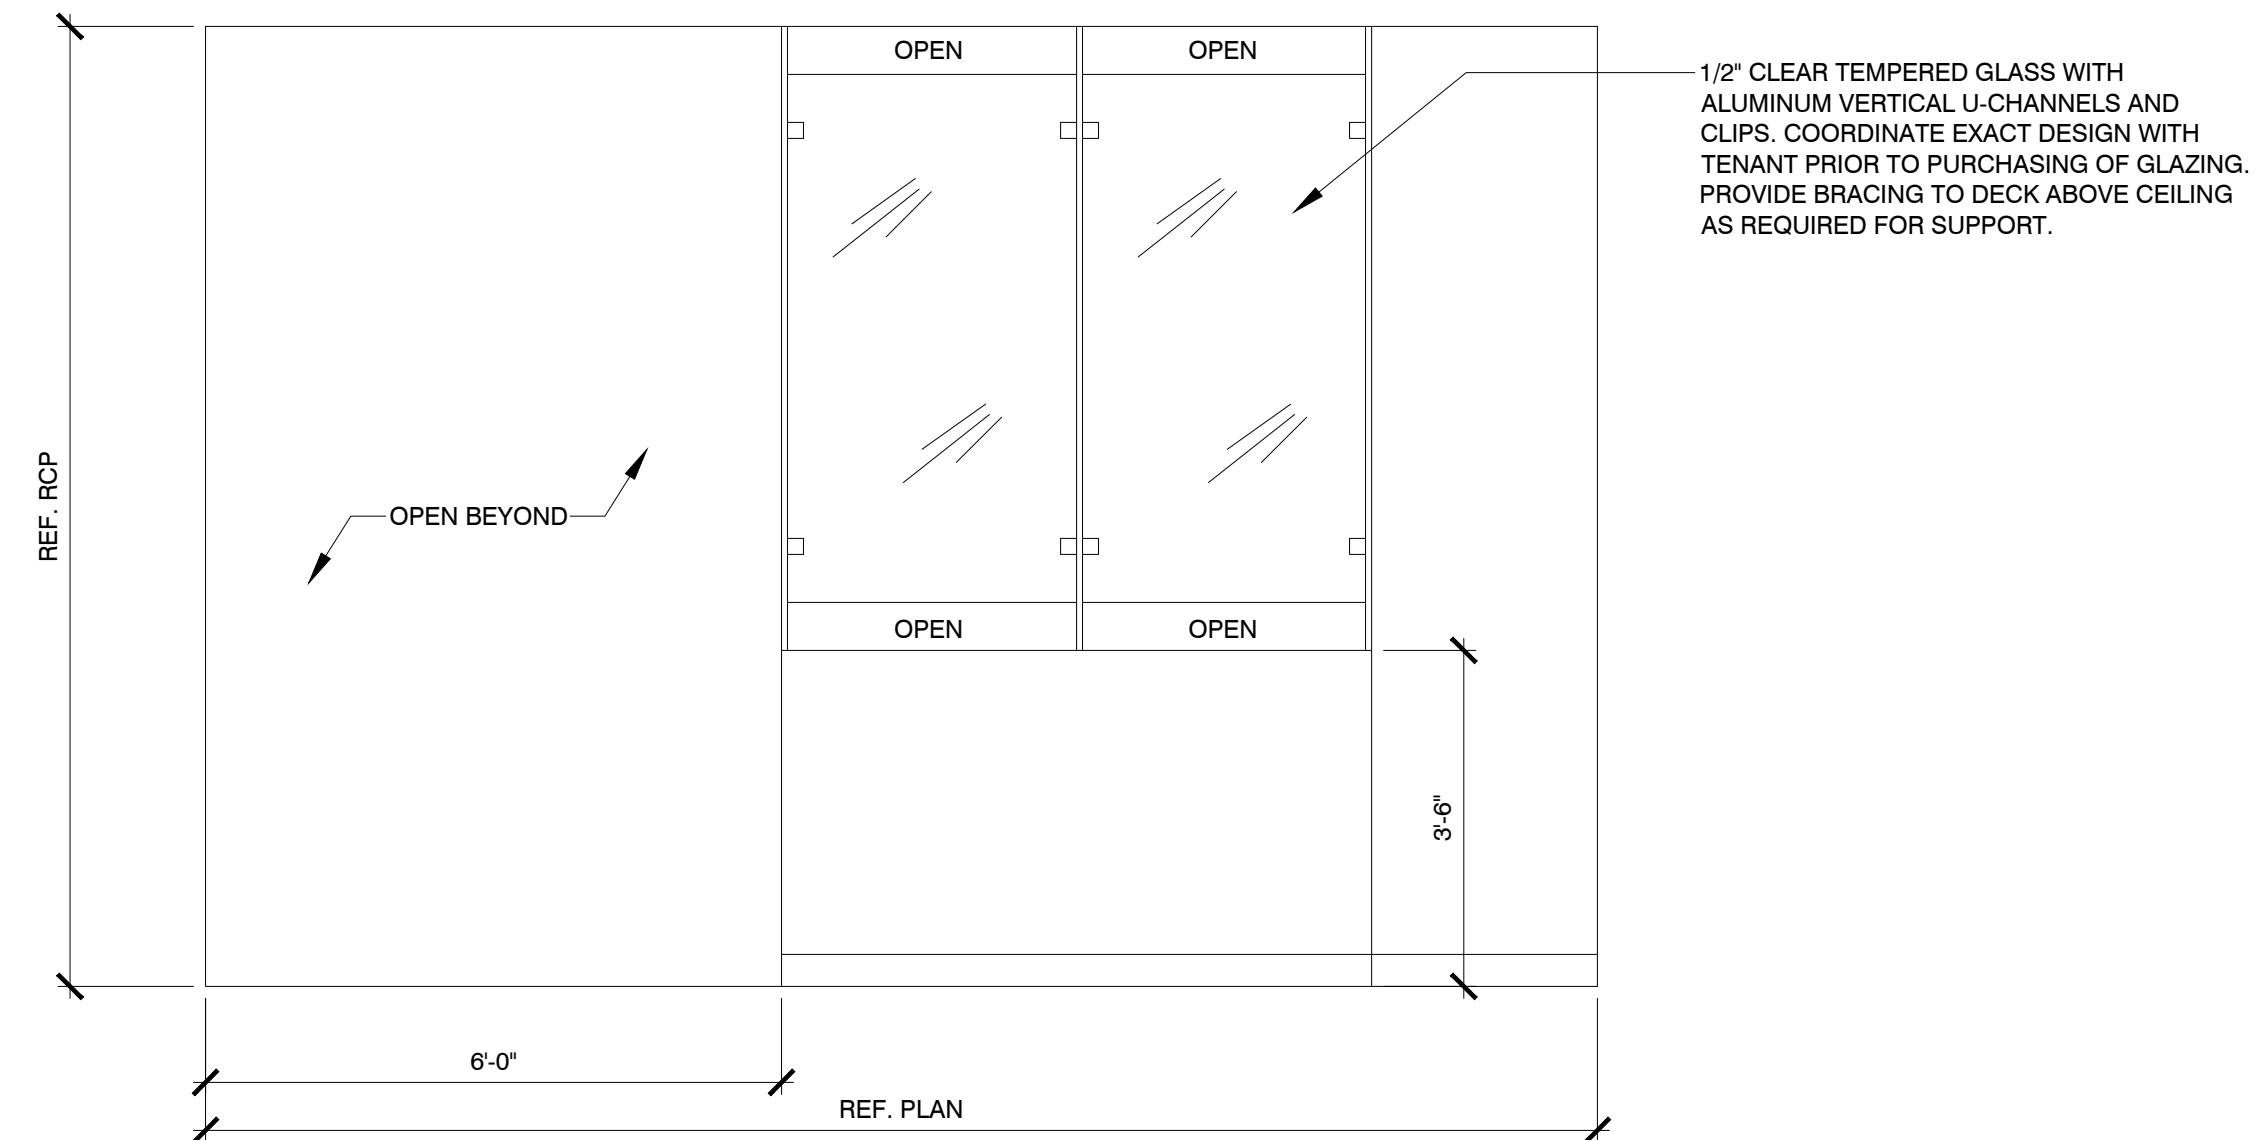


**03 ELEVATION @ RESTROOM**  
SCALE: 1/2" = 1'-0"

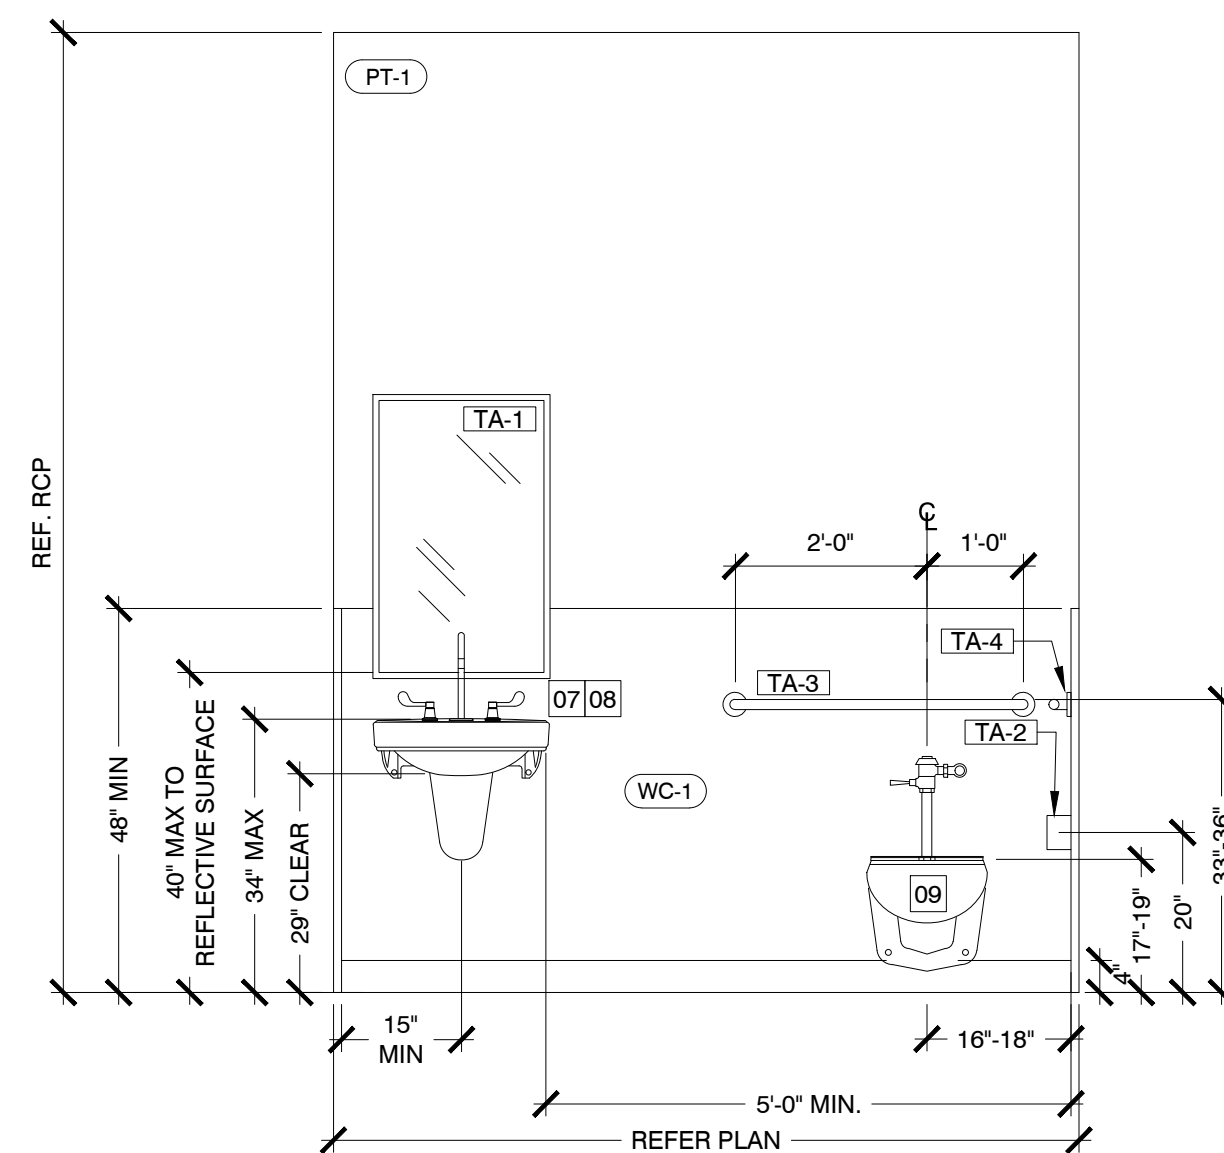


**04 ELEVATION @ RESTROOM**  
SCALE: 1/2" = 1'-0"

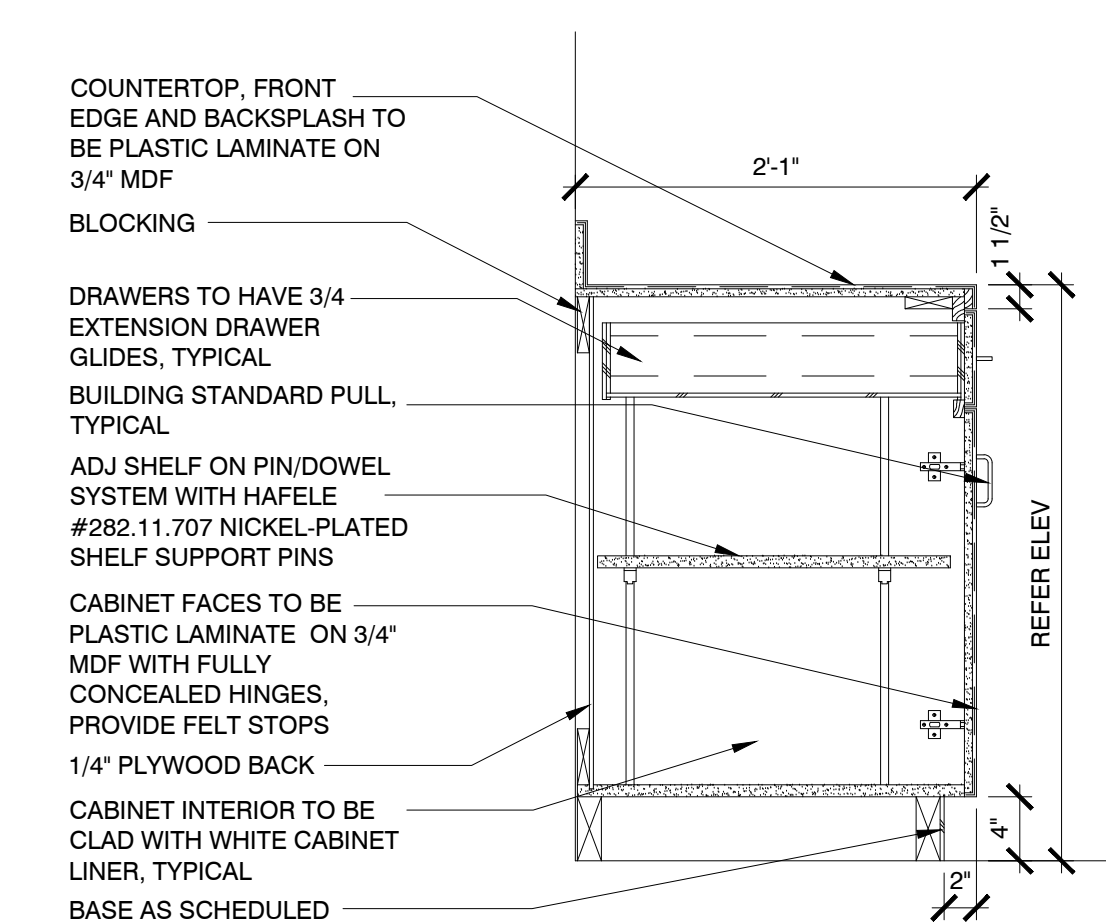

**05 BASE CAB. SECTION**  
SCALE: 1" = 1'-0"

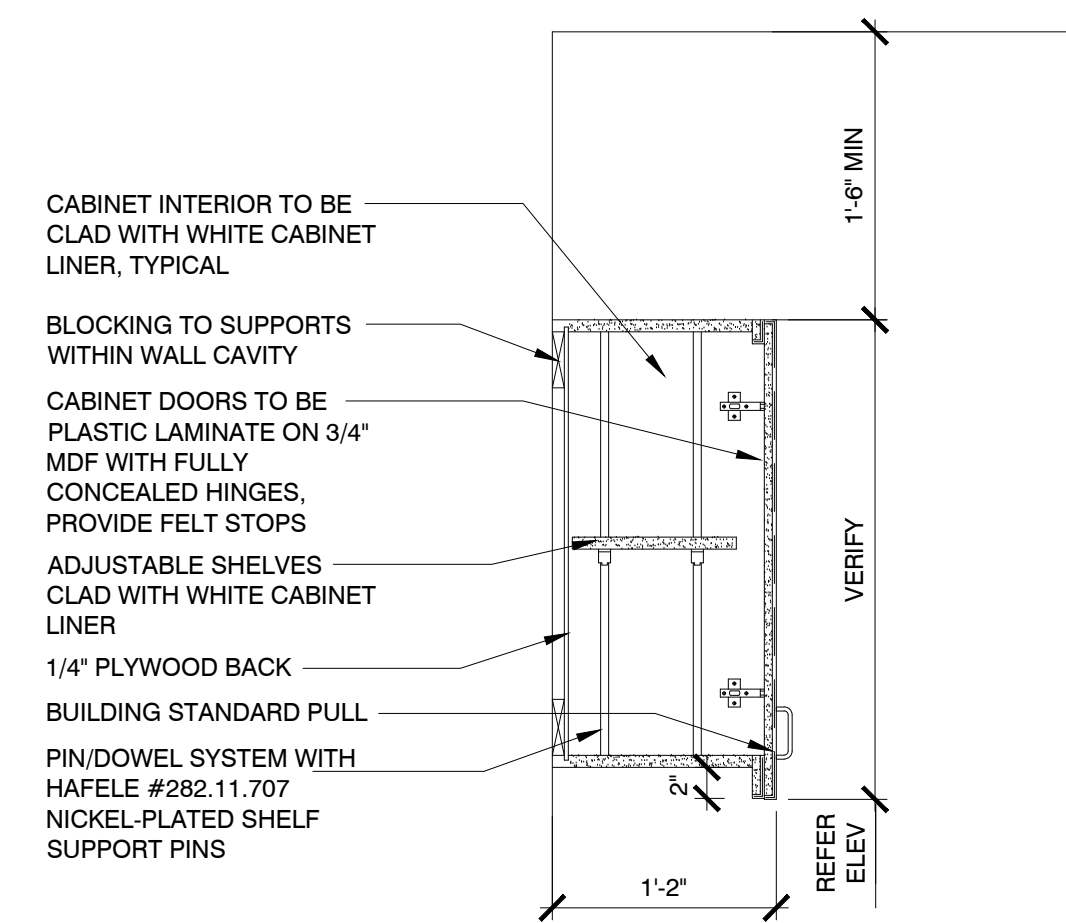

**06 UPPER CAB. SECTION**  
SCALE: 1" = 1'-0"

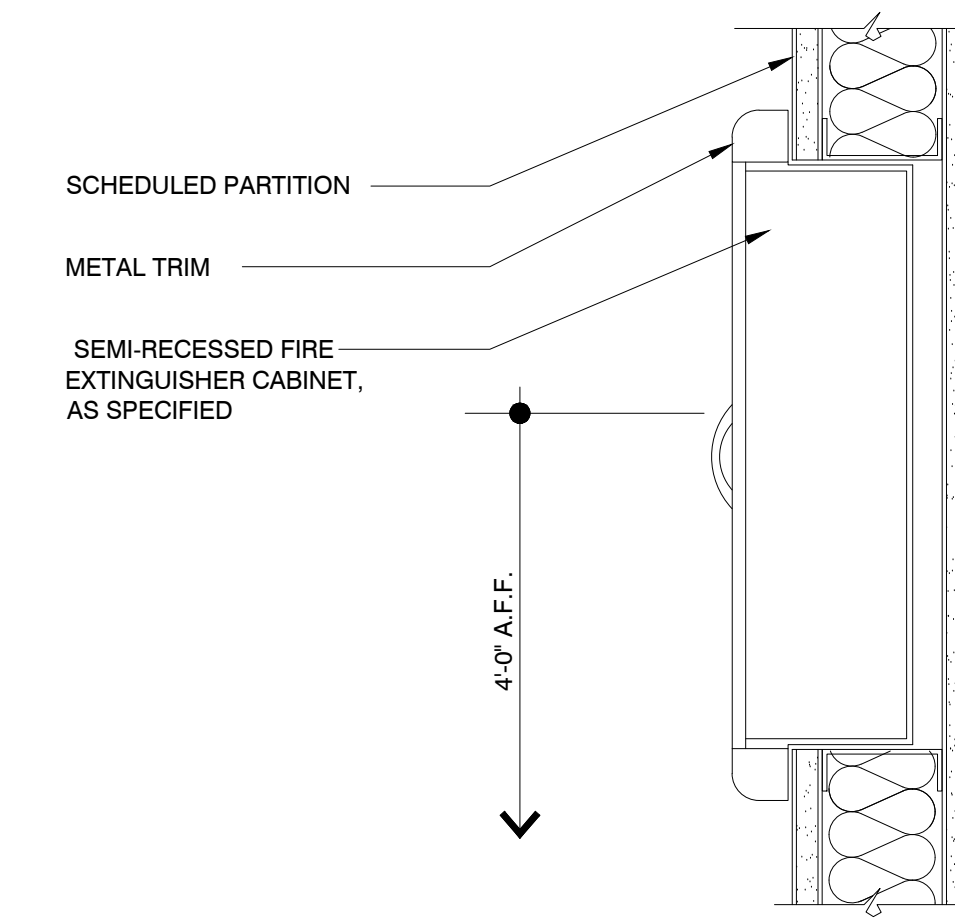


**07 SEMI-RECESSED FEC**  
SCALE: 3" = 1'-0"


ACCESSORY SCHEDULE					
KEY	ITEM	MRF.	MODEL	COLOR/FIN.	DESCRIPTION
TA-1	MIRROR	BOBRICK	B-165 SERIES		CHANNEL FRAMED, 24 X 36
TA-2	TOILET TISSUE DISPENSER	BOBRICK	B-2888	STAINLESS STEEL	SURFACE MOUNTED, STACKED MULTI ROLL
TA-3	GRAB BAR	BOBRICK	B-6806 SERIES	STAINLESS STEEL	36" LONG, CONCEALED MOUNTING
TA-4	GRAB BAR	BOBRICK	B-6806 SERIES	STAINLESS STEEL	42" LONG, CONCEALED MOUNTING

**GENERAL PARTITION TYPE NOTES**


1. TYPICAL PARTITION TO BE TYPE "3X", UNLESS NOTED OTHERWISE ON CONSTRUCTION PLAN.
2. CONTRACTOR TO VERIFY STUD GAUGE REQUIRED.
3. CONTRACTOR TO VERIFY BUILDING STANDARD STUD WIDTH WITH BUILDING MANAGEMENT.

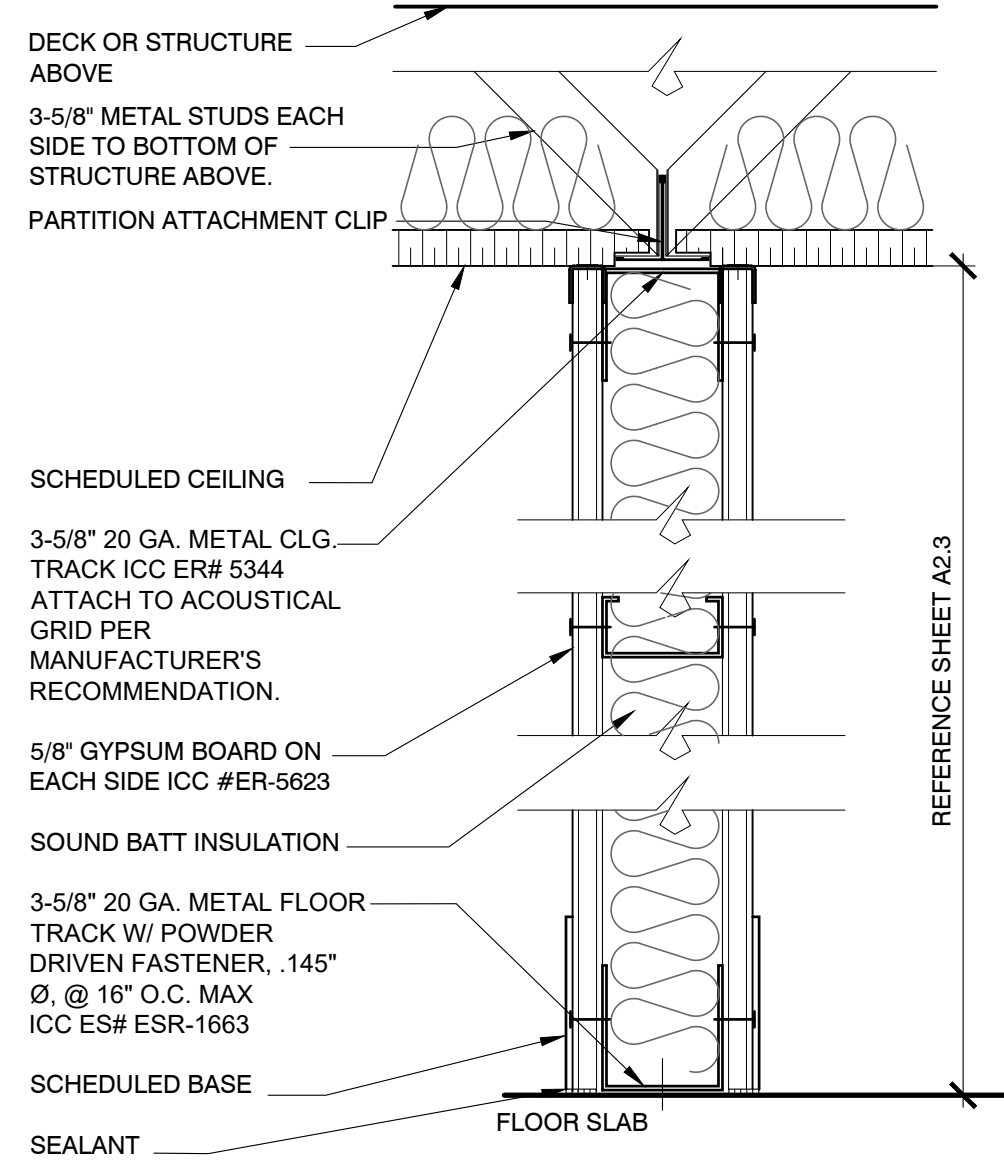


- 2** 3-5/8" x 20 GA. METAL STUD @ 16" O.C., BUILDING STANDARD, U.O.N., PARTITION FROM SLAB TO UNDERSIDE OF CEILING. FACE WITH 5/8" GYPSUM BOARD, EACH SIDE, TO CEILING. FINISH AS SCHEDULED.
- 2X** AT WALL TYPE 2, PROVIDE SOUND BATT INSULATION WHERE INDICATED WITH AN "X".

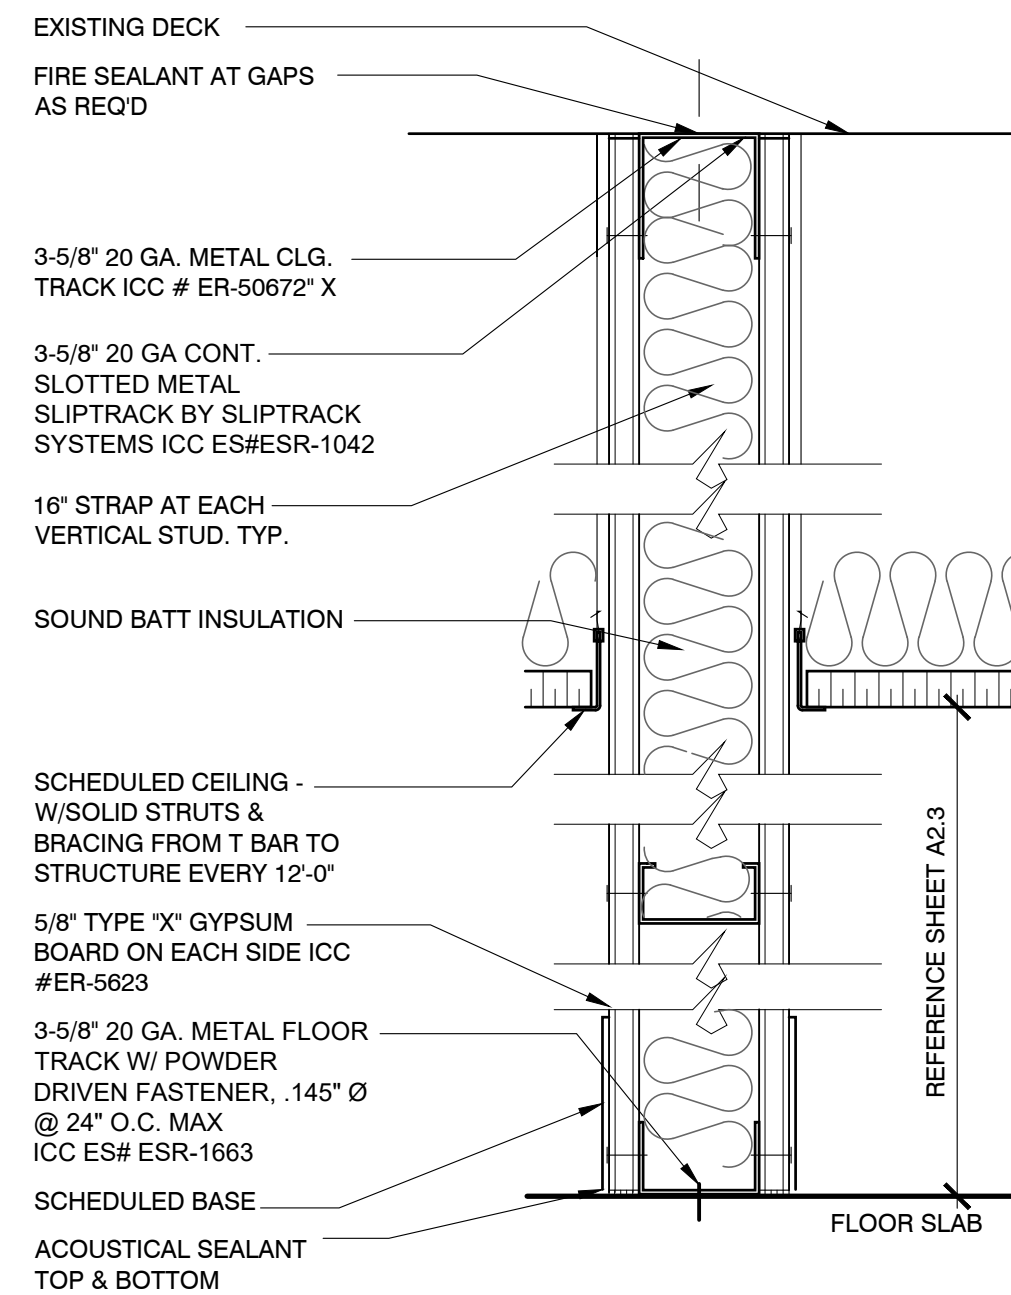

- 3** 3-5/8" x 20 GA. METAL STUD @ 24" O.C., U.O.N., PARTITION FROM SLAB TO DECK. FACE WITH 5/8" TYPE "X" GYPSUM BOARD. FINISH AS SCHEDULED.
- 3X** AT WALL TYPE 3 WHERE INDICATED WITH AN "X", PROVIDE SOUND BATT INSULATION.
- 3F** 1 HOUR FIRE RATED AT WALL TYPE 3, WHERE INDICATED WITH AN "F", PROVIDE SOUND BATT INSULATION AND FIRE SEALANT AT GAPS (UL419).
- 3P** SAME AS WALL TYPE "3X" WITH 6" STUDS.

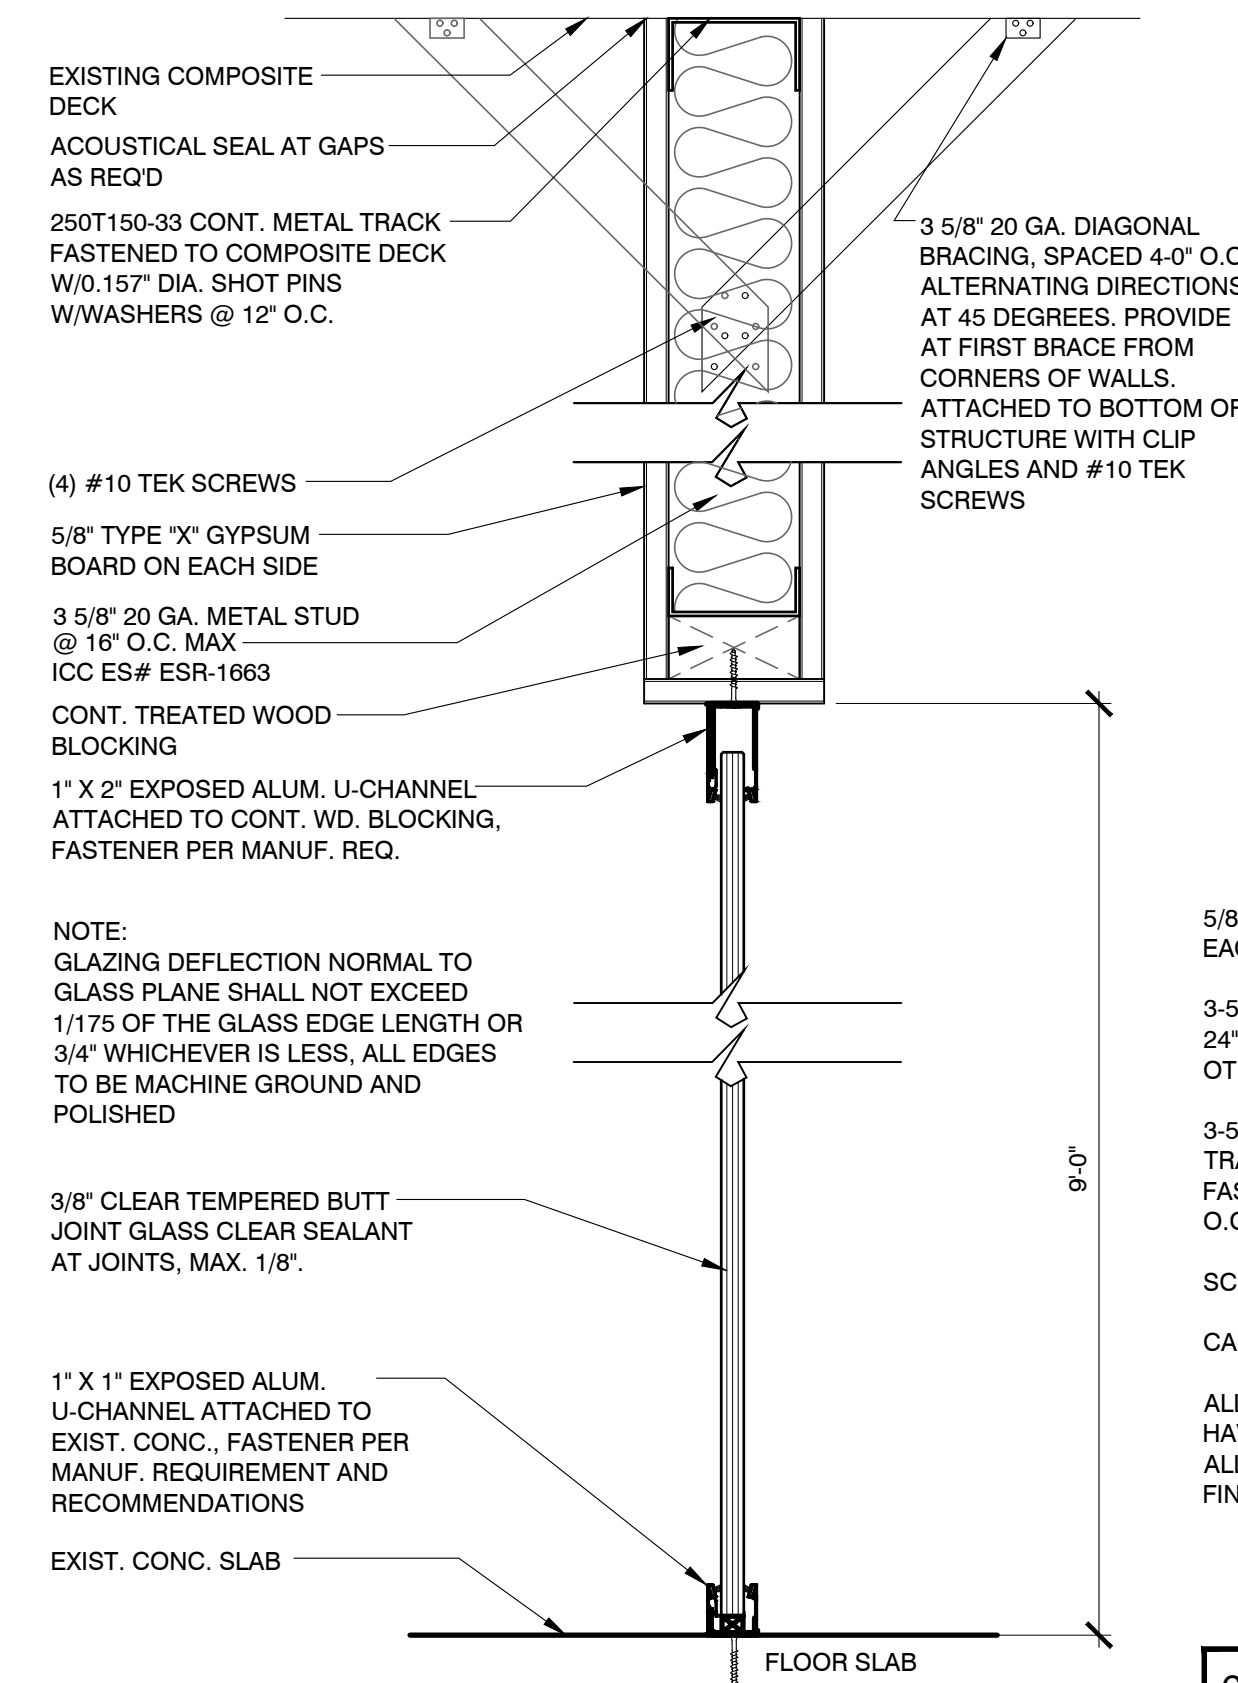


- 5** TEMPERED GLASS PARTITION FROM SLAB TO DECK. FINISH AS SCHEDULED.
- 5X** AT WALL TYPE 5 WHERE INDICATED WITH AN "X", PROVIDE SOUND BATT INSULATION.





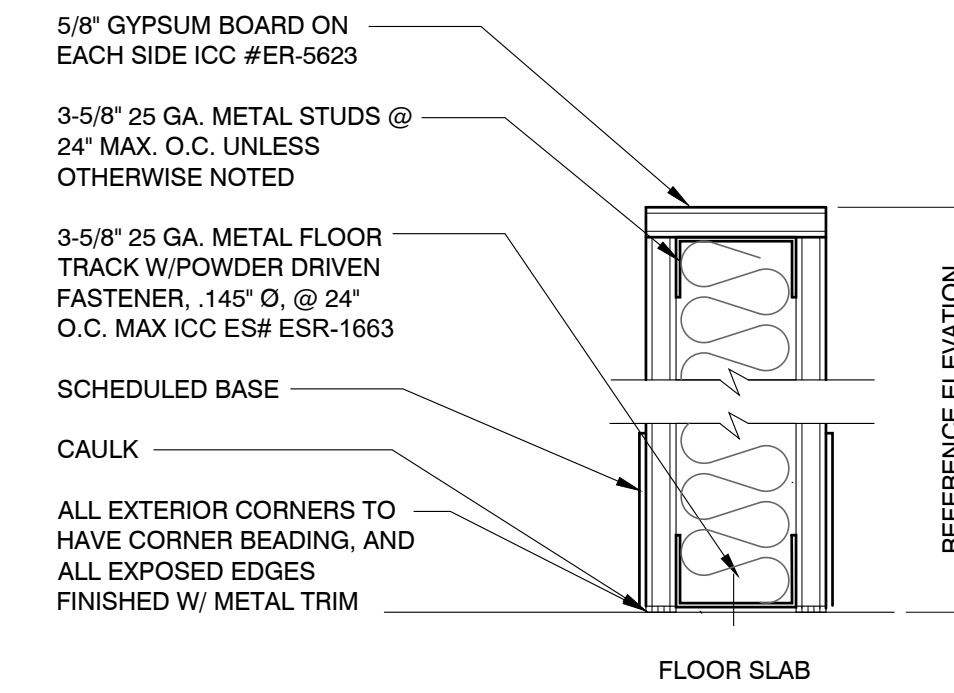


- 6X** 3-5/8" x 25 GA. METAL STUD @ 24" O.C., U.O.N., LOW WALL PARTITION. FACE WITH 5/8" GYPSUM BOARD FINISH AS SCHEDULED.


**DOOR TYPES:**

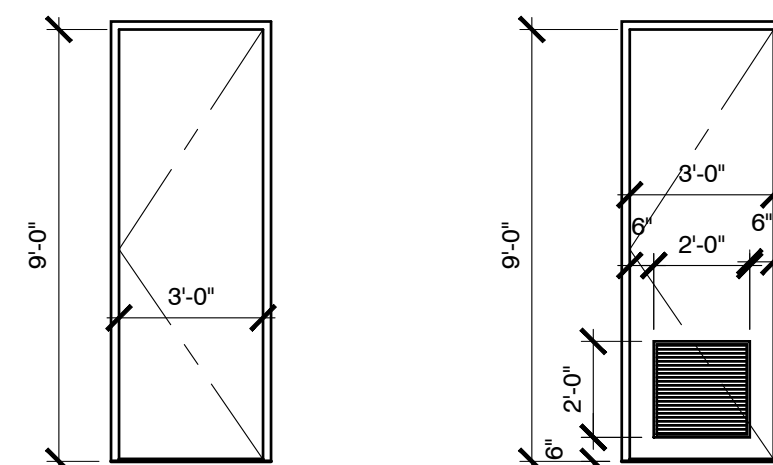


**B**  
BLDG STANDARD DOOR WITH VENT  
BLDG STANDARD FRAME

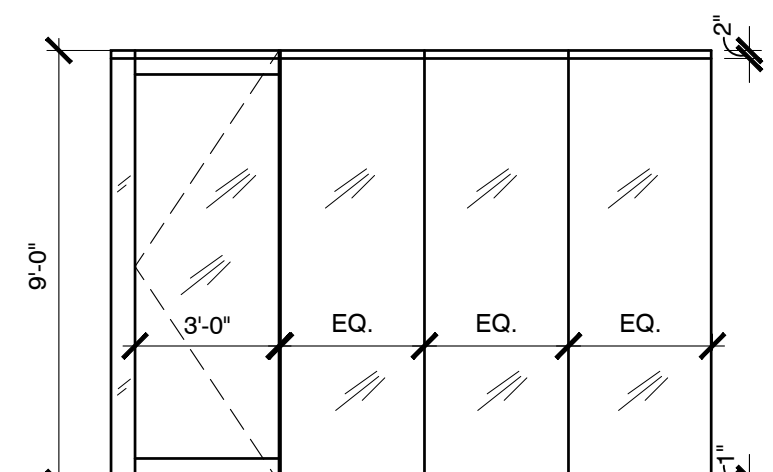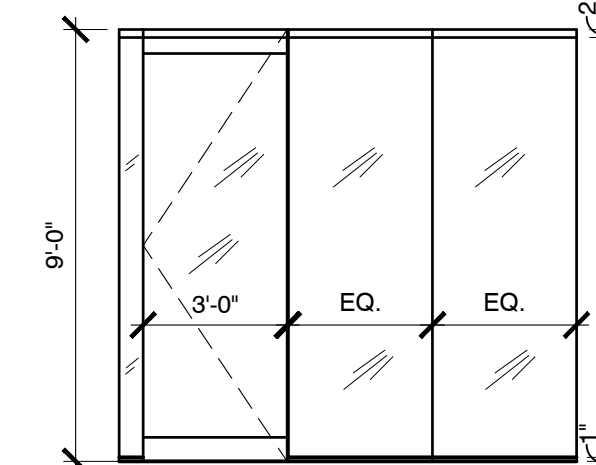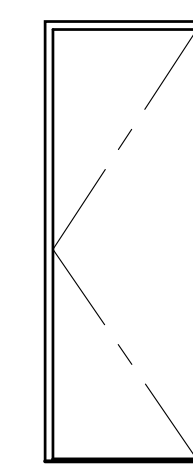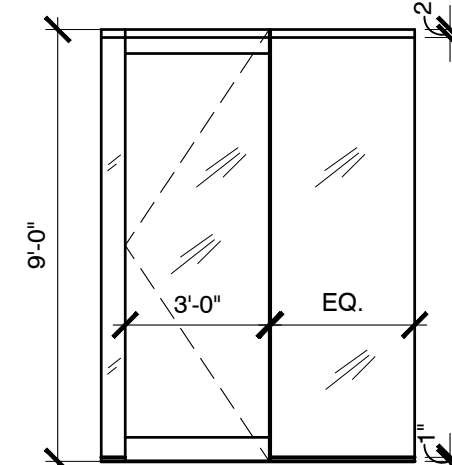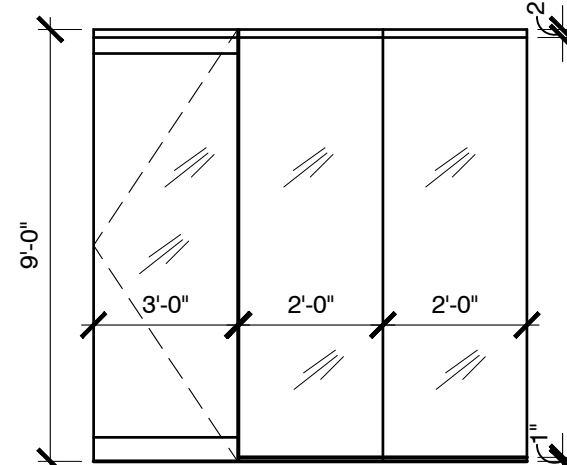

**H**  
BUILDING STANDARD TEMPERED GLASS DOOR W/4" CONT. HEAD & SHOE LEADING EDGE OF BOTTOM RAIL TO BE TAPERED 60" MINIMUM FROM HORIZONTAL AND SIDELIGHT IN EXPOSED U-CHANNELS

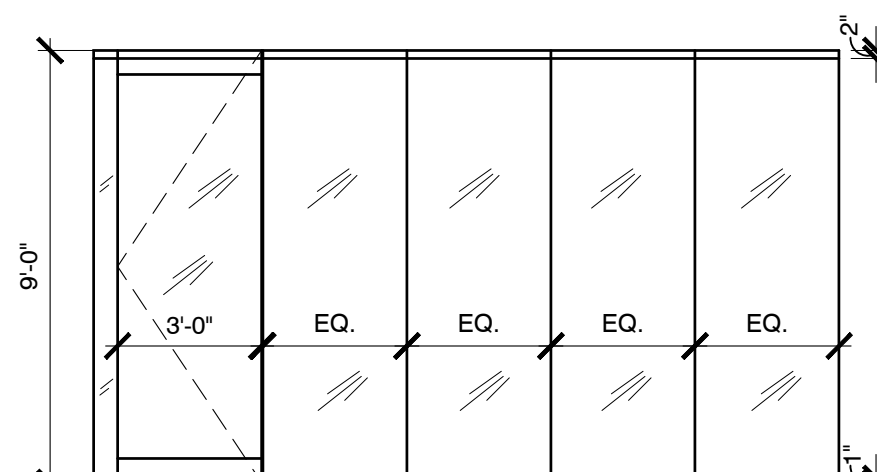

**I**  
BUILDING STANDARD TEMPERED GLASS DOOR W/4" CONT. HEAD & SHOE LEADING EDGE OF BOTTOM RAIL TO BE TAPERED 60" MINIMUM FROM HORIZONTAL AND SIDELIGHT IN EXPOSED U-CHANNELS

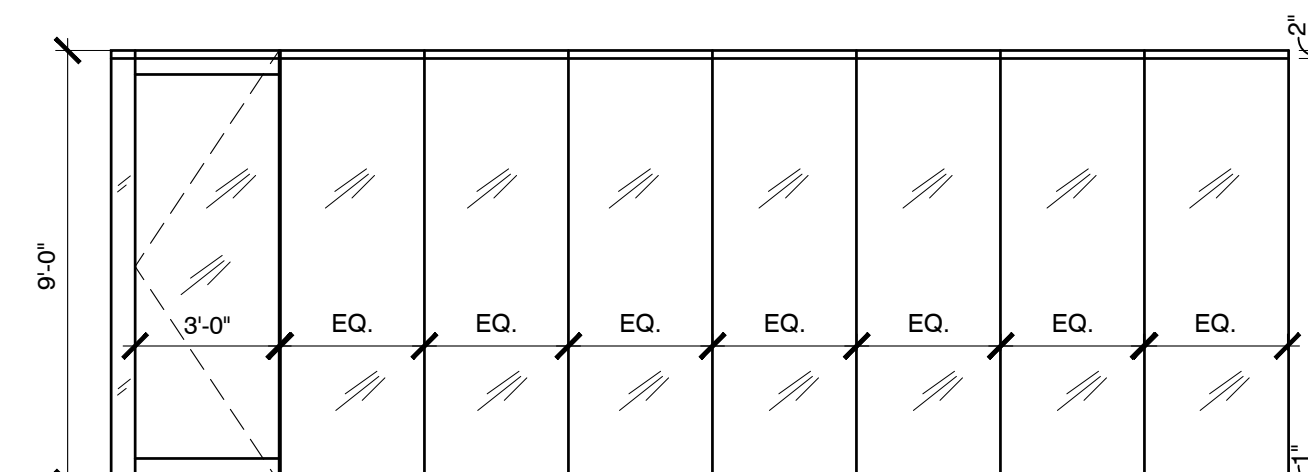

DOOR HARDWARE SCHEDULE	
a	PASSAGE SET
b	PASSAGE SET WITH EXPOSED CLOSER. PROVIDE 36" LONG TUBULAR PULLS (EACH SIDE) MOUNTED AT 42" A.F.F. TO CENTER
c	THUMB TURN LOCK AT BOTTOM RAIL WITH EXPOSED CLOSER. PROVIDE 36" LONG TUBULAR PULLS (EACH SIDE) MOUNTED AT 42" A.F.F. TO CENTER
d	STOREROOM LOCKSET
e	EXISTING HARDWARE TO REMAIN
f	PRIVACY LOCKSET WITH CLOSER
g	MAG LOCK W/ EXPOSED CLOSER, PUSH BUTTON RELEASE & POWER SOURCE FOR TENANT-PROVIDED SECURITY SYSTEM. PROVIDE 36" LONG TUBULAR PULLS (EACH SIDE) MOUNTED AT 42" A.F.F. TO CENTER
h	ELECTRIC STRIKE W/ LOCKSET & CLOSER, PUSH BUTTON RELEASE & POWER SOURCE FOR TENANT-PROVIDED SECURITY SYSTEM
i	OFFICE LOCKSET WITH CLOSER

**GENERAL DOOR/HARDWARE NOTES:**

1. HARDWARE TO BE BUILDING STANDARD "LEVER" TYPE ADA/TAS COMPLIANT, U.O.N. COORDINATE WITH BUILDING MANAGEMENT.
2. CLOSERS TO BE ADJUSTED TO MEET ADA/TAS STANDARDS. DOORS SHALL CLOSE FROM AN OPEN POSITION OF 70 DEGREES TO A POINT 3" FROM LATCH IN A MINIMUM OF (3) THREE SECONDS AND SHALL REQUIRE A MAXIMUM OF (5) POUNDS OF FORCE (lb) TO OPEN.
3. KEYS: LOCKSETS TO ALL ROOMS TO BE KEYED TO MASTER. CONTRACTOR TO COORDINATE WITH BLDG. MGMT. FOR QUANTITY OF MASTER SETS TO BE PROVIDED.
4. KEYWAY: COORDINATE WITH BUILDING MANAGEMENT FOR MASTER KEY AND GRANDMASTER KEY SYSTEM COMPLIANCE.
5. ALL ELECTRICAL DOOR HARDWARE AND ACCESSORIES FOR INFORMATION ONLY. COORDINATE WITH SECURITY CONSULTANT AND BLDG. MGMT. FOR FINAL SELECTION.
6. ALL DOOR HARDWARE AND ACCESSORIES TO MATCH BUILDING STANDARDS, U.O.N.
7. PROVIDE DOOR FINISH SAMPLE TO BLDG. MGMT. FOR REVIEW AND APPROVAL PRIOR TO ORDERING.
8. ALL GLASS THICKNESS TO BE TO CODE AND DETERMINED BY GLASS VENDOR
9. REFERENCE PLAN FOR DOOR SWING DIRECTIONS. DOOR TYPES ARE FOR VISUAL PURPOSES ONLY.



2641 IRVING BLVD.  
DALLAS, TEXAS 75207  
TEL: 214-638-6800 FAX: 214-689-0301



PROJECT NO.: 580-004  
DRAWN BY: RH  
CHECKED BY: MW  
TENANT R.S.F.: 9.452



3401 OLYMPUS ARTISAN DESIGN GROUP

3401 OLYMPUS BLVD.  
SUITE #450  
DALLAS, TX 75019

NO.	ISSUED FOR:	DATE:
1	REVISION 1	04/17/20

LANDLORD/CLIENT REVIEW ISSUE DATE: 03/30/20  
 BID ISSUE DATE: 03/30/20  
 CONSTRUCTION ISSUE DATE: 03/30/20

DRAWING TITLE:  
**PARTITION & DOOR TYPES**

DRAWING NUMBER:  
**A7.0**

# DALLAS GREEN BLDG REQ.

SECTION 802.1 SCOPE. TO FACILITATE THE OPERATION AND MAINTENANCE OF THE COMPLETED BUILDING, THE BUILDING AND ITS SYSTEMS SHALL COMPLY WITH THE REQUIREMENTS OF SECTIONS 802.2 AND 802.3.

802.2 AIR HANDLING SYSTEM ACCESS: THE ARRANGEMENT AND LOCATION OF AIR HANDLING SYSTEM COMPONENTS, INCLUDING, BUT NOT LIMITED TO, DUCTS, AIR HANDLING UNITS, FANS, COILS, AND CONDENSATE PANS, SHALL ALLOW ACCESS FOR CLEANING AND REPAIR OF AIR HANDLING SURFACES OF SUCH COMPONENTS ACCESS PORTS SHALL BE INSTALLED IN THE AIR HANDLING SYSTEM TO PERMIT SUCH CLEANING AND REPAIRS. PIPING, CONDUITS, AND OTHER BUILDING COMPONENTS SHALL NOT BE LOCATED SO AS TO OBSTRUCT THE REQUIRED ACCESS PORTS.

802.3 AIR HANDLING SYSTEM FILTRATION AND BYPASS PATHWAYS: AIR HANDLING EQUIPMENT AND HVAC EQUIPMENT SHALL BE DESIGNED AND INSTALLED TO LIMIT THE AMOUNT OF AIRFLOW THAT BY PASSES THE AIR FILTERS AND SHALL COMPLY WITH THE FOLLOWING:

- CHANNELS, RACKS AND OTHER FILTER-RETAINING CONSTRUCTIONS THAT DO NOT SEAL TIGHTLY TO THE FILTER FRAME BY MEANS OF FRICTION FIT SHALL BE PROVIDED WITH A MEANS TO SEAL THE FILTER FRAME TO THE FILTER-HOLDING CONSTRUCTION.
- WHERE STANDARD SIZE FILTERS ARE INSTALLED IN BANKS OF MULTIPLE FILTERS, GASKETS SHALL SEAL THE GAP BETWEEN THE FRAMES OF ADJACENT FILTERS.
- AS AN ALTERNATIVE TO GASKETS, THE FRAMES OF ADJACENT FILTERS SHALL BE COMPRESSED TIGHTLY TOGETHER BY MEANS OF SPRING ELEMENTS THAT ARE BUILT INTO THE FILTER RETAINING CONSTRUCTION.
- CHANNELS, RACKS AND OTHER FILTER-RETAINING CONSTRUCTIONS SHALL BE SEALED TO THE DUCT OR HOUSING OF THE HVAC EQUIPMENT SERVED BY THE FILTERS.
- FILTER ACCESS DOORS IN DUCTS AND HVAC EQUIPMENT SHALL BE DESIGNED TO LIMIT THE AMOUNT OF AIRFLOW THAT BYPASSES THE FILTERS.
- FIELD OR SHOP-FABRICATED SPACERS SHALL NOT BE INSTALLED FOR THE PURPOSE OF REPLACING THE INTENDED SIZE FILTER WITH A SMALLER SIZE FILTER.
- GASKETS AND SEALS SHALL BE ACCESSIBLE FOR REPAIR, MAINTENANCE AND REPLACEMENT.

803.1 CONSTRUCTION PHASE REQUIREMENTS. THE VENTILATION OF BUILDINGS DURING THE CONSTRUCTION PHASE SHALL BE IN ACCORDANCE WITH SECTIONS 803.1.1 THROUGH 803.1.3.

803.1.1 DUCT OPENINGS. DUCT AND OTHER RELATED AIR DISTRIBUTION COMPONENT OPENINGS SHALL BE COVERED WITH TAPE, PLASTIC, SHEET METAL, OR SHALL BE CLOSED BY AN APPROVED METHOD TO REDUCE THE AMOUNT OF DUST AND DEBRIS THAT COLLECTS IN THE SYSTEM FROM THE TIME OF ROUGH-IN INSTALLATION AND UNTIL STARTUP OF THE HEATING AND COOLING EQUIPMENT. DUST AND DEBRIS SHALL BE CLEANED FROM DUCT OPENINGS PRIOR TO SYSTEM FLUSH OUT AND BUILDING OCCUPANCY.

803.1.2 INDOOR AIR QUALITY DURING CONSTRUCTION. TEMPORARY VENTILATION DURING CONSTRUCTION SHALL BE PROVIDED IN ACCORDANCE WITH SECTION 803.1.2.1 THROUGH 803.1.2.3.

803.1.2.1 VENTILATION. VENTILATION DURING CONSTRUCTION SHALL BE ACHIEVED THROUGH OPENINGS IN THE BUILDING ENVELOPE USING ONE OR MORE OF THE FOLLOWING METHODS:

- NATURAL VENTILATION IN ACCORDANCE WITH THE PROVISIONS OF THE INTERNATIONAL BUILDING CODE OR THE INTERNATIONAL MECHANICAL CODE.
- FANS THAT PRODUCE A MINIMUM OF THREE AIR CHANGES PER HOUR.
- EXHAUST IN THE WORK AREA AT A RATE OF NOT LESS THAN 0.05 CFM/FT<sup>2</sup> (0.24 L/S/IN<sup>2</sup>) AND NOT LESS THAN 10 PERCENT GREATER THAN THE SUPPLY AIR RATE SO AS TO MAINTAIN NEGATIVE PRESSURIZATION OF THE SPACE.

803.1.2.2 PROTECTION OF HVAC SYSTEM OPENINGS. HVAC SUPPLY AND RETURN DUCT AND EQUIPMENT OPENINGS SHALL BE PROTECTED DURING DUST-PRODUCING OPERATIONS.

803.1.2.3 RETURN AIR FILTERS. WHERE A FORCED AIR HVAC SYSTEM IS USED DURING CONSTRUCTION, NEW RETURN AIR FILTERS SHALL BE INSTALLED PRIOR TO SYSTEM FLUSH OUT AND BUILDING OCCUPANCY.

803.1.3 CONSTRUCTION PHASE DUCTLESS SYSTEM OR FILTER. WHERE SPACES ARE CONDITIONED DURING THE CONSTRUCTION PHASE, SPACE CONDITIONING SYSTEMS SHALL BE OF THE DUCTLESS VARIETY, OR FILTERS FOR THE DUCTED SYSTEMS SHALL BE RATED AT MERV 8 OR HIGHER IN ACCORDANCE WITH ASHRAE 52.2, AND SYSTEM EQUIPMENT SHALL BE DESIGNED TO BE COMPATIBLE. DUCT SYSTEM DESIGN SHALL ACCOUNT FOR PRESSURE DROP ACROSS THE FILTER.

803.2 THERMAL ENVIRONMENTAL CONDITIONS FOR HUMAN OCCUPANCY. BUILDING SHALL BE DESIGNED IN COMPLIANCE WITH ASHRAE 55, SECTIONS 6.1, "DESIGN" AND 6.2, "DOCUMENTATION."

EXCEPTION: SPACES WITH SPECIAL REQUIREMENTS FOR PROCESSES, ACTIVITIES, OR CONTENTS THAT REQUIRE A THERMAL ENVIRONMENT OUTSIDE OF THAT WHICH HUMANS FIND THERMALLY ACCEPTABLE, SUCH AS FOOD STORAGE, NATATORIUMS, SHOWER ROOMS, SAUNAS AND DRYING ROOMS.

803.3 ISOLATION OF POLLUTANT SOURCES. THE ISOLATION OF POLLUTANT SOURCES RELATED TO PRINT, COPY AND JANITORIAL ROOMS, GARAGES AND HANGERS SHALL BE IN ACCORDANCE WITH SECTION 803.3.1.

803.3.1 PRINTER, COPIER AND JANITORIAL ROOMS. ENCLOSED ROOMS OR SPACES THAT ARE OVER 100 SQUARE FEET (9.3 M<sup>2</sup>) IN AREA AND THAT ARE USED PRIMARILY AS A PRINT OR COPY FACILITY CONTAINING FIVE OR MORE PRINTERS, COPY MACHINES, SCANNERS, FACSIMILE MACHINES OR SIMILAR MACHINES IN ANY COMBINATION, AND ROOMS USED PRIMARILY AS JANITORIAL ROOMS OR CLOSETS WHERE THE USE OR STORAGE OF CHEMICALS OCCURS, SHALL COMPLY WITH ALL OF THE FOLLOWING:

- THE ENCLOSING WALLS SHALL EXTEND FROM THE FLOOR SURFACE TO THE UNDERSIDE OF THE FLOOR, ROOF, DECK OR SOLID CEILING ABOVE AND SHALL BE CONSTRUCTED TO RESIST THE PASSAGE OF AIRBORNE CHEMICAL POLLUTANTS AND SHALL BE CONSTRUCTED AND SEALED AS REQUIRED FOR 1-HR FIRE-RESISTANCE-RATED CONSTRUCTION ASSEMBLIES. ALTERNATIVELY, FOR JANITORIAL ROOMS AND CLOSETS, ALL CHEMICALS SHALL BE STORED IN APPROVED CHEMICAL SAFETY STORAGE CABINETS.
- DOORS IN THE ENCLOSING WALLS SHALL BE AUTOMATIC OR SELF-CLOSING.
- AN HVAC SYSTEM SHALL BE PROVIDED THAT PROVIDES SEPARATE EXHAUST AIRFLOW TO THE OUTDOORS AT A RATE OF NOT LESS THAN 0.50 CFM PER SQUARE FOOT (2.4 L/S/M<sup>2</sup>); THAT MAINTAINS A NEGATIVE PRESSURE OF NOT LESS THAN 7 PA WITHIN THE ROOM; AND THAT PROHIBITS THE RECIRCULATION OF AIR FROM THE ROOM TO OTHER PORTIONS OF THE BUILDINGS.

803.4 FILTERS. FILTERS FOR AIR CONDITIONING SYSTEMS THAT SERVE OCCUPIED SPACES SHALL BE RATED AT MERV 11 OR HIGHER, IN ACCORDANCE WITH ASHRAE STANDARD 52.2, AND SYSTEM EQUIPMENT SHALL BE DESIGNED TO BE COMPATIBLE. THE AIR HANDLING SYSTEM DESIGN SHALL ACCOUNT FOR PRESSURE DROP ACROSS THE FILTER. THE PRESSURE DROP ACROSS CLEAN MERV 11 FILTERS SHALL BE NOT GREATER THAN 0.45 IN. W.G. AT 500 FPM (412 PA AT 2.54 M/S) FILTER FACE VELOCITY. FILTER PERFORMANCE SHALL BE SHOWN ON THE FILTER MANUFACTURER'S DATA SHEET.

EXCEPTION: FILTERS FOR AIR CONDITIONING SYSTEMS THAT SERVE OCCUPIED SPACES IN MULTI-FAMILY RESIDENTIAL UNITS OR LIGHT COMMERCIAL SPACES SHALL BE RATED AT MERV 6 FOR SYSTEMS RATED AT 30,000 BTU/H OR LESS AND MERV 8 FOR SYSTEMS RATED OVER 30,000 BTU/H BUT NO GREATER THAN 80,000 BTU/H.

## GRILLES - REGISTERS - DIFFUSERS

DESIG	DUTY	TYPE	MOUNTING LOCATION	MATERIAL	VOLUME CONTROL	FINISH	AIR PATTERN CONTROL	METHOD OF SUPPORT	EQUAL TO MANUFACTURER AND MODEL NO.	REMARKS
A	SUPPLY	PLAQUE	LAY-IN CLG	STEEL	NO	OFF WHITE	YES	T-BAR	TITUS OMNI 24X24 FACE	SEE NOTE 1,2
B	RETURN	PERFORATED	LAY-IN CLG	STEEL	NO	OFF WHITE	NO	T-BAR	TITUS PAR 24X24 FACE	SEE NOTE 2
C	SUPPLY	SLOT	LAY-IN CLG	STEEL	NO	BLACK	YES	T-BAR	TITUS TBD80 (3)1" SLOTS	SEE NOTES 1,2,3,5
E1	SUPPLY	SLOT	LAY-IN CLG	STEEL	NO	BLACK	YES	T-BAR	TITUS TBD80 (3)1" SLOTS	SEE NOTE 1,2,3,5,8
D	EXHAUST	EGGRATE	GYP BD CLG	ALUMINUM	NO	OFF WHITE	NO	SURFACE	TITUS 50F	SEE NOTE 4
E	SUPPLY	LINEAR SLOT	GYP BD CLG	ALUMINUM	NO	OFF WHITE	YES	SURFACE	TITUS ML-39 (1" SLOT)	SEE NOTE 1,6
F	SUPPLY	LINEAR SLOT	GYP BD CLG	ALUMINUM	NO	OFF WHITE	NO	SURFACE	TITUS MLR-39 (1" SLOT)	SEE NOTE 7
G	RETURN	DOOR LOUVER	DOOR	STEEL	NO	OFFWHITE	NO	SURFACE	TITUS T700L	SEE NOTE 4

### NOTES:

1) NECK SIZES AS FOLLOWS:

DESIGNATION "A" CFM RANGE	NECK SIZE	DESIGNATION "C" CFM RANGE	NECK SIZE	LENGTH
000-300	8"RD	000-195	8"RD	2'-0"
305-435	10"RD	200-2680	8"RD	4'-0"
440-600	12"RD	000-220	10"RD	2'-0"
600-745	14"RD	225-320	10"RD	4'-0"

2) NOTIFY ENGINEER OF ANY DISCREPANCIES BETWEEN NEW MODEL NUMBER AND EXISTING NUMBER PRIOR TO PURCHASE.

3) COORDINATE NEW INACTIVE SECTIONS NEXT TO SLOT DIFFUSER WITH ARCHITECT PRIOR TO BIDDING.

4) REFER TO DRAWINGS FOR GRILLE/NECK SIZES.

5) INACTIVE SECTIONS OF SLOT DIFFUSERS SHALL HAVE SHEET METAL LIGHTPROOF SIGHT GUARDS AND SHALL BE USED FOR RETURN AIR.

6) CONTINUOUS GRILLE, PROVIDE REQUIRED MP-39 PLENUMS AS NEEDED.

7) LEAVE OPEN FOR RETURN AIR AND PROVIDE A LIGHT SHIELD. COORDINATE EXACT LENGTH OF SLOT WITH ARCHITECT. COORDINATE BORDER TYPE WITH ARCHITECT.

8) PROVIDE WITH PF-TBD SLOT MOUNTING FRAME FOR INSTALLATION IN SHEETROCK CEILINGS.

9) APPROVED MANUFACTURERS: PRICE, TITUS, NAILOR, & KRUEGER.

## VRF DX - FAN COIL UNIT

DESIG	SERVES	DESIGN COOLING CFM	OUTSIDE AIR CFM	NOMINAL COOLING CAPACITY	NOMINAL HEATING CAPACITY	VOLTAGE	HERTZ	MCA	MOCP	EQUAL TO MANUFACTURER	MODEL NO.
FCU-4-3	OFICES 412, 413	1075	80	30000	34000	208/1	60	2.73	15	MITSUBISHI	TPEFY-P30NMA143A
FCU-4-4	OFFICE 414	1260	40	36000	40000	208/1	60	3.50	15	MITSUBISHI	TPEFY-P36NMA143A
FCU-4-5	OFFICES 416-420	1600	100	36000	40000	208/1	60	3.50	15	MITSUBISHI	TPEFY-P36NMA143A
FCU-4-6	OFFICES 421-423	1600	100	48000	54000	208/1	60	3.50	15	MITSUBISHI	TPEFY-P40NMA143A
FCU-4-7	CONFERENCE 424	1160	280	30000	34000	208/1	60	2.73	15	MITSUBISHI	TPEFY-P30NMA143A
FCU-4-8	ELEV. LOBBY/CORRIDOR	400	400	12000	13500	208/1	60	1.20	15	MITSUBISHI	TPEFY-P012NMA143A
FCU-4-9	CONFERENCE 401	250	160	8000	9000	208/1	60	1.05	15	MITSUBISHI	TPEFY-P008NMA143A
FCU-4-10	CONFERENCE 402	250	160	8000	9000	208/1	60	1.05	15	MITSUBISHI	TPEFY-P008NMA143A
FCU-4-11	OPEN OFFICE 425	1215	160	36000	40000	208/1	60	3.50	15	MITSUBISHI	TPEFY-P36NMA143A
FCU-4-12	ROOMS 404-410	350	60	12000	13500	208/1	60	1.20	15	MITSUBISHI	TPEFY-P012NMA143A
FCU-4-13	OPEN OFFICE 425	1120	240	30000	34000	208/1	60	2.73	15	MITSUBISHI	TPEFY-P30NMA143A

### NOTES:

- NOMINAL COOLING CAPACITIES ARE BASED ON INDOOR COIL EAT OF 80/67 F (DB/MWB), OUTDOOR OF 95 DEGREES F (DB).
- NOMINAL HEATING CAPACITIES ARE BASED ON INDOOR COIL EAT OF 70 DEGREES F (DB), OUTDOOR OF 43 DEGREES F (WB).
- SEE OUTDOOR UNIT SCHEDULE FOR OUTDOOR AMBIENT CONDITIONS, CONNECTED CAPACITY, AND OTHER FACTORS ASSOCIATED WITH CORRECTED CAPACITIES.
- FULL DEMAND CORRECTED CAPACITY INCLUDES DE-RATE ASSOCIATED WITH INDOOR VS OUTDOOR CONNECTED CAPACITY INDICATED ON OUTDOOR UNIT SCHEDULE FOR ASSOCIATED SYSTEM. PARTIAL CORRECTED CAPACITY ASSUMES SUFFICIENT DIVERSITY EXISTS SUCH THAT THE CONNECTED CAPACITY DE-RATE TO BE COMPATIBLE. DUCT SYSTEM DESIGN SHALL ACCOUNT FOR PRESSURE DROP ACROSS THE FILTER.
- CONTROLS SHALL BE CLIMATEC DDC CONTROLS. REFER TO SEQUENCE OF OPERATION FOR VRF CONTROLS AND CONNECTION TO BMS.
- APPROVED MANUFACTURER'S ARE: MITSUBISHI, SAMSUNG, CARRIER, DAIKIN, TRANE AND LG.

## EXHAUST FANS

DESIG	SERVICE	LOCATION	TYPE	CONTROL	CFM	MECHANICAL				ELECTRICAL			
						ESP (IN W.G.)	DRIVE	ACCESSORIES (SEE BELOW)	WEIGHT (LBS)	EQUAL TO BASIS OF DESIGN MFR & MODEL #	HP	RPM	VOLT/P H
EF-4-1	RESTROOM	PLENUM	IN-LINE	SWTCH	300	0.625	DIRECT	A,C,F	41	GREENHECK SQ-95	1/8	1725	120/1
EF-4-2	IT	CEILING	CABINET	T-STAT	800	0.250	DIRECT	A,C,F	54	GREENHECK SP-900	250W	950	120/1

ACCESSORIES:  
 (A) - BACKDRAFT DAMPER (D) - ROOFCURB (G) - INTERLOCK WITH APPLICABLE AHU SUPPLY FAN  
 (B) - BIRDSGREEN (E) - SPEED CONTROL (H) - VFD CONTROLLED  
 (C) - PRE-WIRED NON-FUSED SERVICE DISCONN (F) - SPRING ISOLATION

NOTES:  
 1) REFER TO SPECIFICATIONS FOR ADDITIONAL INFORMATION.  
 2) CONTROL DESCRIPTION (WHERE PROVIDED, REFER TO SEQUENCE OF OPERATION FOR ADDITIONAL INFORMATION)  
 SWTCH - MOTOR RATED SWITCH BY DIV. 26  
 T-STAT - LINE VOLTAGE THERMOSTAT PROVIDED BY DIV. 23  
 3) APPROVED MANUFACTURERS - GREENHECK, COOK  
 4) ALL SUBSTITUTIONS SHALL BE APPROVED, IN WRITING, PRIOR TO BID.


REVISIONS SUMMARY:  
 • ADDED DALLAS GREEN NOTES

## GENERAL NOTES:

- ALL WORK SHALL COMPLY WITH APPLICABLE NATIONAL, STATE AND LOCAL CODES, RULES, REGULATIONS AND REQUIREMENTS.
- ALL WORK SHALL COMPLY WITH THE BUILDING TENANT CONSTRUCTION GUIDE. COORDINATE WITH BUILDING MANAGEMENT/OWNER FOR ACCESS TO ANY TENANT LEASE SPACES THAT MIGHT BE REQUIRED FOR THE INSTALLATION. UNLESS DIRECTED BY LANDLORD ALL EQUIPMENT AND WORKMANSHIP SHALL BE GUARANTEED FOR 1 YEAR.
- EXISTING CONDITIONS ARE BASED ON INFORMATION PROVIDED BY SITE SURVEY AND PREVIOUS RECORD DRAWINGS. HOWEVER, IT IS NOT INTENDED TO BE A TRUE REPRESENTATION OF ACTUAL CONDITIONS. CONTRACTOR SHALL VISIT JOB SITE PRIOR TO BIDDING TO ASCERTAIN EXISTING CONDITIONS AND SHALL NOTIFY ARCHITECT OF ANY DISCREPANCIES PRIOR TO BID.
- CONTRACTOR SHALL ENGAGE AN INDEPENDENT AIR BALANCING COMPANY TO OBTAIN AIR QUANTITIES SHOWN ON DRAWING. AT COMPLETION OF AIR BALANCE, BALANCING DAMPER SHALL BE TIGHTENED AND PROPERLY SEALED WITH FOIL TAPE.
- ALL MEDIUM AND LOW PRESSURE DUCTWORK SHALL BE GALVANIZED SHEET METAL, FABRICATED, INSTALL AND SEAL MEDIUM PRESSURE DUCTWORK FOR 3"W.G. AND LOW PRESSURE DUCTWORK FOR 1"W.G. IN ACCORDANCE WITH SMACNA STANDARD. DUCTWORK SHALL BE INSULATED WITH FIBERGLASS BLANKET WITH FOIL FACED VAPOR BARRIER TO MEET IECC REQUIREMENT (MIN R5 VALUE).
- ALL SUPPLY AND RETURN DUCT SIZES ARE FREE AREAS.
- INDIVIDUAL DUCT RUN-OUTS TO EACH DIFFUSER SHALL BE SIZED IN ACCORDANCE TO THE DIFFUSER NECK SIZE FOUND IN THE GRILLES-REGISTERS-DIFFUSERS SCHEDULE UNLESS NOTED OTHERWISE.
- OFFSET DUCTS INTO JOIST SPACE FOR CLEARANCE WHERE SPACE ABOVE CEILING IS NOT SUFFICIENT FOR DUCTS TO CROSS OTHER DUCTS OR WORK OF OTHER TRADES.
- INSULATED FLEX DUCT IN THE LOW PRESSURE SYSTEM SHALL BE LIMITED TO AN OVERALL LENGTH OF SIX (6) FEET WITH A MAXIMUM OF A 90 DEGREE CHANGE IN DIRECTION. SUPPORTS SHALL BE SADDLE BANDED TO STRUCTURE. SUPPORTING FROM FIRE PROTECTION PIPING, ELECTRICAL CONDUIT OR CEILING SUPPORT WIRES IS NOT ACCEPTABLE.
- ENSURE NEC CLEARANCES ARE MAINTAINED INCLUDING 36" IN FRONT OF 0-208V POWER AND 42" IN FRONT OF 277/480V POWER.
- ALL ENCLOSED ROOMS (INTERIOR AND PERIMETER) SHALL HAVE RETURN AIR PATH. ROOMS WITH ALL WALLS TO DECK SHALL HAVE LINED SHEET METAL RETURN AIR BOOTS PLACED IN WALL ABOVE CEILING SIZED FOR 500 FPM MAXIMUM. FIRE RATED WALLS SHALL HAVE FIRE DAMPERS WITHIN THE DUCT PER LOCAL CODE REQUIREMENTS. FIRE DAMPERS AND FIRE-SMOKE DAMPERS SHALL BE FREE AREA/OUT OF AIRSTREAM TYPE. ALL MOTORIZED DAMPERS SHALL BE FREE AREA/OUT OF AIRSTREAM TYPE.
- PIPES AND DUCTS TO BE COORDINATED ON JOB WITH BUILDING STRUCTURE AND WORK OF OTHER CONTRACTORS. ROUTE AS HIGH AS PHYSICALLY POSSIBLE.
- COORDINATE CEILING DIFFUSERS AND GRILLES WITH LIGHTING FIXTURES. REFER TO ARCHITECTURAL REFLECTED CEILING PLAN.
- THERMOSTATS TO BE MOUNTED 48" ABOVE FINISHED FLOOR LEVEL UNLESS NOTED OTHERWISE ON THE PLANS. CONTRACTOR SHALL COORDINATE LOCATION OF THERMOSTATS WITH ARCHITECT IN FIELD.
- REPAIR AND PATCH CONSTRUCTION DAMAGED DUE TO THE DEMOLITION OF THIS PROJECT, USING SAME METHODS AND MATERIALS TO MATCH EXISTING.
- EVAPORATORS SHALL HAVE A PRIMARY INSULATED CONDENSATE DRAIN LINE SLOPED 1/8"/FT, EXTENDED TO NEAREST FLOOR DRAIN IN MECHANICAL ROOM OR MOP SINK. GALVANIZED SHEET METAL SECONDARY DRAIN PANS SHALL HAVE LEAK DETECTION TAPE IN PAN AND ROUTE THE PAN'S INSULATED CONDENSATE DRAIN LINE SLOPED 1/8"/FT NEXT TO BUT INDEPENDENT OF PRIMARY DRAIN LINES.
- PROVIDE TEMPORARY HIGH EFFICIENCY FILTER MEDIA ON MAIN RETURN AIR AND EXHAUST FROM FLOOR AT BEGINNING OF PROJECT AND REPLACED AT TWO (2) WEEK INTERVALS UNTIL PROJECT COMPLETION AT WHICH TIME THE FILTER MEDIA SHALL BE REMOVED.
- FLEXIBLE DUCTS SHALL BE SIMILAR AND EQUAL TO THERMOFLEX: TYPE M-KE. FLEXIBLE DUCTS SHALL COMPLY WITH APPLICABLE REQUIREMENTS OF UL-181, NFPA 90-A AND OTHER GOVERNING AUTHORITIES.
- FLEXIBLE DUCT BETWEEN DUCT AND AC UNITS AND EXHAUST FANS SHALL BE EQUAL TO VENTFABRICS "VENTGLAS".
- AIR CONDITIONING COOLING CONDENSATE PIPING TO BE ONE-HALF INCH THICK ARMAFLEX. FITTINGS SHALL BE PRE-MOLDED OF THE SAME MATERIAL. INSTALLATION SHALL BE IN ACCORDANCE WITH MANUFACTURER'S INSTRUCTIONS.
- DUCTLINER SHALL BE 1-INCH ACOUSTICAL DUCT LINING IN ACCORDANCE WITH SMACNA STANDARDS. DUCT LINING SHALL BE OWENS-CORNING FIBERGLAS "AEROFLEX" NO. 200 OR EQUAL.
- ALL EXISTING DUCTWORK SHALL BE FIELD VERIFIED TO BE INSULATED AND IN GOOD CONDITION. ANY TORN, DAMAGED OR MISSING INSULATION WILL BE REPLACED. EXISTING CONTROLS SHALL BE CONFIRMED TO BE IN WORKING CONDITION.


## HVAC SYMBOLS

SYMBOL	DESCRIPTION
	REDISTRIBUTE AIR TO EXISTING DIFFUSER AS INDICATED ON PLAN
	INDICATES SIZE, CFM, AND DIFFUSER TYPE
	NEW CEILING SUPPLY DIFFUSER
	NEW RETURN AIR/EXHAUST GRILLE
	EXISTING RETURN AIR/EXHAUST GRILLE
	NEW SLOT DIFFUSER
	POINT OF CONNECTION BETWEEN NEW AND EXISTING WORK
	EXISTING TO REMAIN
	REMOVE EXISTING AS INDICATED
	CAP EXISTING DUCT
	DUCT TRANSITION
	FIRE (SMOKE) DAMPER (24V ACTUATOR)
	NEW OR RELOCATED THERMOSTAT
	EXISTING THERMOSTAT
	FLEXIBLE DUCT CONNECTION
	INDICATES A WALL TO DECK (FOR COORDINATION PURPOSE ONLY-REFER TO ARCHITECTS PLANS FOR REQUIREMENTS)

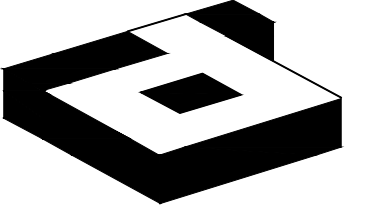

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PROJECT NO.: 580-004  
DRAWN BY: PMI  
CHECKED BY: PMI  
TENANT R.S.F.: 9.452

BILLINGSLEY  
COMPANY

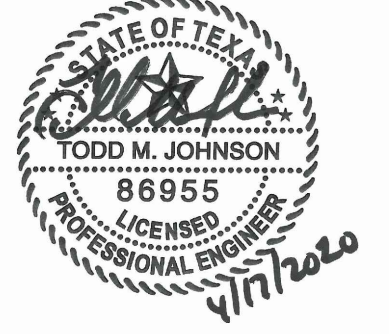3401 OLYMPUS

ARTISAN DESIGN GROUP

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NO.	ISSUED FOR:	DATE:
1	REVISION 1	04/17/2020

LANDLORD/CLIENT REVIEW ISSUE DATE: 03/30/20  
BID ISSUE DATE: 03/30/20  
CONSTRUCTION ISSUE DATE: 03/30/20

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DRAWING TITLE:  
MECHANICAL  
NOTES & SYMBOLS

DRAWING NUMBER:

M0.01

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**Summary**

The existing HVAC systems for the building at 3401 Olympus consist of four discrete components:

1. Comfort cooling systems for core/shell and future tenant spaces
2. Exhaust for core/shell restrooms and janitor closets
3. Dedicated outside air systems for minimum occupant ventilation requirements, coupled with building static pressure relief fans
4. Crawlspace ventilation exhaust/intake

Additionally, the building is equipped with a direct digital controls (DDC) building management system (BMS).

The four HVAC system components, along with any other miscellaneous equipment/controls, will be described in detail below, along with the intended operating sequences and building automation system integration requirements, as applicable.

**Systems**

**Comfort Cooling Systems – Variable Refrigerant Flow (VRF) with Heat Recovery**

All portions of the building intended for occupancy are to be heated and cooled by virtue of individual heat pump fan-coil units, both ducted and non-ducted type as required, that are to be integrated with a heat-recovery VRF system capable of allowing for simultaneous heating and cooling among the zones. Each fan-coil unit (designated by FCU-# on the drawings) constitutes a zone, and will be equipped with its own zone temperature sensor, provided by the VRF system manufacturer, that allows for adjustable heating and cooling setpoints. Each fan-coil unit (including future fan-coil units for unfinished tenant areas) is to be connected to existing branch and sub-branch controllers that control the flow of refrigerant as required by the individual zone needs for heating and/or cooling.

Each existing branch controller (and sub-branch controller as applicable) is connected directly to a VRF condensing unit array at the roof, sized for a portion of the core/shell and/or tenant area, and furnished with a number of additional connection points for areas not intended to be occupied immediately after completion of this tenant finishout. The branch controller for each system designated for future tenant use are equipped with multiple ports for future tenant hookup of refrigerant piping for fan-coil units. Fan-coil unit sizes for future tenant spaces are to be determined by each tenant’s mechanical consultant during the tenant space design phases. Contractor shall coordinate the quantity of available ports, location of branch controllers (and sub-branch controllers) and available capacity of each system with building management prior to bidding.

In relation to the BMS, the VRF systems are to be stand-alone, and are to be provided with their own manufacturer’s control system to provide full functionality. The VRF manufacturer’s control system is to be integrated to the BMS via an integral Bacnet interface.



**DIVISION 23 - HEATING VENTILATING AND AIR CONDITIONING**

**SECTION 230500 - COMMON WORK RESULTS**

**PART 1 - GENERAL**

- 1.1 GENERAL NOTES AND SCOPE OF WORK
  - A.REFER TO SECTION 230500 FOR INFORMATION RELATED TO HVAC GENERAL CONDITIONS, MISCELLANEOUS EQUIPMENT AND MATERIALS, AND CONSTRUCTION REQUIREMENTS.
- 1.2 RELATED SECTIONS
  - A.SECTIONS 230523, 230529, 230553 AND 230700 ARE APPLICABLE BUT THEY DO NOT APPEAR IN THESE DIVISION 23 SPECIFICATIONS. REFER TO GENERAL NOTES.

**PART 2 - PRODUCTS (NOT USED)**

**PART 3 - EXECUTION (NOT USED)**

END OF SECTION

**SECTION 230548 - VIBRATION CONTROLS**

**PART 1 - GENERAL**

- 1.1 SCOPE OF WORK
  - A.REFER TO SECTION 230500.

**PART 2 - PRODUCTS**

- 2.1 EQUIPMENT PADS
  - A.PADS SHALL BE 3/4 INCH WATER RESISTANT NEOPRENE WITH WAFFLE PATTERN, MASON TYPE WSW, OR EQUAL.
- 2.2 ELASTOMERIC HANGERS
  - A.HANGER SHALL CONSIST OF RODS WITH STEEL BOX HOUSING NEOPRENE ISOLATION ELEMENT AND SPRING, MASON SERIES 30N, OR EQUAL.
- 2.3 RESTRAINED SPRING ISOLATORS
  - A.ISOLATORS SHALL UTILIZE A STEEL BASE WITH WAFFLED NEOPRENE PAD, WELDED STEEL ENCLOSURE WITH SPRING AND RESTRAINING BOLTS, MASON TYPE SLR, OR EQUAL.
- 2.4 ROOF CURB ISOLATORS
  - A.AS PART OF THE ROOF CURB, PROVIDE SPRING ISOLATORS WITH WATER-TIGHT DESIGN, RETAINED SPRINGS AND NEOPRENE PADS, MASON TYPE RSC, OR EQUAL.
- 2.5 INERTIA BASES
  - A.PROVIDE STEEL POURING FORM FOR REINFORCED CONCRETE BLOCKS WITH FLOOR MOUNTED SPRINGS, MASON KSL, OR EQUAL.

**PART 3 - EXECUTION**

- 3.1 SCHEDULE
  - A.EQUIPMENT PADS - SMALL FLOOR MOUNTED EQUIPMENT OR PACKAGED EQUIPMENT WITH INTERNAL ISOLATION.
  - B.ELASTOMERIC HANGERS - SUSPENDED AIR HANDLING UNITS, EXHAUST FANS, TERMINAL UNITS, HEAT PUMPS, PUMPS, ETC.
  - C.RESTRAINED SPRING ISOLATORS - FLOOR MOUNTED FANS GREATER THAN ¼ HP.
  - D.ROOF CURB ISOLATORS - FACTORY FABRICATED ROOFTOP UNITS.
  - E.INERTIA BASES - FLOOR MOUNTED PUMPS GREATER THAN ¼ HP.
- 3.2 INSTALLATION
  - A.INSTALL VIBRATION CONTROLS PER THE MANUFACTURER'S INSTRUCTIONS.

END OF SECTION

**SECTION 230553 - IDENTIFICATION**

**PART 1 - GENERAL**

- 1.1 SCOPE OF WORK
  - A.REFER TO SECTION 230500.
  - B.LABEL ALL NEW EQUIPMENT AND PIPING SYSTEMS.

**PART 2 - PRODUCTS**

- 2.1 PIPE LABELS
  - A.PRETENSION PIPE LABELS OF SEMI-RIGID PLASTIC FORMED TO COVER THE FULL CIRCUMFERENCE OF PIPE.
  - B.IDENTIFY THE SERVICE AND DIRECTION OF FLOW. LABELS SHALL CONTAIN AT LEAST ¼ INCH HIGH LETTERING AND BE PLACED SO THEY ARE EASY TO READ.
- 2.2 EQUIPMENT LABELS
  - A.MULTILAYER, MULTICOLOR PLASTIC LABELS WITH MECHANICAL ENGRAVING AND HOLES FOR ATTACHMENT TO EQUIPMENT.

**PART 3 - EXECUTION**

- 3.1 PIPE LABELS
  - A.INSTALL PIPE LABELS WHERE PIPING IS EXPOSED OR ABOVE AN ACCESSIBLE CEILING AT MAXIMUM 20 FT. CENTERS.
- 3.2 VALVE TAGS
  - A.ATTACH TAGS TO VALVES USING CHAIN. PROVIDE A VALVE SCHEDULE FOR MOUNTING IN THE MECHANICAL ROOM.
- 3.3 EQUIPMENT LABELS
  - A.PERMANENTLY ATTACH LABELS TO EQUIPMENT. LOCATE WHERE LABEL CAN BE EASILY SEEN AND READ.

END OF SECTION

**SECTION 230593 - TESTING ADJUSTING AND BALANCING**

**PART 1 - GENERAL**

- 1.1 SCOPE OF WORK
  - A.THE WORK INCLUDED IN THIS SECTION CONSISTS OF FURNISHING ALL LABOR, MATERIALS, INSTRUMENTS, TOOLS, AND SERVICES REQUIRED IN CONNECTION WITH THE TESTING, ADJUSTING AND BALANCING (TAB) OF THE HEATING, VENTILATING AND AIR CONDITIONING (HVAC) SYSTEMS AS DESCRIBED IN THE MECHANICAL SPECIFICATIONS AND/OR SHOWN ON THE MECHANICAL PLANS, OR REASONABLY IMPLIED THERE FROM.
  - B.THE TAB FIRM SHALL HAVE A LICENSED PROFESSIONAL ENGINEER SUPERVISING ALL WORK AND THE FIRM SHALL HOLD A CURRENT AA/CB OR NEHB CERTIFICATION.
- 1.2 START-UP, TEST AND ADJUST
  - A.PROVIDE ALL TESTS OF EQUIPMENT AND SYSTEMS REQUIRED TO PROVE COMPLIANCE WITH THE DRAWINGS AND SPECIFICATIONS. OWNER SHALL BE MADE COMPLETELY FAMILIAR WITH THE COMPLETE WORKING OF ALL THE MECHANICAL SYSTEMS.
  - B.THE TESTS SHALL DEMONSTRATE THE SPECIFIED CAPACITIES AND OPERATION OF ALL EQUIPMENT AND MATERIALS COMPRISING THE SYSTEMS. ALL DATA REQUIRED BY THESE SPECIFICATIONS SHALL BE PREPARED ON TYPED FORMS AND SUBMITTED TO THE ENGINEER FOR APPROVAL. COMPLETE APPROVAL WILL BE NECESSARY BEFORE FINAL PAYMENT CAN BE MADE. THE CONTRACTOR SHALL THEN MAKE AVAILABLE SUCH INSTRUMENTS NECESSARY FOR SPOT CHECKS ON THE SYSTEM.

**PART 2 - PRODUCTS (NOT USED)**

**PART 3 - EXECUTION**

- 3.1 HVAC SYSTEM
  - A.THE HVAC CONTRACTOR SHALL WORK IN CONJUNCTION WITH THE TAB CONTRACTOR TO START-UP AND OPERATE ALL EQUIPMENT NECESSARY TO PROVIDE A COMPLETE AIR AND WATER TEST AND BALANCE REPORT.
  - B.TAB CONTRACTOR SHALL MEASURE CFM AT ALL DIFFUSERS, REGISTERS AND GRILLES, AND HVAC UNITS, AS WELL AS WATER FLOWS AT COILS AND PUMPS, TO ASSURE THAT THEY MATCH THE QUANTITIES SHOWN ON THE PLANS (PLUS OR MINUS 5 PERCENT). CONFIRM ALL SEQUENCES OF OPERATION ARE PERFORMING CORRECTLY.
  - C.TAB CONTRACTOR SHALL CALIBRATE ALL EQUIPMENT AND SENSORS TO WORK PROPERLY AND GIVE CORRECT INFORMATION TO THE BMS SYSTEM.

END OF SECTION

**SECTION 230900 - CONTROLS**

**PART 1 - GENERAL**

- 1.1 SCOPE OF WORK
  - A.REFER TO SECTION 230500.

**PART 2 - PRODUCTS**

- 2.1 CONTROLS SYSTEM
  - A.PROVIDE NEW, MODIFY OR EXTEND AUTOMATIC TEMPERATURE CONTROLS TO ALL NEW EQUIPMENT SHOWN ON THE DRAWINGS.
  - B.REFER TO THE DRAWINGS FOR ANY SPECIAL SEQUENCES OF CONTROL AND LOCATION OF EQUIPMENT.
  - C.REMODEL PROJECTS SHALL UTILIZE EQUIPMENT BY THE SAME MANUFACTURER AS CURRENTLY EXISTS.

**PART - EXECUTION**

- 3.1 DESIGN AND LAYOUT
  - A.THE CONTROL SYSTEM DESIGN AND LAYOUT SHALL BE PERFORMED BY A FACTORY AUTHORIZED AGENT OF THE MANUFACTURER USED.
- 3.2 SYSTEM OPERATION
  - A.AT THE CONCLUSION OF WORK, ALL EQUIPMENT AND SYSTEMS SHALL BE PROVEN TO THE ENGINEER TO OPERATE IN ACCORDANCE WITH THE NEW OR EXISTING MAIN CONTROL PANEL AND NEW/EXISTING SEQUENCES OF OPERATION ON THE DRAWINGS.
  - B.PROVIDE ALL WIRING REQUIRED TO CONNECT INPUT/OUTPUT DEVICES TO CONTROL PANELS.
  - C.TEST AND ADJUST ALL DEVICES AND DOCUMENT CALIBRATION.
  - D.PROVIDE NECESSARY INSTRUCTION TO THE OWNER'S PERSONNEL.

END OF SECTION

**SECTION 233113 - DUCTWORK**

**PART 1 - GENERAL**

- 1.1 SCOPE OF WORK
  - A.REFER TO SECTION 230500.

**PART 2 - PRODUCTS**

- 2.1 GENERAL
  - A.CONCEALED DUCTWORK SHALL BE CONSTRUCTED OF NEW, PRIME GRADE, CONTINUOUS HOT-DIP MILL GALVANIZED, LOCK-FORMING, QUALITY STEEL. REFER TO SMACNA HVAC DUCT CONSTRUCTION STANDARDS.
  - B.WHERE DUCTS EXPOSED TO VIEW PASS THROUGH WALLS, FLOORS OR CEILINGS, PROVIDE SHEET METAL COLLARS TO COVER VOIDS AROUND THE DUCTS.
  - C.SQUARE AND ROUND ELBOWS SHALL BE CONSTRUCTED IN ACCORDANCE WITH THE SMACNA STANDARDS. ELBOWS NOT CONSTRUCTED WITH A CENTERLINE RADIUS OF AT LEAST 50 PERCENT OF THE DUCT WIDTH OR DIAMETER SHALL BE PROVIDED WITH TURNING VANES IN ACCORDANCE WITH SMACNA STANDARDS.
  - D."FIBERBOD" DUCTWORK WILL NOT BE ACCEPTED ON THIS PROJECT.
- 2.2 MEDIUM PRESSURE DUCT CONSTRUCTION
  - A.UNLESS NOTED OTHERWISE, MEDIUM PRESSURE DUCTS SHALL BE CONSTRUCTED TO A PRESSURIZATION CLASSIFICATION OF THREE (3) INCHES WG POSITIVE.
  - B.ALL ROUND MEDIUM PRESSURE DUCTS SHALL BE SPIRAL TYPE.
- 2.3 LOW PRESSURE DUCT CONSTRUCTION
  - A.LOW PRESSURE DUCTS CONNECTING SMALL AIR HANDLING EQUIPMENT, SHALL BE CONSTRUCTED TO A PRESSURIZATION CLASSIFICATION OF TWO (2) INCHES WG, POSITIVE OR NEGATIVE AS APPROPRIATE. THESE LOW PRESSURE ROUND DUCTS SHALL BE SPIRAL TYPE.
  - B.DUCTWORK DOWN-STREAM OF AIR TERMINAL UNITS SHALL BE CONSTRUCTED TO A PRESSURE CLASSIFICATION OF ONE (1) INCHES WG POSITIVE. THESE LOW PRESSURE ROUND DUCTS MAY BE SPIRAL OR SNAP-LOCK TYPE.
  - C.SHOP FABRICATED DUCTS SHALL BE CONSTRUCTED, BRACED AND REINFORCED IN ACCORDANCE WITH SMACNA STANDARDS.
- 2.4 DUCT SEALING
  - A.SEAL ALL DUCTWORK ON THE PROJECT TO SMACNA CLASSIFICATION A.
- 2.5 FLEXIBLE DUCTS
  - A.FLEXIBLE DUCTS SHALL BE SIMILAR AND EQUAL TO THERMOFLEX TYPE M-KE AND SHALL COMPLY WITH APPLICABLE REQUIREMENTS OF UL-181, NFPA 90-A AND OTHER GOVERNING AUTHORITIES.
  - B.FLEXIBLE DUCTS SHALL BE FACTORY INSULATED WITH A NOMINAL 1 INCH THICKNESS OF FIBERGLASS INSULATION, PRODUCING A THERMAL CONDUCTANCE ("C") OF 0.23. DUCTS SHALL HAVE A POSITIVE INTERIOR AIR SEAL PERMANENTLY BONDED TO A COATED HIGH CARBON SPRING STEEL HELIX, ALL SHEATHED IN AN OUTER VAPOR BARRIER OF FIBERGLASS REINFORCED FILM LAMINATE.
  - C.FLEXIBLE DUCTS SHALL BE RATED FOR OPERATING PRESSURE OF PLUS 6 INCHES WG THROUGH 10 INCH DIAMETER, PLUS 4 INCHES WG THROUGH 16 INCH DIAMETER AND - 2 INCHES WG FOR ALL SIZES.
  - A.FLEXIBLE DUCTS TO DIFFUSERS AND GRILLES SHALL BE LIMITED TO 6 FOOT LENGTHS AND A MAXIMUM OF ONE (1) 90 DEGREE CHANGE IN DIRECTION. MEDIUM PRESSURE DUCTS SERVING TERMINAL UNITS SHALL BE LIMITED TO 2 FOOT LENGTHS WITH NO ELBOWS.
- 2.6 FLEXIBLE DUCT FABRIC
  - A.PROVIDE VENTFABRICS "VENTGLAS", OR EQUAL, 30 OZ PER SQ YD, BETWEEN SHEET METAL DUCTS AND AIR HANDLING EQUIPMENT, INCLUDING ALL FANS, AND POWER TYPE VENTILATORS.
- 2.7 DAMPERS
  - A.DAMPER AND SPLITTER HARDWARE FOR LOW PRESSURE DUCTS SHALL BE:
    - END BEARINGS - VENTLOK #607
    - REGULATOR FINISHED AREAS - VENTLOK #666, PLAIN COVER
    - REGULATOR UNFINISHED AREAS - VENTLOK #640, 3/8 INCH
  - B.VOLUME DAMPERS SHALL BE LOCATED AT BRANCH TAKE-OFFS AT MAIN TRUNK DUCT. NO DAMPERS (SPLITTER DAMPERS) SHALL BE LOCATED IN THE CENTER OF DUCTS.

**PART 3 - EXECUTION**

- 3.1 FABRICATION
  - A.DUCTWORK SHOWN ON THE DRAWINGS, SPECIFIED, OR REQUIRED FOR HEATING, VENTILATING AND AIR CONDITIONING SYSTEMS SHALL BE CONSTRUCTED AND ERECTED IN A FIRST CLASS MANNER.
  - B.DUCTS SHALL BE REINFORCED IN ACCORDANCE WITH THE APPROPRIATE SMACNA STANDARDS TO PREVENT BUCKLING, BREATHING, VIBRATION AND UNNECESSARY NOISE.
  - C.PROVIDE MANUALLY OPERATED VOLUME CONTROL DAMPERS IN DUCT BRANCHES, FOR PROPER BALANCING OF AIR DISTRIBUTION. DAMPERS SHALL BE CONSTRUCTED IN ACCORDANCE WITH THE APPROPRIATE SMACNA STANDARDS.
  - D.PROVIDE HINGED ACCESS DOORS IN DUCTWORK FOR ACCESS TO ALL SMOKE DETECTORS, SENSORS, AND OTHER CONTROL DEVICES, MANUAL DAMPERS, AND FOR CLEANING OPERATIONS. FACTORY FABRICATED DOORS SIMILAR AND EQUAL TO MILCOR AND MEETING THESE SPECIFICATIONS SHALL BE ACCEPTABLE.
  - E.WHERE DUCTS CONNECT TO FANS, INCLUDING ROOF EXHAUSTERS PROVIDE FLEXIBLE DUCT FABRIC CONNECTIONS. PROVIDE A MINIMUM OF ½ INCH SLACK IN THE CONNECTIONS, AND A MINIMUM OF 2-1/2 INCH DISTANCE BETWEEN THE EDGES OF THE DUCTS, PLUS AN ADDITIONAL MINIMUM IF 1 INCH OF SLACK FOR EACH INCH OF STATIC PRESSURE ON THE FAN SYSTEM.
  - F.PROVIDE SCREENS ON DUCTS, FANS AND OPENINGS WHICH LEAD TO, OR ARE OUTDOORS. SCREENS SHALL BE 16 GAUGE, ¼ INCH MESH, IN REMOVABLE GALVANIZED STEEL FRAMES.
  - G.FURNISH TEST OPENINGS WITH COVERS IN EACH DUCT FOR TAKING READINGS OF AIR VELOCITIES AND PRESSURES IN DUCTS. REFER TO THE APPROPRIATE SMACNA STANDARD FOR COVER CONSTRUCTION.
- 3.2 DUCT SUPPORTS
  - A.HORIZONTAL AND VERTICAL SHEET METAL DUCTWORK SHALL BE SUPPORTED IN ACCORDANCE WITH THE APPROPRIATE SMACNA STANDARDS.
  - B.HANGER DESIGN AND METHODS OF HANGING AND SUPPORTING SHALL BE COMPATIBLE WITH THE STRUCTURE.

END OF SECTION

**SECTION 233713 - DIFFUSERS, REGISTERS AND GRILLES**

**PART 1 - GENERAL**

- 1.1 GENERAL NOTES
  - A.REFER TO SECTION 230500


**PART 2 - PRODUCTS**

- 2.1 AIR INLETS AND OUTLETS
  - A.GRILLES, REGISTERS, CEILING OUTLETS, AND CEILING INLETS SHALL BE AS INDICATED ON THE DRAWING, AND SHALL BE PROVIDED WITH HEAVY DUTY SPONGE, OR SOFT FELT GASKETS. THE THROW SHALL BE SUCH THAT THE VELOCITY AT THE END OF THE THROW IN THE FIVE (5) FOOT OCCUPANCY ZONE WILL NOT BE MORE THAN 50 FPM NOT LESS THAN 25 FPM. NOISE LEVELS (NC CURVE) SHALL NOT EXCEED 40.
  - B.IF PRODUCTS OF A MANUFACTURER OTHER THAN THE ONES INDICATED ON THE DRAWINGS ARE USED, THE SIZES SHOWN ON THE DRAWING SHALL BE CHECKED FOR PERFORMANCE, NOISE LEVEL, FACE VELOCITY, THROW AND PRESSURE DROP BEFORE THE SUBMITTAL IS MADE. SELECTIONS SHALL MEET THE MANUFACTURER'S OWN PUBLISHED DATA FOR THE ABOVE PERFORMANCE CRITERIA. SHOULD DEVICES OTHER THAN THOSE SCHEDULED BY NAME BE FURNISHED, THE MANUFACTURER SHALL DEMONSTRATE COMPLIANCE WITH NOISE CRITERIA, ON REQUEST, TO THE ARCHITECT'S SATISFACTION.
  - C.WHERE CALLED FOR IN SCHEDULES, THE GRILLES, REGISTERS, CEILING OUTLETS, AND CEILING INLETS SHALL BE PROVIDED WITH DEFLECTING DEVICES AND MANUAL DAMPERS. THESE SHALL BE STANDARD PRODUCTS OF THE MANUFACTURER, SUBJECT TO REVIEW BY THE ARCHITECT, AND SHALL BE SIMILAR AND EQUAL TO THOSE SCHEDULED.

**PART 3 - EXECUTION**

- 3.1 INSTALLATION
  - A.LOCATIONS OF OUTLETS SHOWN ON THE DRAWINGS ARE APPROXIMATE. COORDINATE THE EXACT LOCATION WITH REFLECTED CEILING PLAN AND OTHER TRADES.
  - B.VERIFY THE TYPE OF CEILING SYSTEM AND MATERIAL INTO EACH OF THE AIR INLETS AND OUTLETS IS TO BE INSTALLED, AND PROVIDE EQUIPMENT, WHICH PROPERLY "HITS" WHETHER SPECIFICALLY, SO INDICATED OR NOT ON THE DRAWINGS.

END OF SECTION

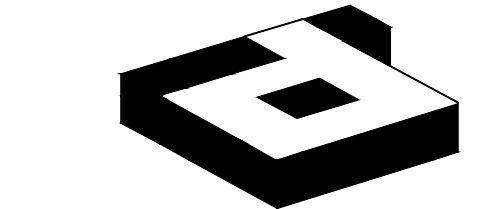

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NO.	ISSUED FOR:	DATE:
1	REVISION 1	04/17/2020

LANDLORD/CLIENT REVIEW ISSUE DATE: 03/30/20  
BID ISSUE DATE: 03/30/20  
CONSTRUCTION ISSUE DATE: 03/30/20

REVISION SUMMARY:  
• REMOVED VALVE TAGS  
• ADDED BLDG SYSTEM SUMMARY


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Mechanical - Electrical Engineers  
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DRAWING TITLE:  
**MECHANICAL SPECIFICATIONS**

DRAWING NUMBER:

**M1.01**



**idGROUP**

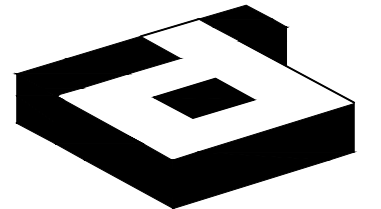2641 IRVING BLVD.  
DALLAS, TEXAS 75207  
TEL: 214-638-6800 FAX: 214-689-0301




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DRAWN BY: PMI  
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TENANT R.S.F.: 9.452

**BILLINGSLEY**  
COMPANY

**3401 OLYMPUS**  
**ARTISAN DESIGN GROUP**

3401 OLYMPUS BLVD.  
SUITE #450  
DALLAS, TX 75019

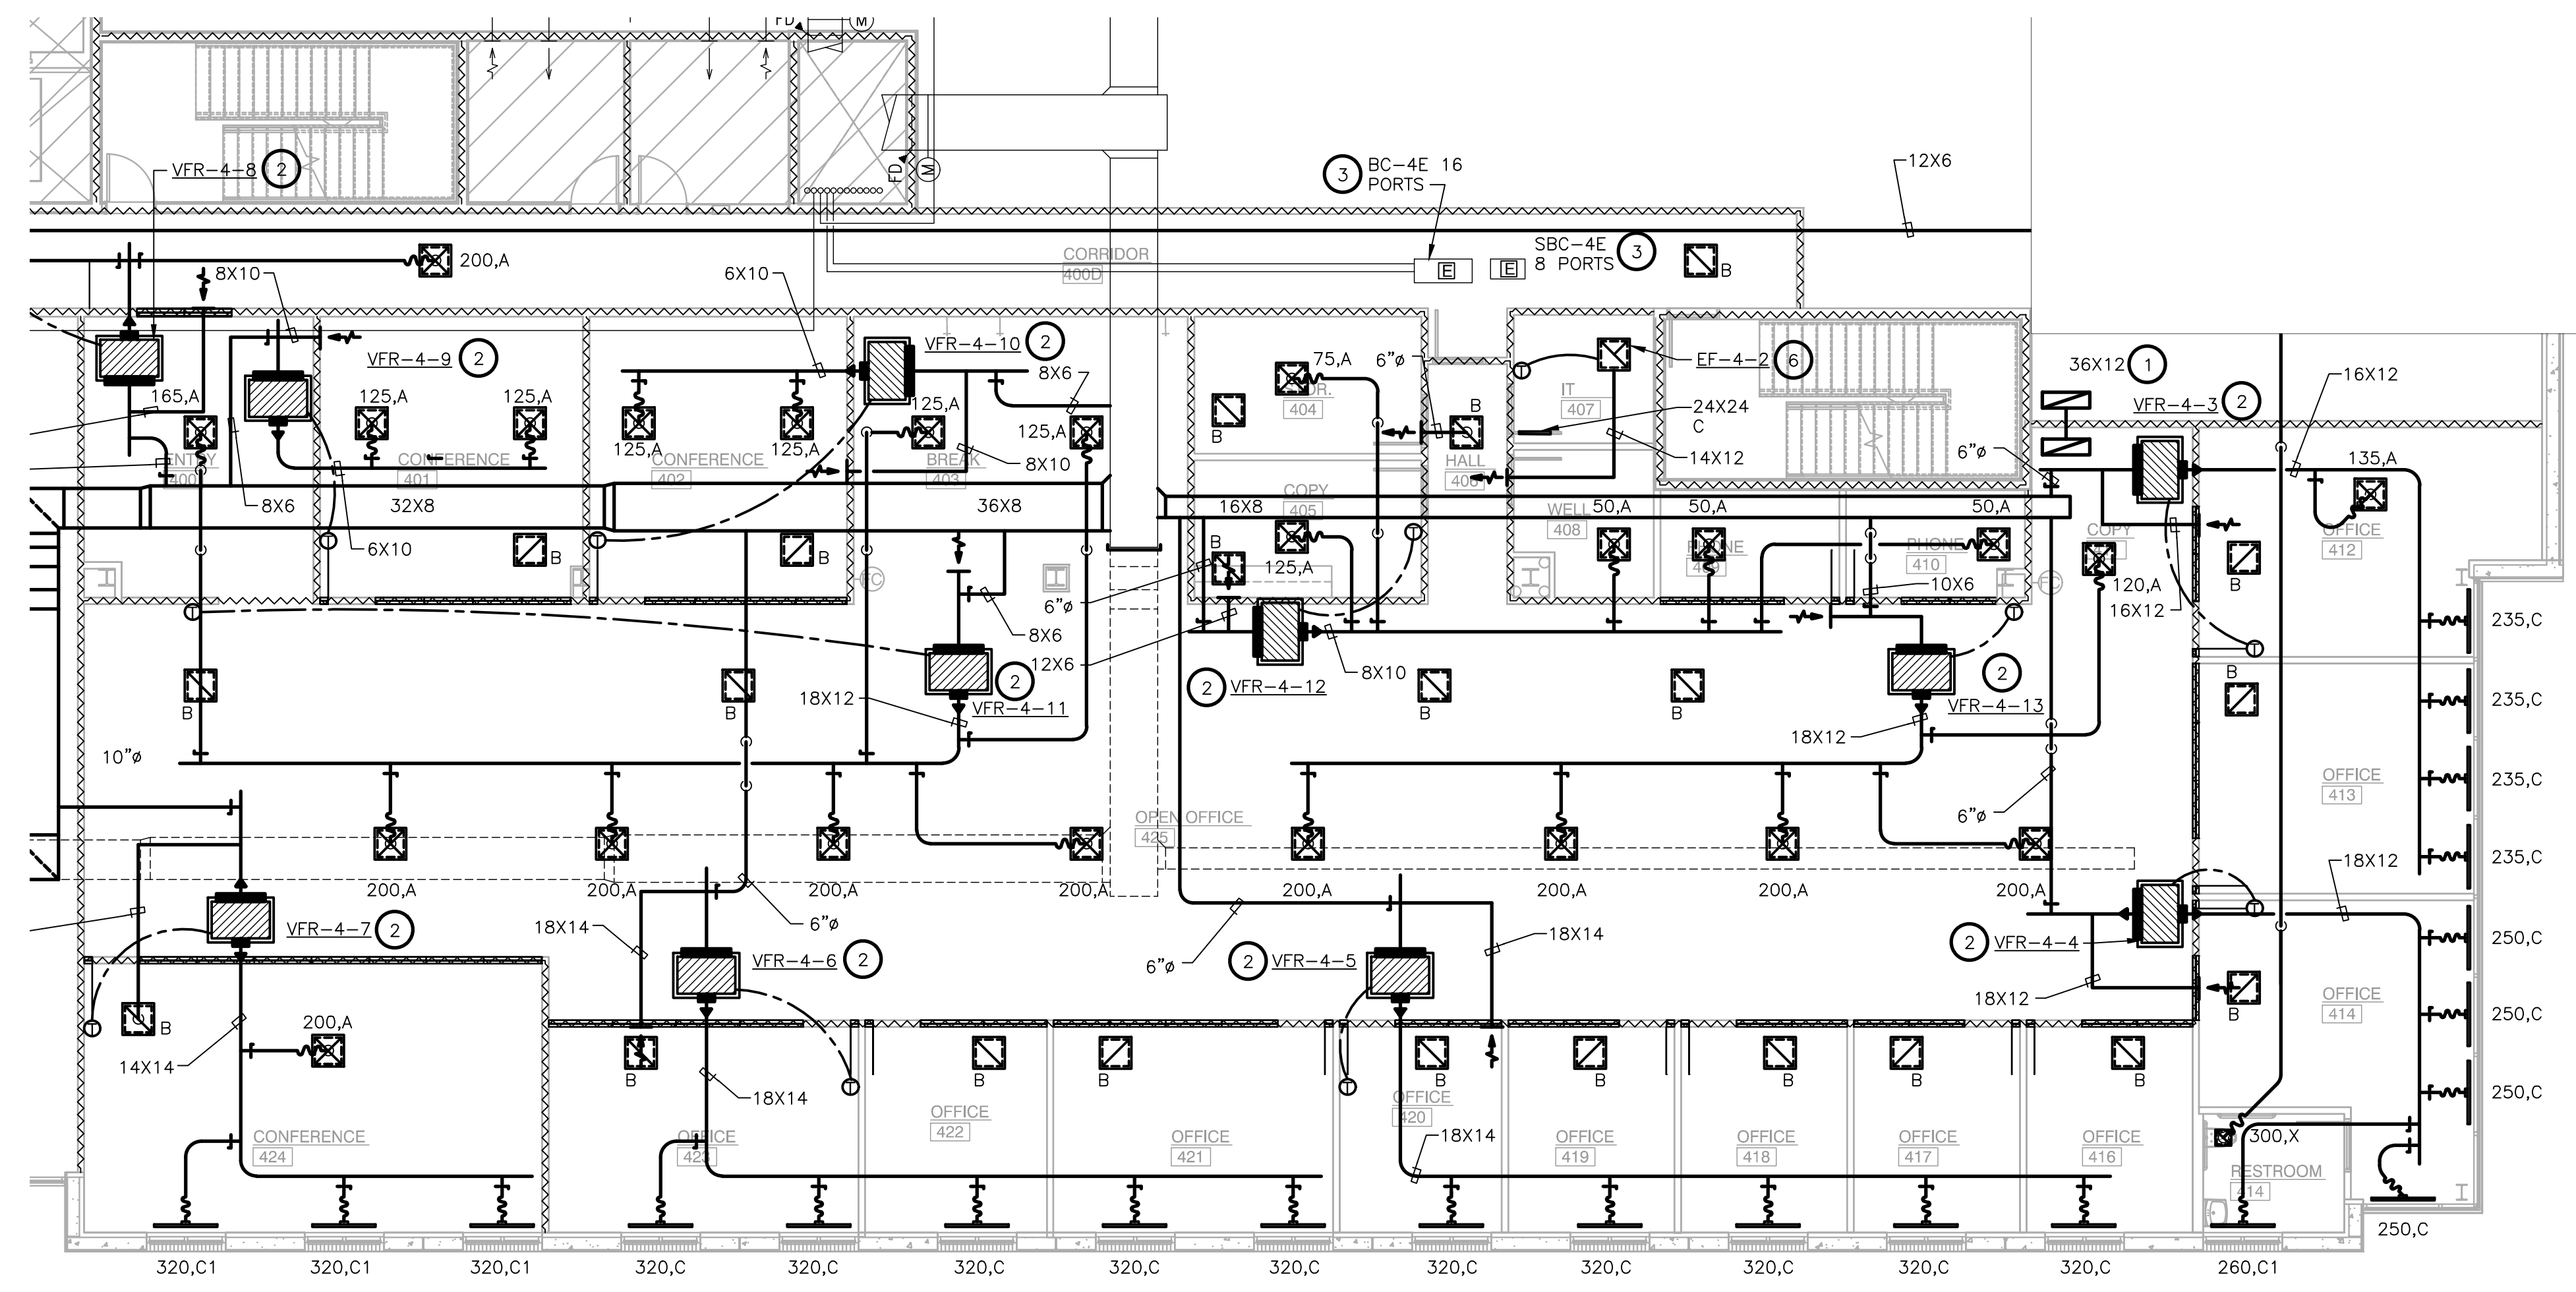

**1 LEVEL 04 MECHANICAL PLAN**  
SCALE: 1/8"=1'-0"

**NOTES BY SYMBOL (X) :**

1. PROVIDE ACOUSTICALLY LINED RETURN AIR BOOT THRU WALL TO DECK AS HIGH AS POSSIBLE ABOVE CEILING WITH INLET ELBOW AND OUTLET 90° ELBOW FACING UPWARD. SIZE PER PLANS. REFER TO DETAIL 01/M0.01 FOR MORE INFORMATION.
2. FC UNIT TO BE SUSPENDED FROM STRUCTURE. PROVIDE A GALVANIZED SHEET METAL PLATE WITH A MINIMUM OF 3" LARGER (ON EACH SIDE) THAN ANY DIMENSION OF THE UNIT AND MUST EXTEND UNDER THE CONDENSATE PUMPS. EXTEND FULL SIZED RETURN AIR PLENUM AS INDICATED ON DRAWINGS. PROVIDE MANUAL DAMPER AT OUTSIDE AIR DUCT CONNECTION TO PLENUM.
3. EXISTING BRANCH CONTROLLER SUSPENDED FROM STRUCTURE WITH ISOLATION SPRINGS.
4. EXTEND NEW FULL SIZE DUCT SAME SIZE AND MATERIALS TO MATCH EXISTING DUCT. VERIFY SIZE AT JOB SITE PRIOR TO BIDDING.
5. INSTALL EXHAUST FAN AS HIGH AS POSSIBLE FROM ALLTHREAD HANGER RODS WITH VIBRATION ISOLATOR PER EACH FAN.
6. INSTALL EXHAUST FAN AT CEILING AND SUSPEND FROM STRUCTURE USING ALLTHREAD HANGER RODS AND VIBRATION ISOLATORS PER EACH ROD. EXTEND EXHAUST DUCT OUT OF CEILING PLENUM AS SHOWN.

REFER TO SHEET M0.01  
FOR GENERAL NOTES,  
SCHEDULES AND SYMBOLS.

REVISION SUMMARY:  
• REMOVED SPRING ISOLATION.

NO.	ISSUED FOR:	DATE:
1	REVISION 1	04/17/2020

LANDLORD/CLIENT REVIEW ISSUE DATE: 03/30/20  
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CONSTRUCTION ISSUE DATE: 03/30/20

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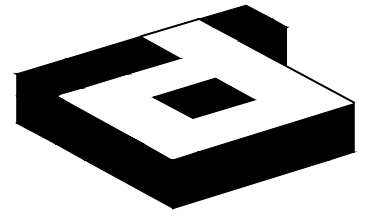
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DRAWING TITLE:  
**LEVEL 04 MECHANICAL PLAN - EAST**


DRAWING NUMBER:

**M2.04E**



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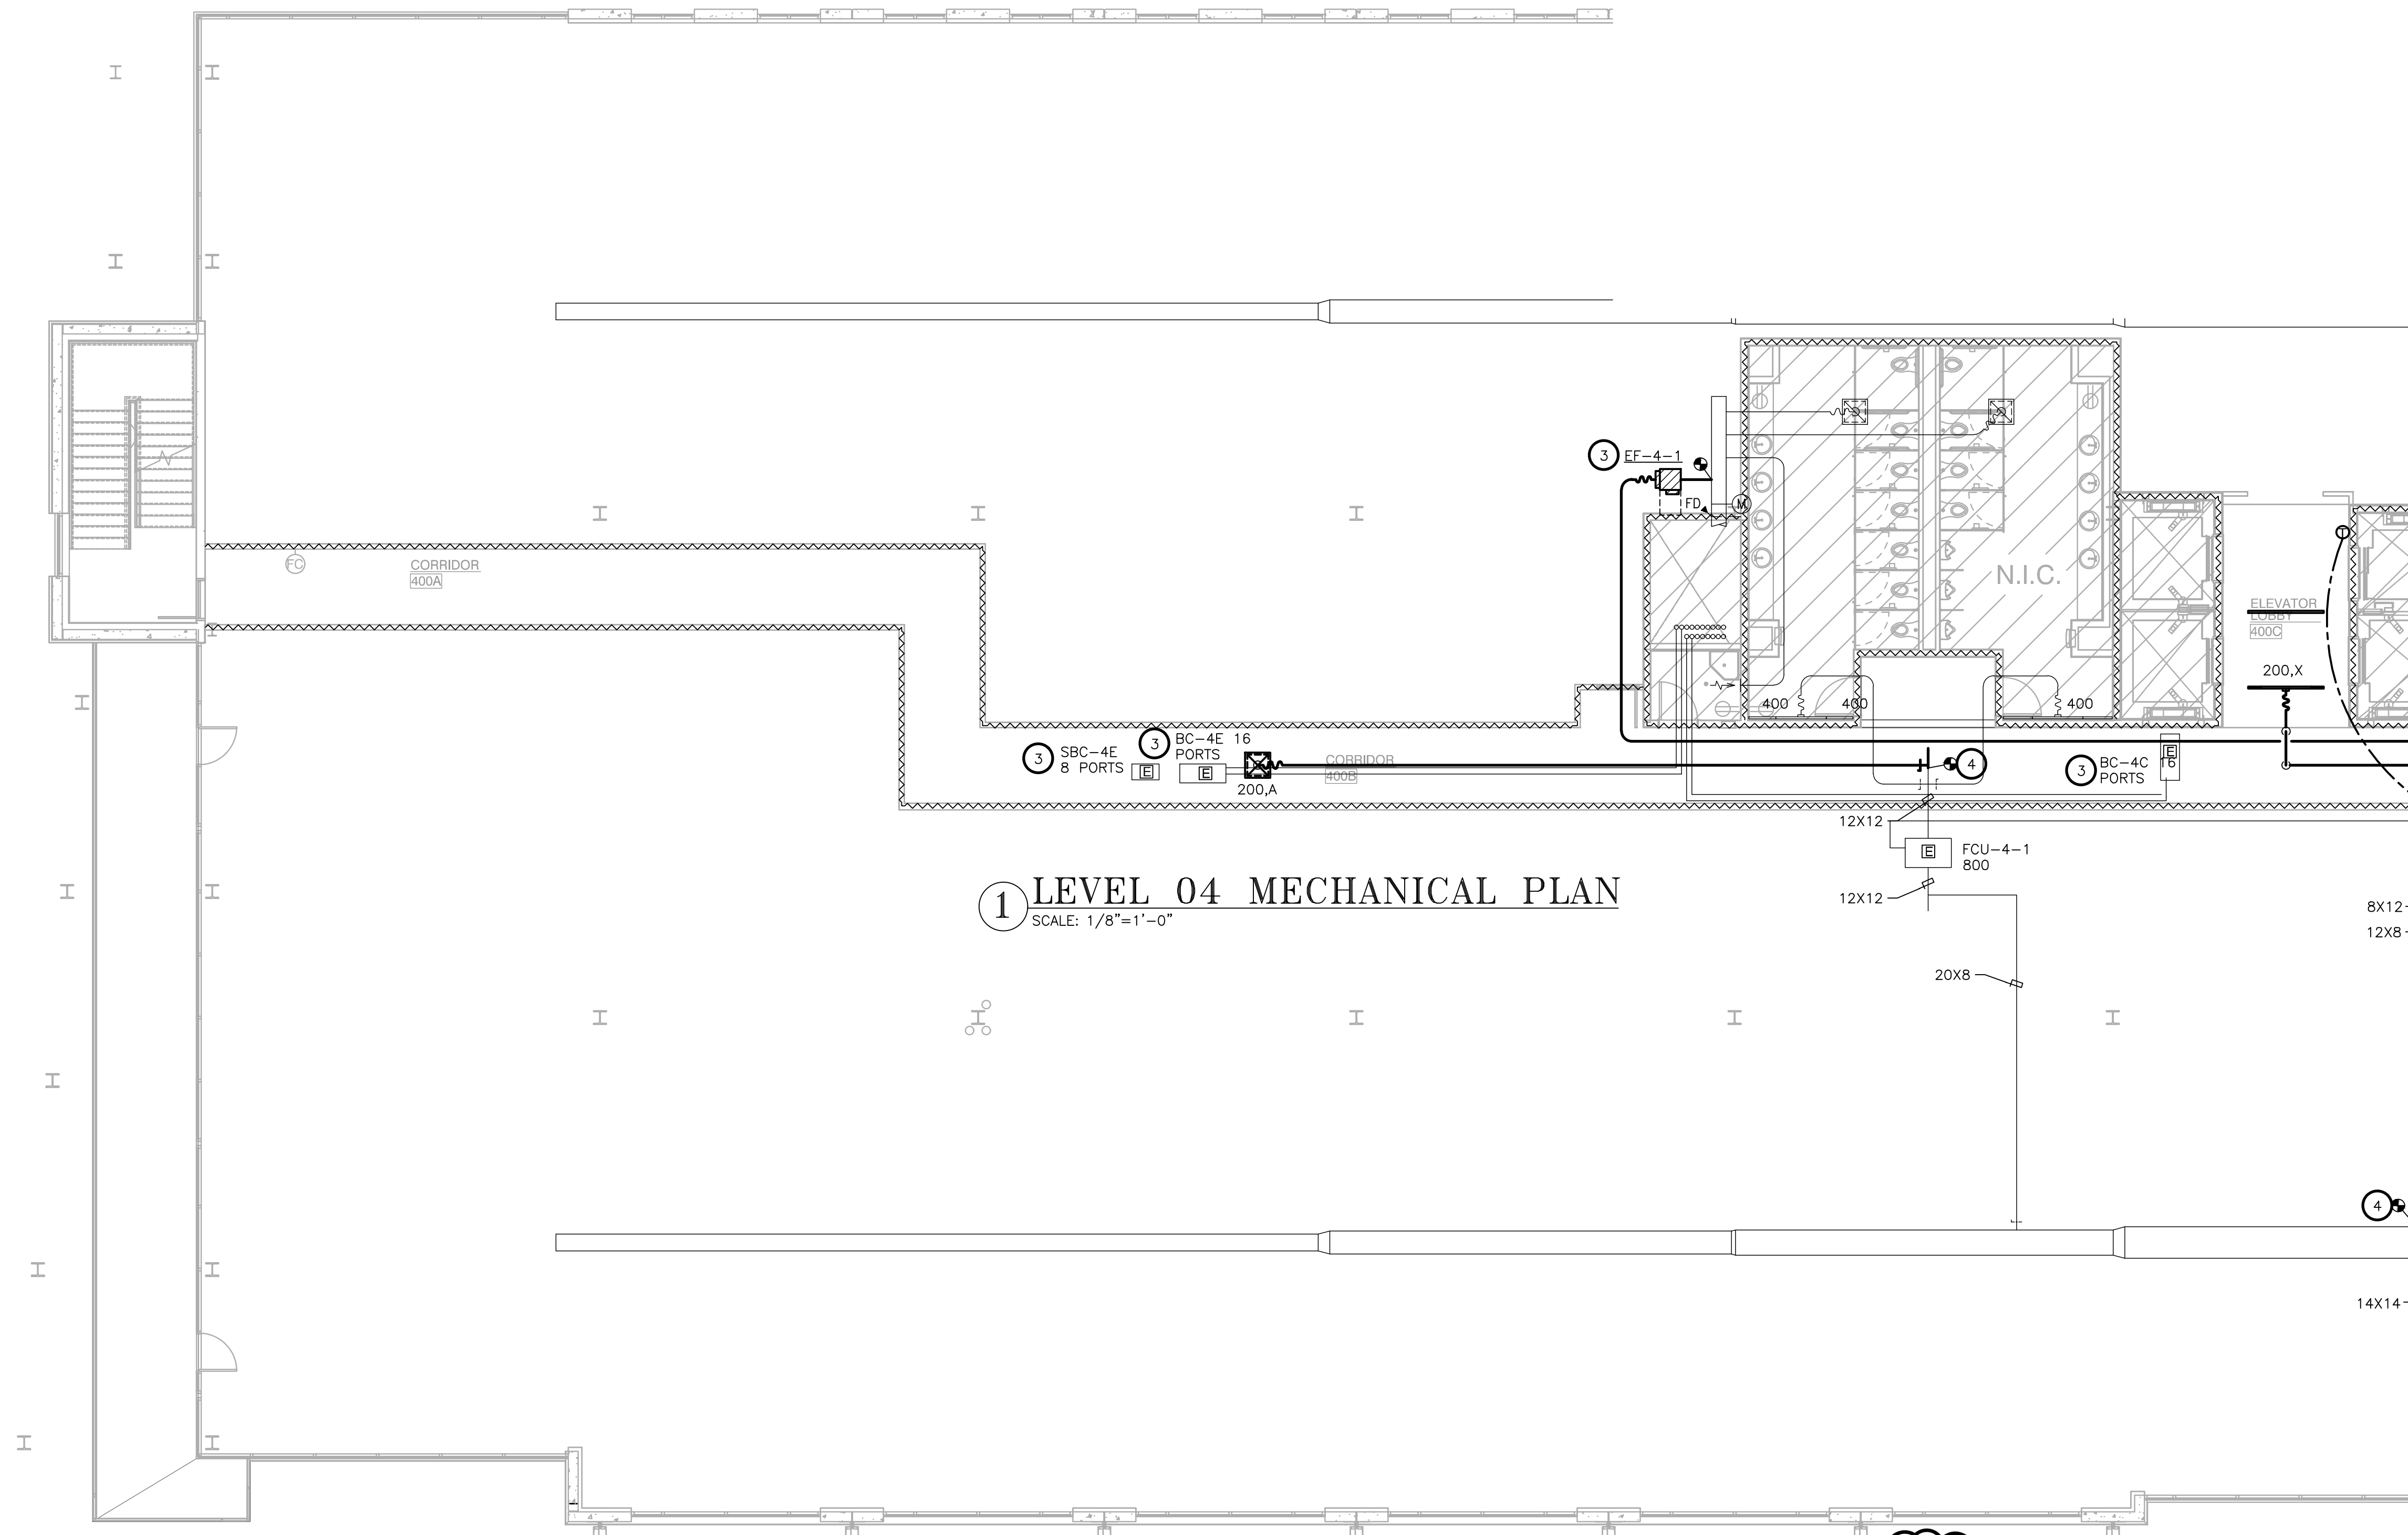
LANDLORD/CLIENT REVIEW ISSUE DATE: 03/30/20  
BID ISSUE DATE: 03/30/20  
CONSTRUCTION ISSUE DATE: 03/30/20

DRAWING TITLE:  
**LEVEL 04 MECHANICAL  
PLAN - WEST**

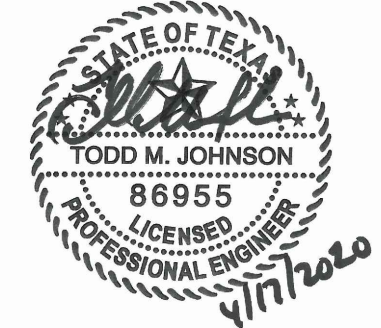DRAWING NUMBER:

**M2.04W**

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**1 LEVEL 04 MECHANICAL PLAN**  
SCALE: 1/8"=1'-0"


REVISION SUMMARY:  
• ADDED NOTE ABOUT KEYED NOTES.

REFER TO SHEET M2.04E  
FOR KEYED NOTES AND  
ADDITIONAL REQUIREMENTS.

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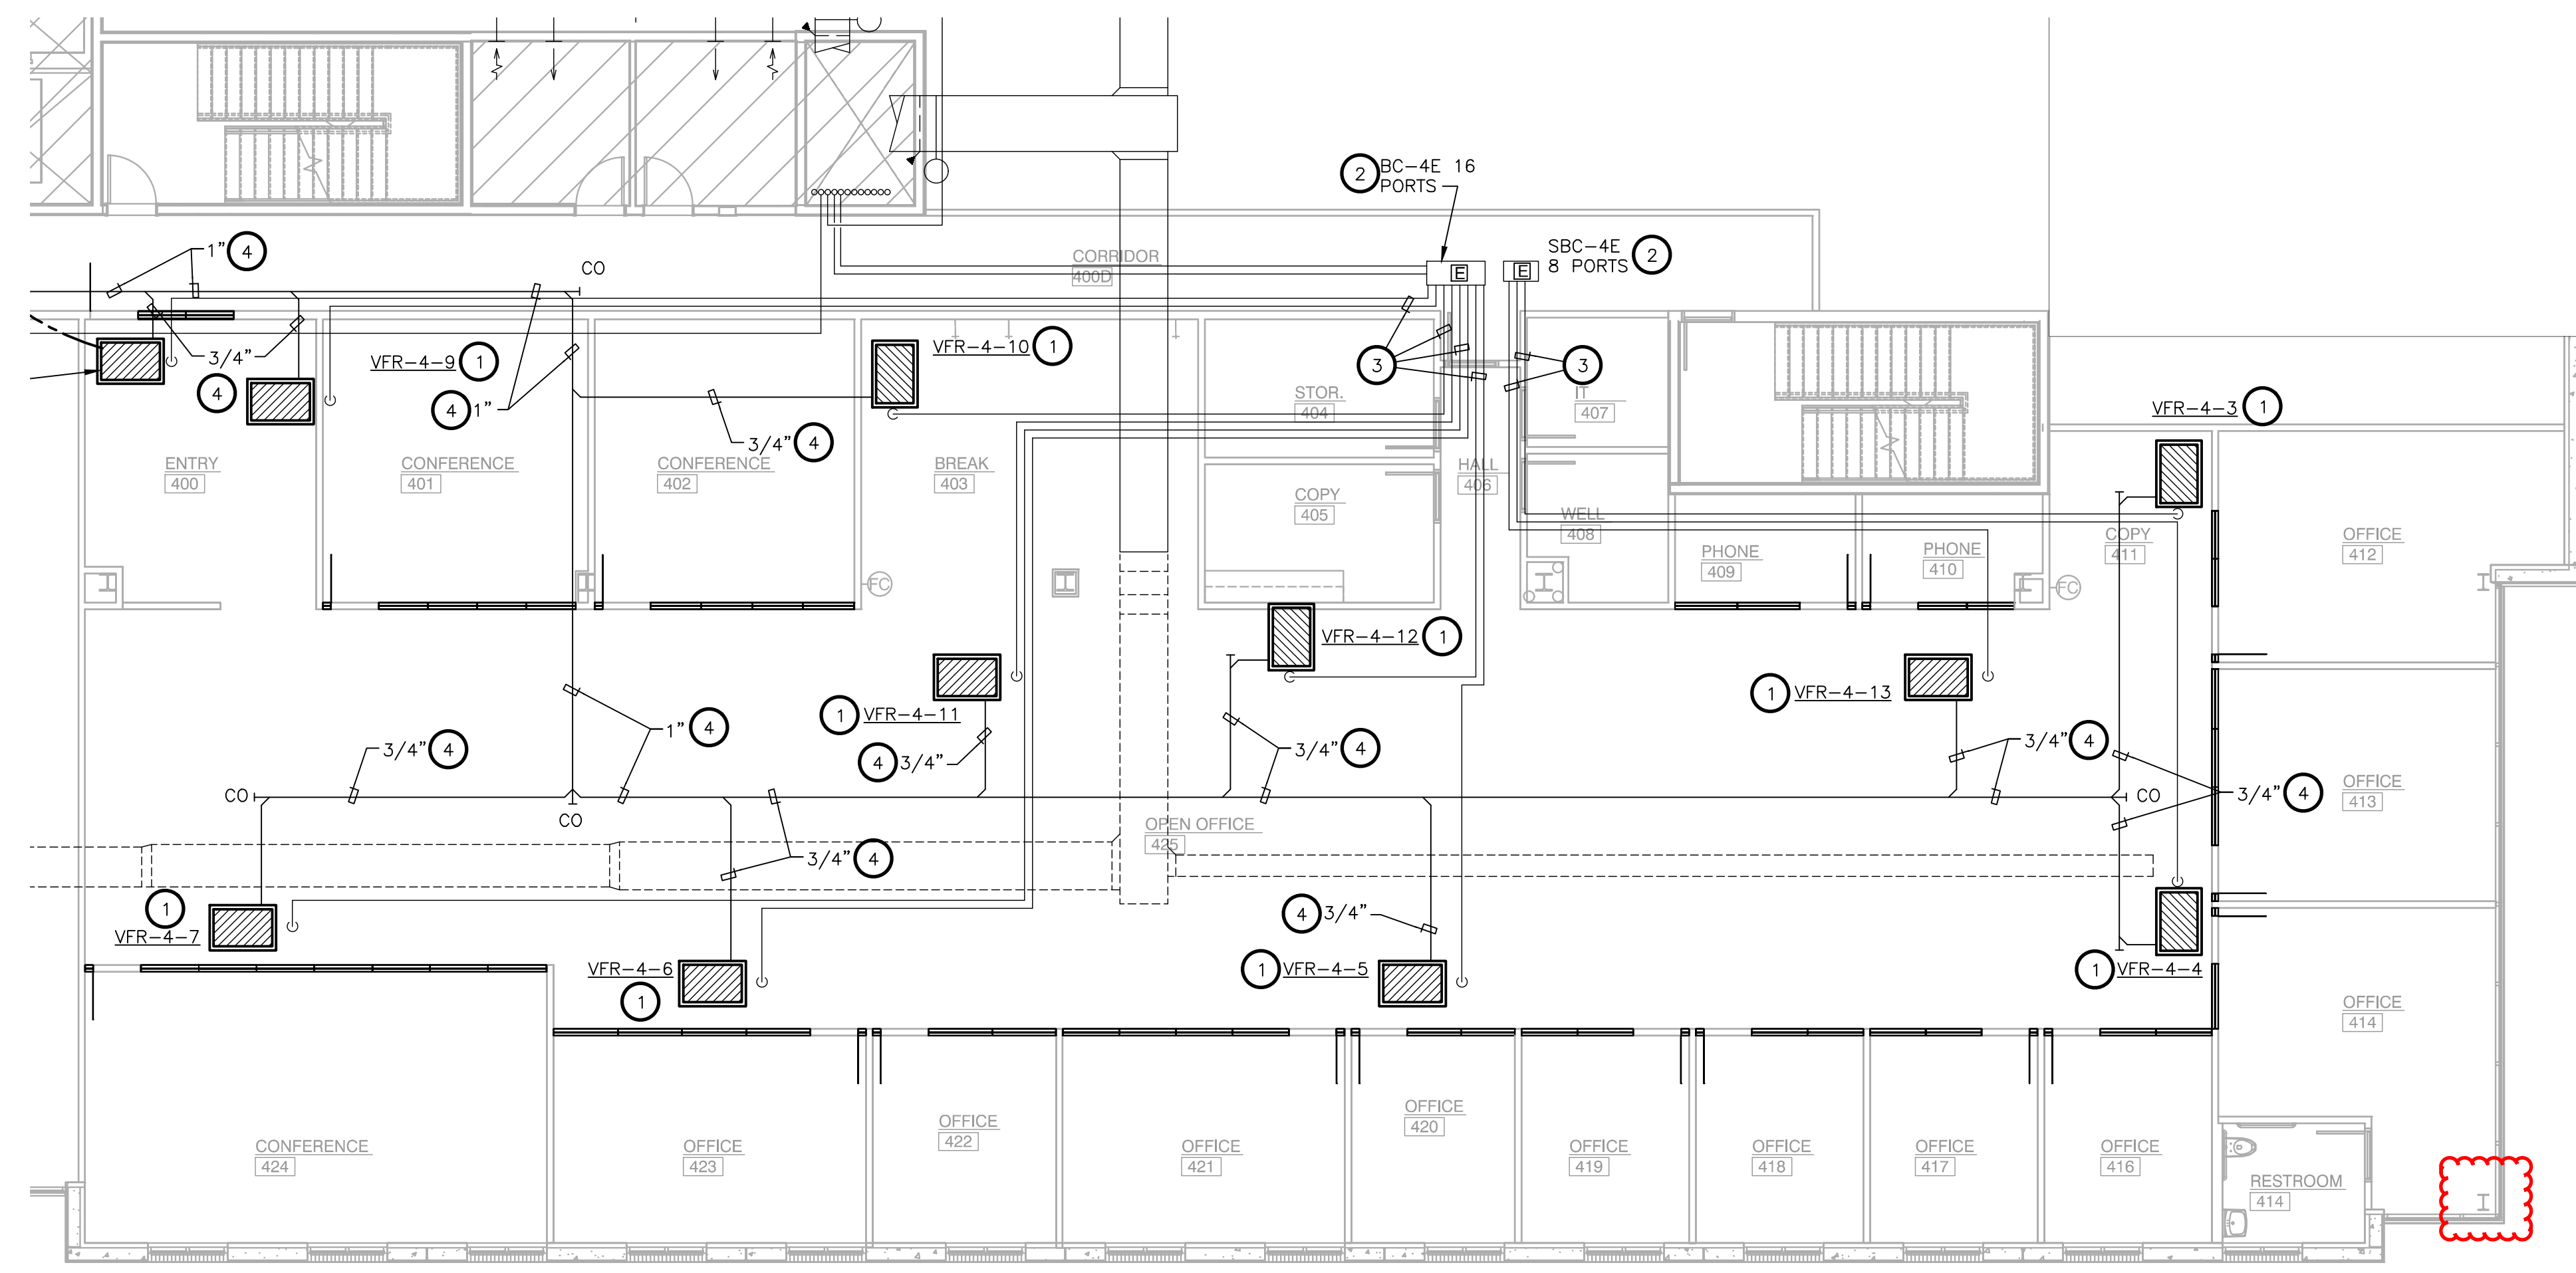
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DRAWING TITLE:  
**LEVEL 04 REFRIGERANT  
PIPING PLAN - EAST**

DRAWING NUMBER:

**M2.14E**
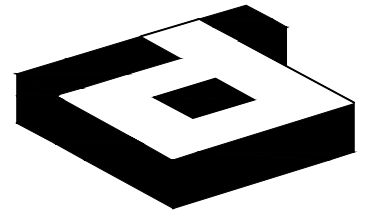
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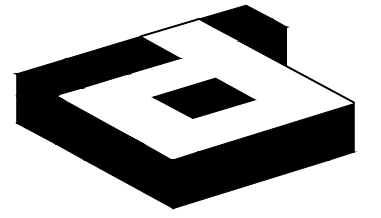
**NOTES BY SYMBOL (X) :**

- FC UNIT TO BE SUSPENDED FROM STRUCTURE. PROVIDE A GALVANIZED SHEET METAL SECONDARY DRAIN PAN THAT IS A MINIMUM OF 3" LARGER (ON EACH SIDE) THAN ANY DIMENSION OF THE UNIT AND MUST EXTEND UNDER THE CONDENSATE PUMPS.
- EXISTING BRANCH CONTROLLER SUSPENDED FROM STRUCTURE WITH ISOLATION SPRINGS.
- COORDINATE WITH MANUFACTURER'S SPECIFICATIONS FOR REFRIGERANT REQUIREMENTS. COORDINATE ROUTING FROM FC UNIT TO BRANCH CONTROLLER. LOCATION OF FCU SHALL NOT EXCEED 150' OF PIPING BETWEEN UNITS.
- PROVIDE INSULATED CONDENSATE DRAIN AND OVERFLOW PIPING ABOVE CEILING. EXTEND AND DISCHARGE TO NEAREST JANITORS MOP SINK. ALL PIPING SHALL BE INSTALLED AS HIGH AS POSSIBLE, AND SLOPED AT 1/8" PER FOOT TOWARDS FLOOR DRAIN. PROVIDE CONDENSATE PUMP CAPABLE OF A MINIMUM OF 10' OF HEAD PRESSURE WITH UNIT IF REQUIRED SLOPE IS UNATTAINABLE.

REFER TO SHEET M0.01  
FOR GENERAL NOTES,  
SCHEDULES AND SYMBOLS.


**1 LEVEL 04 MECHANICAL PLAN**  
SCALE: 1/8"=1'-0"

REVISION SUMMARY:  
• REMOVED SPRING ISOLATION.



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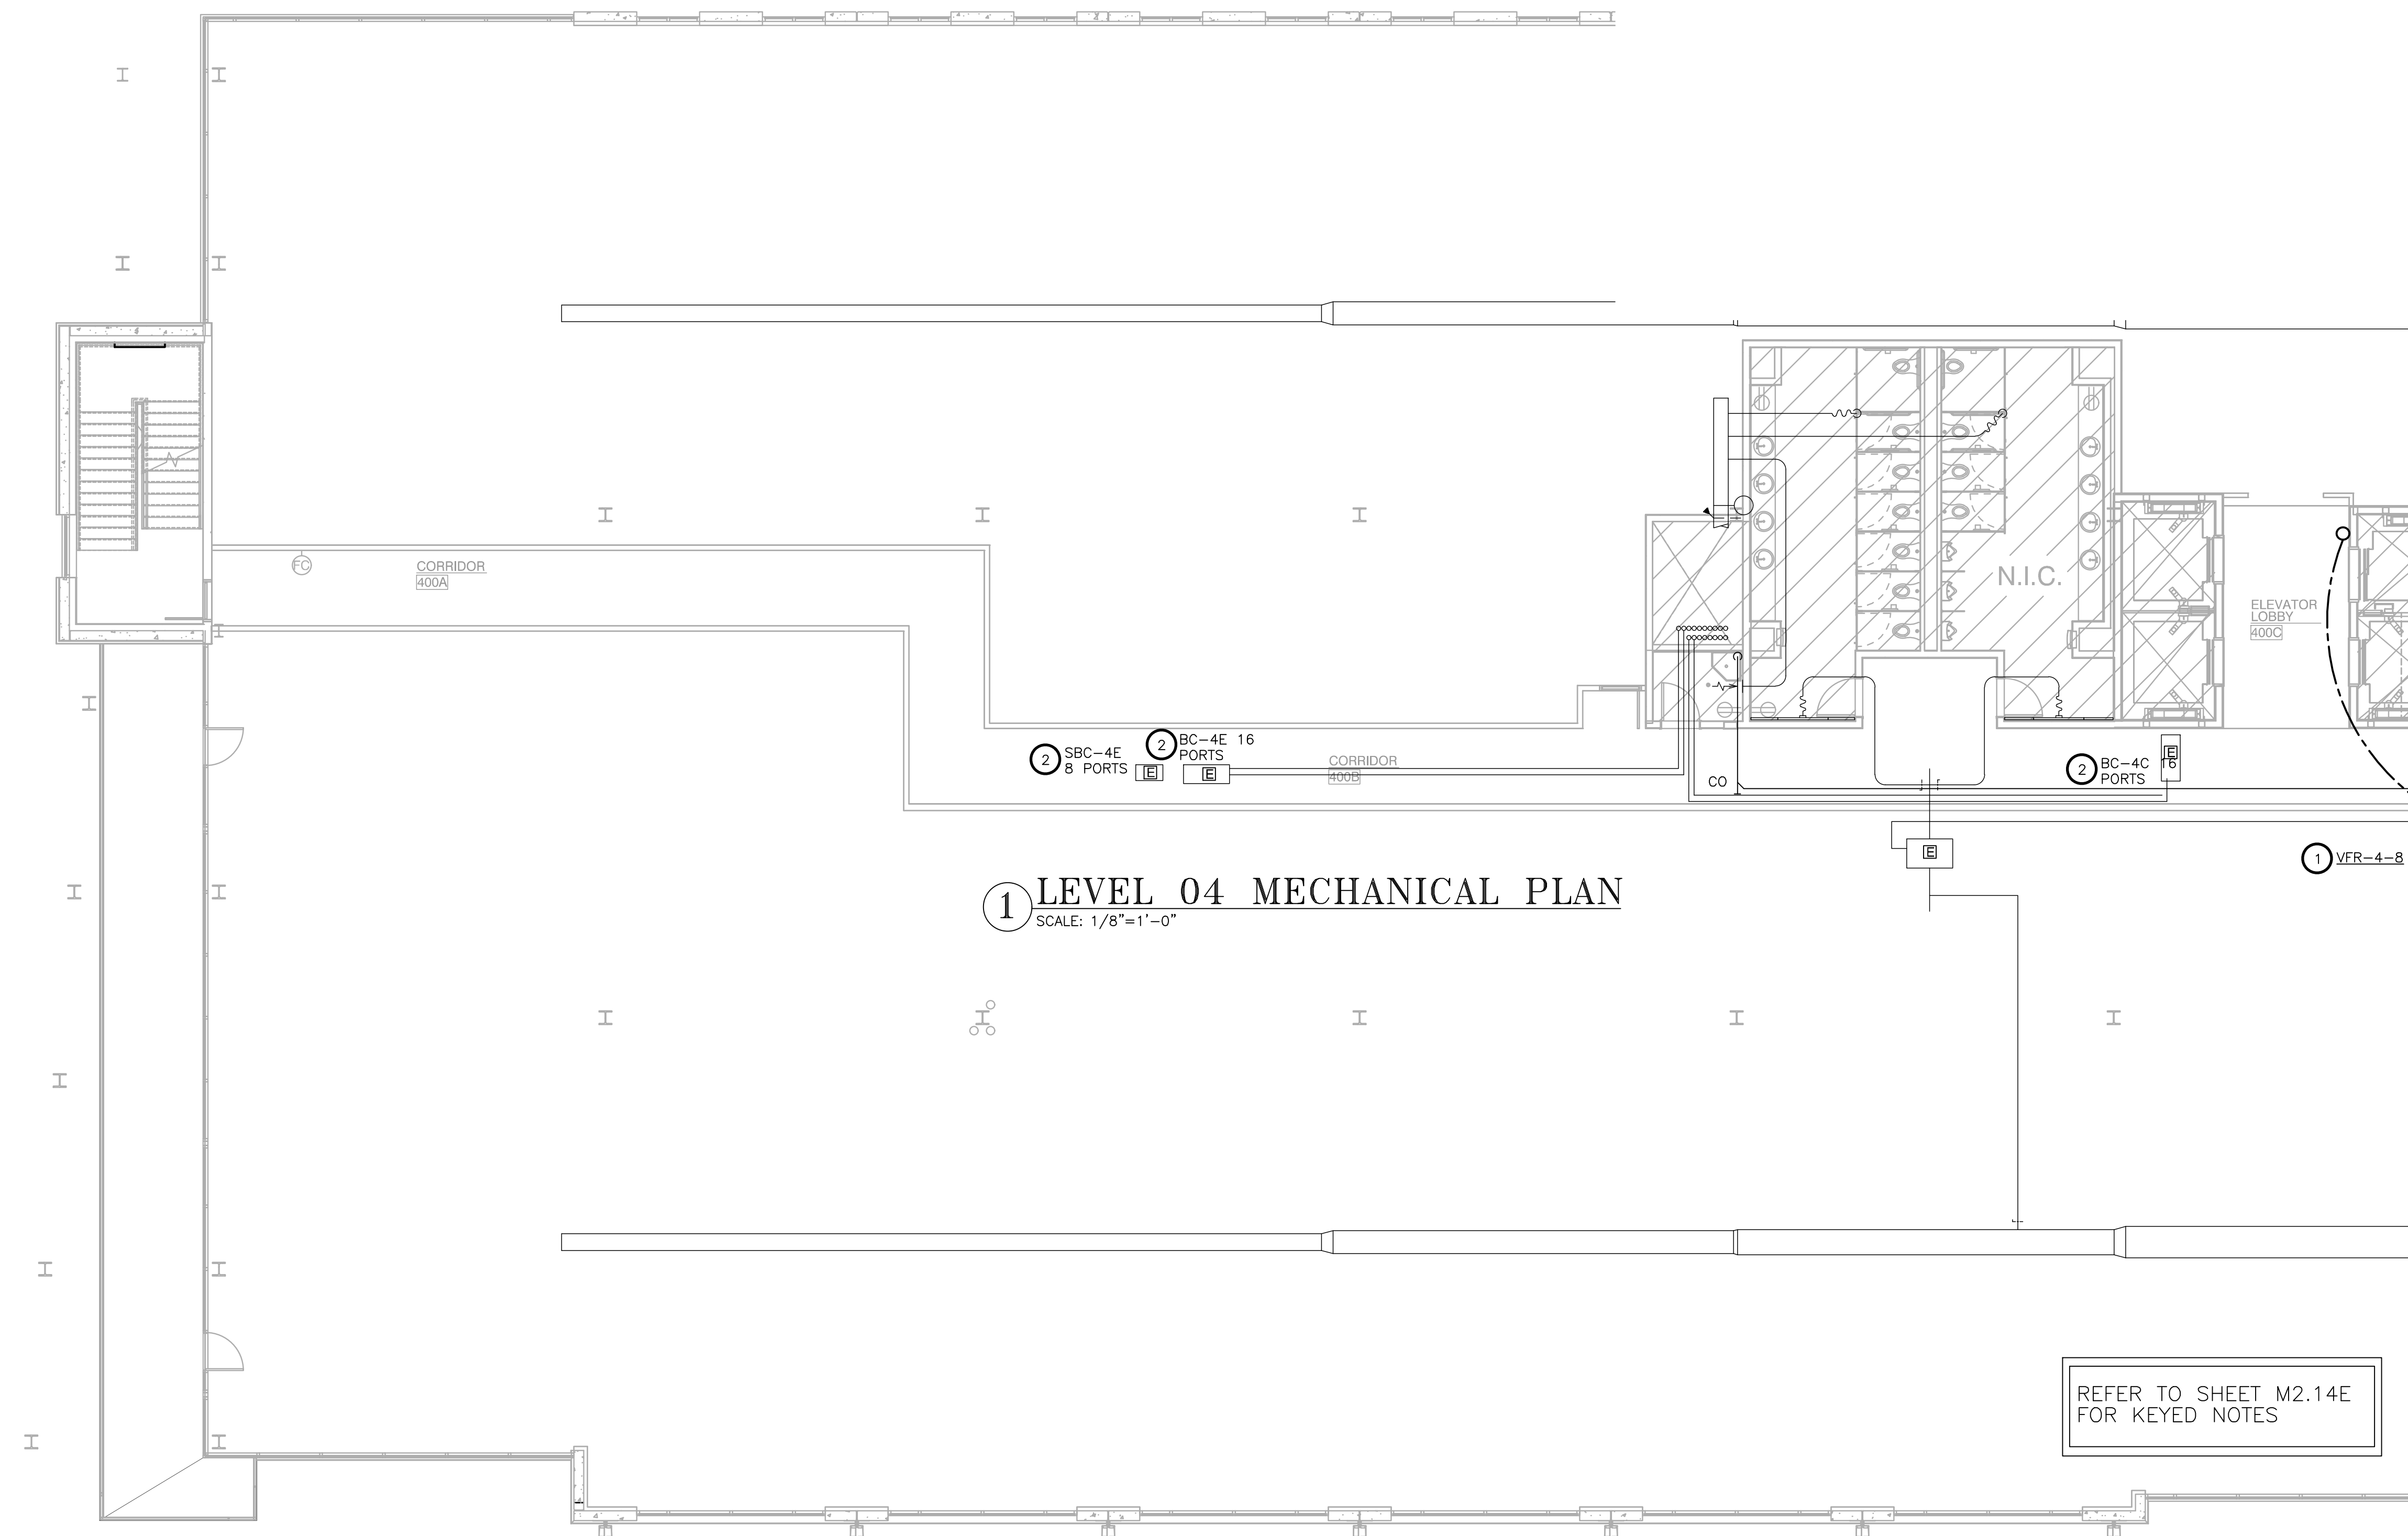


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**1 LEVEL 04 MECHANICAL PLAN**  
SCALE: 1/8"=1'-0"

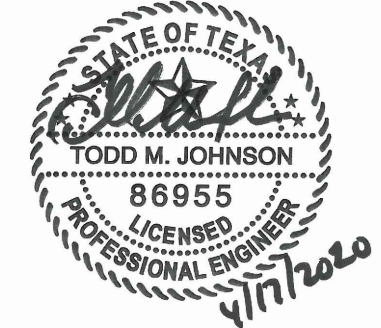REFER TO SHEET M2.14E  
FOR KEYED NOTES

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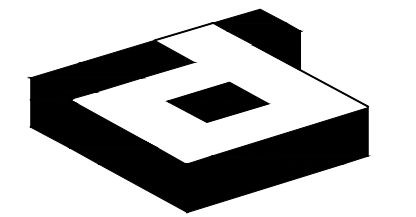
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DRAWING TITLE:  
**LEVEL 04 MECHANICAL PLAN - WEST**

DRAWING NUMBER:

**M2.14W**

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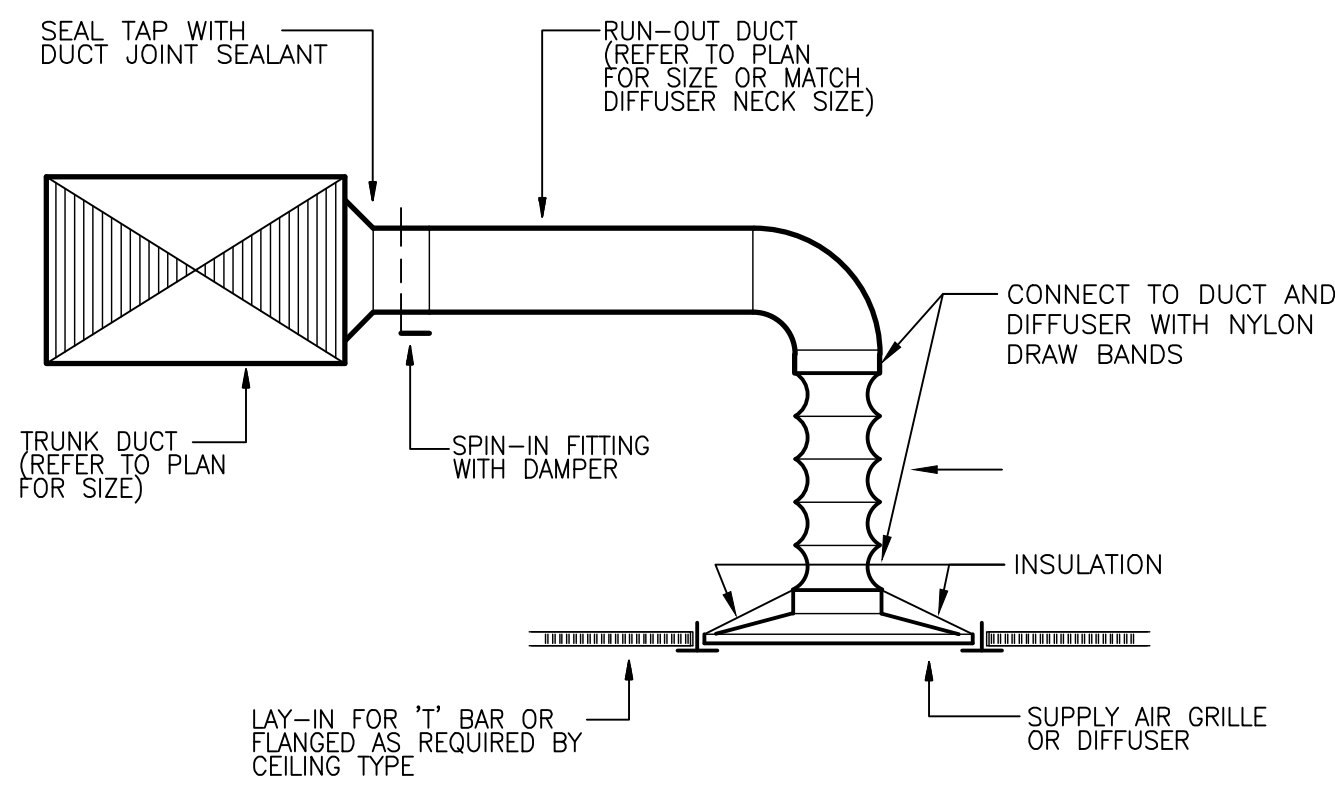
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DRAWING TITLE:  
**MECHANICAL**  
DETAILS


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**M3.01**


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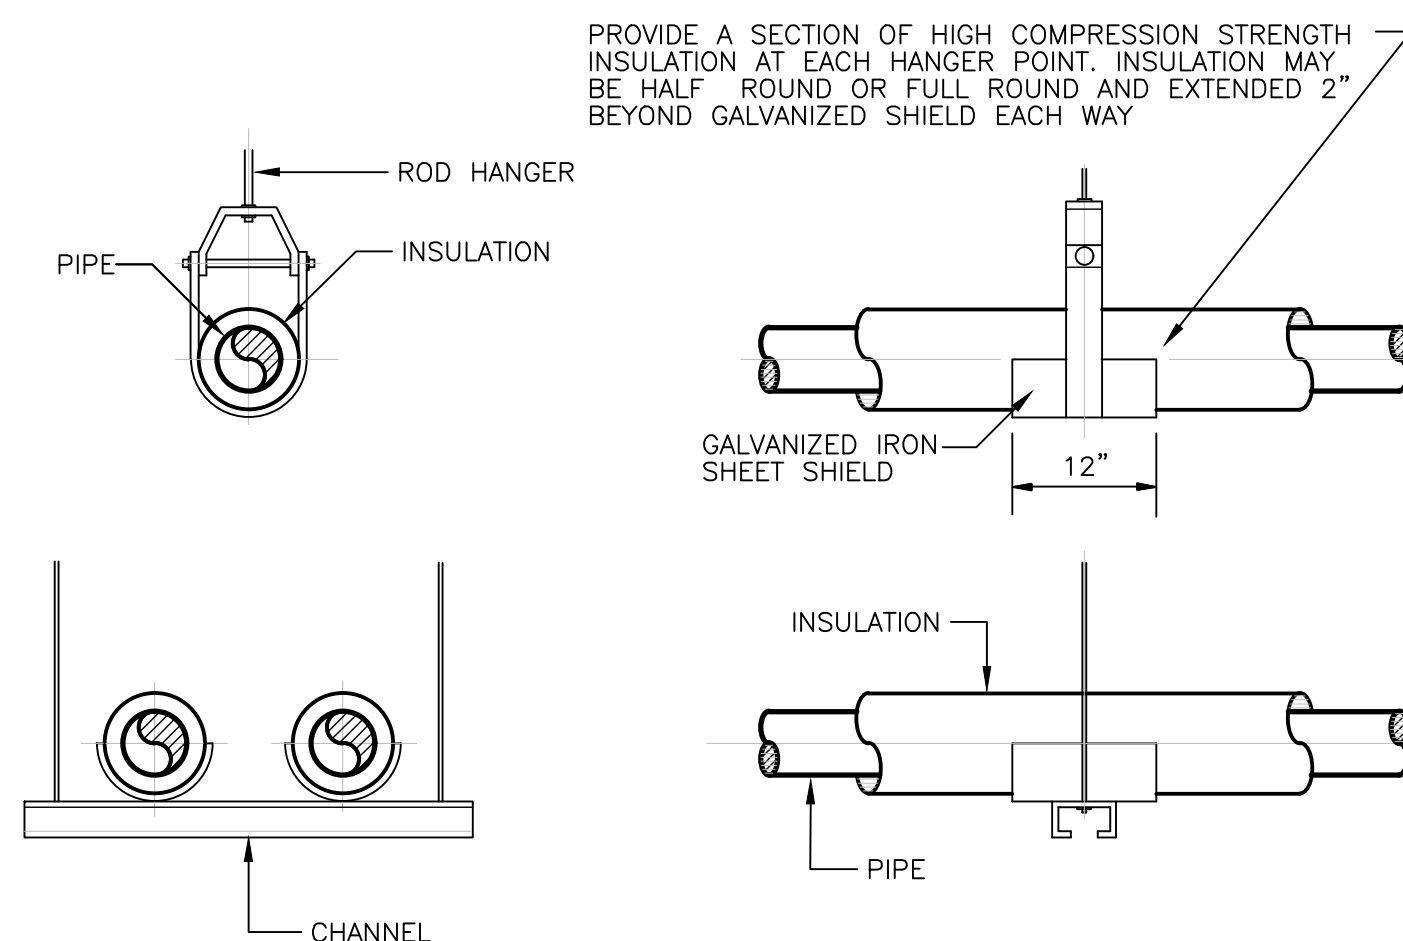
**1 DIFFUSER CONNECTION DETAIL**  
SCALE: NOT TO SCALE




**2 VFR UNIT INSTALLATION DETAILS**  
SCALE: NOT TO SCALE

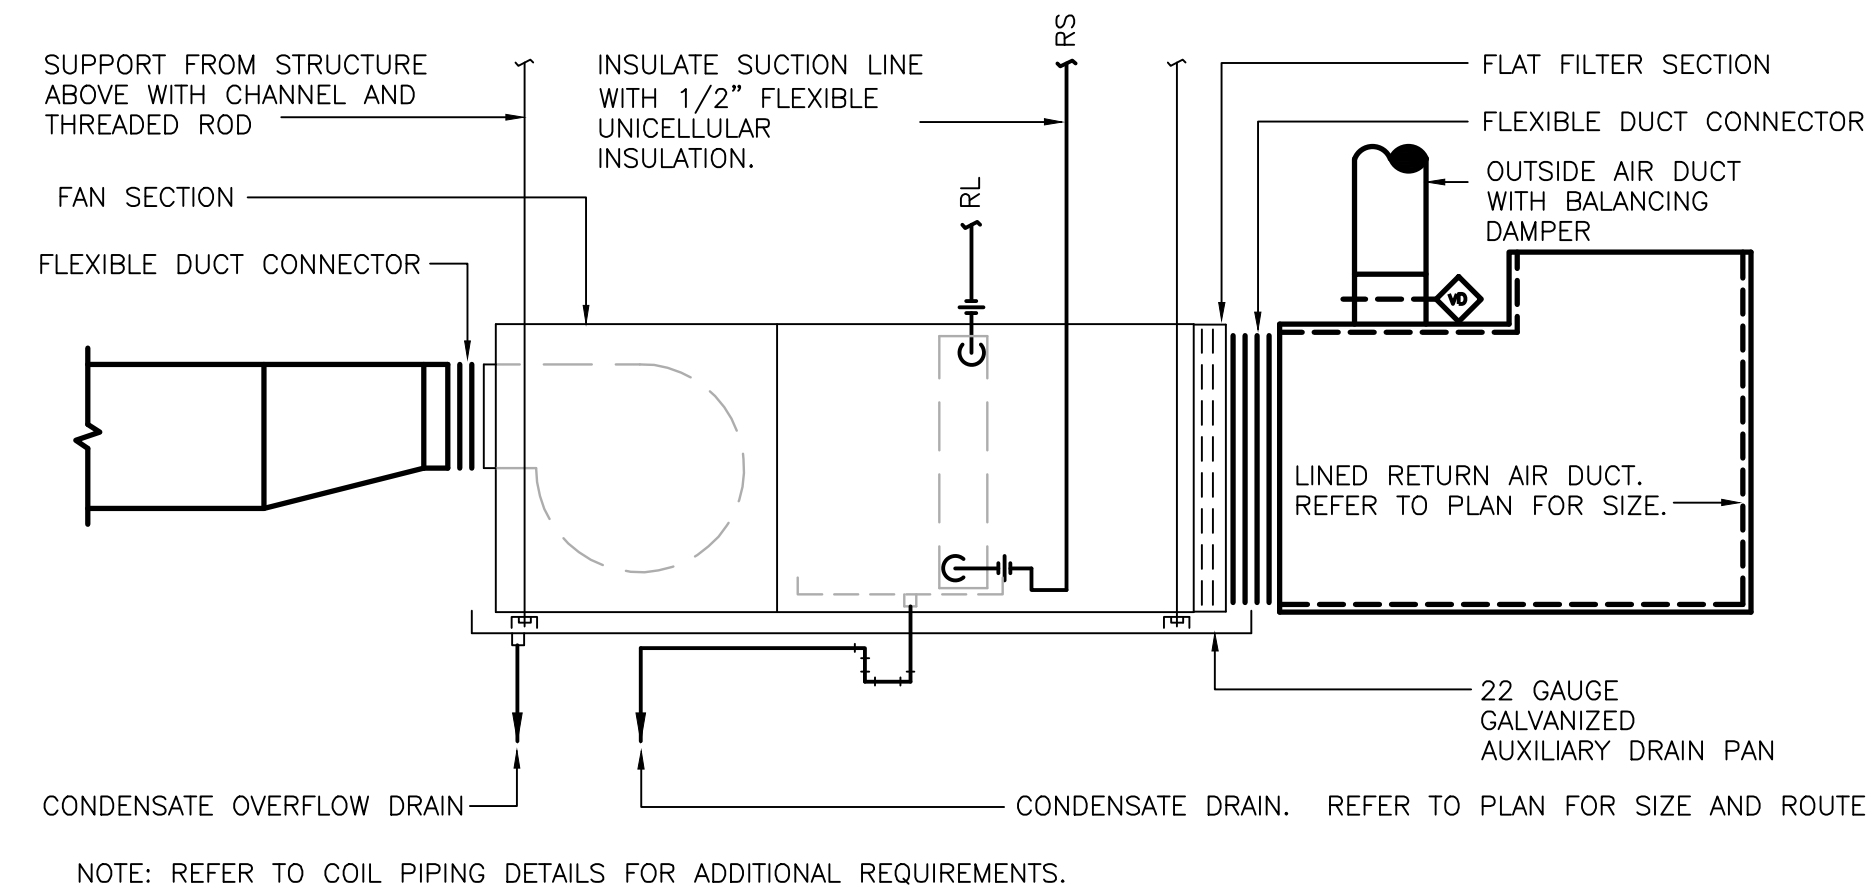

**3 CONDENSATE PUMP DETAIL**  
SCALE: NOT TO SCALE

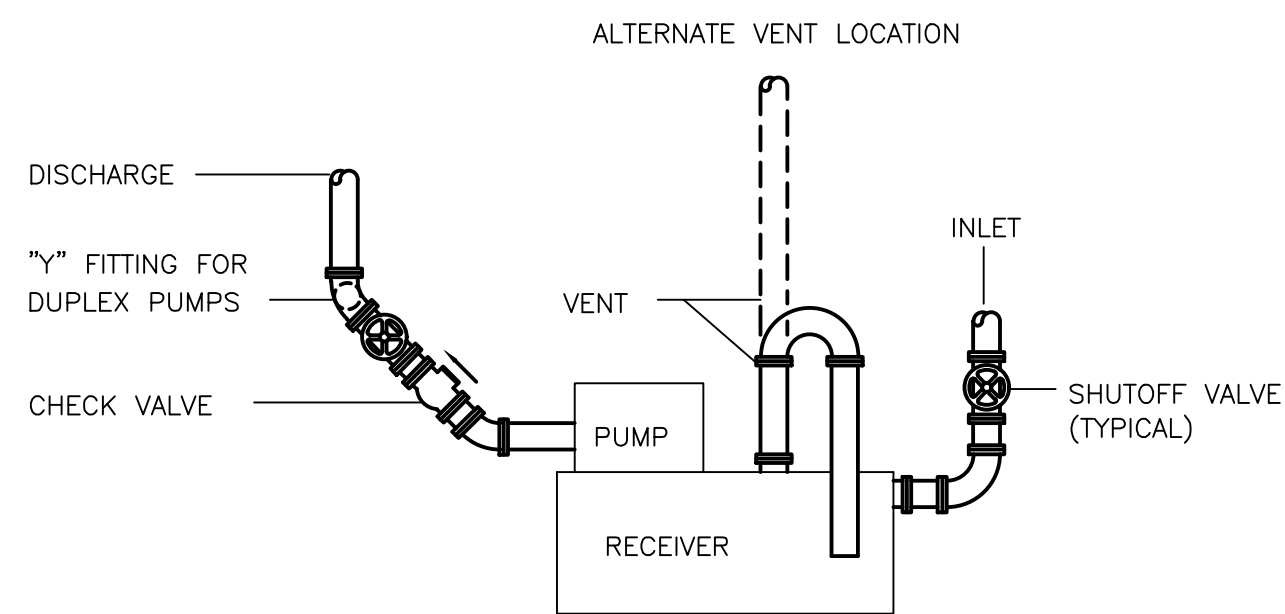

**4 PIPE HANGING SUPPORT DETAILS**  
SCALE: NOT TO SCALE

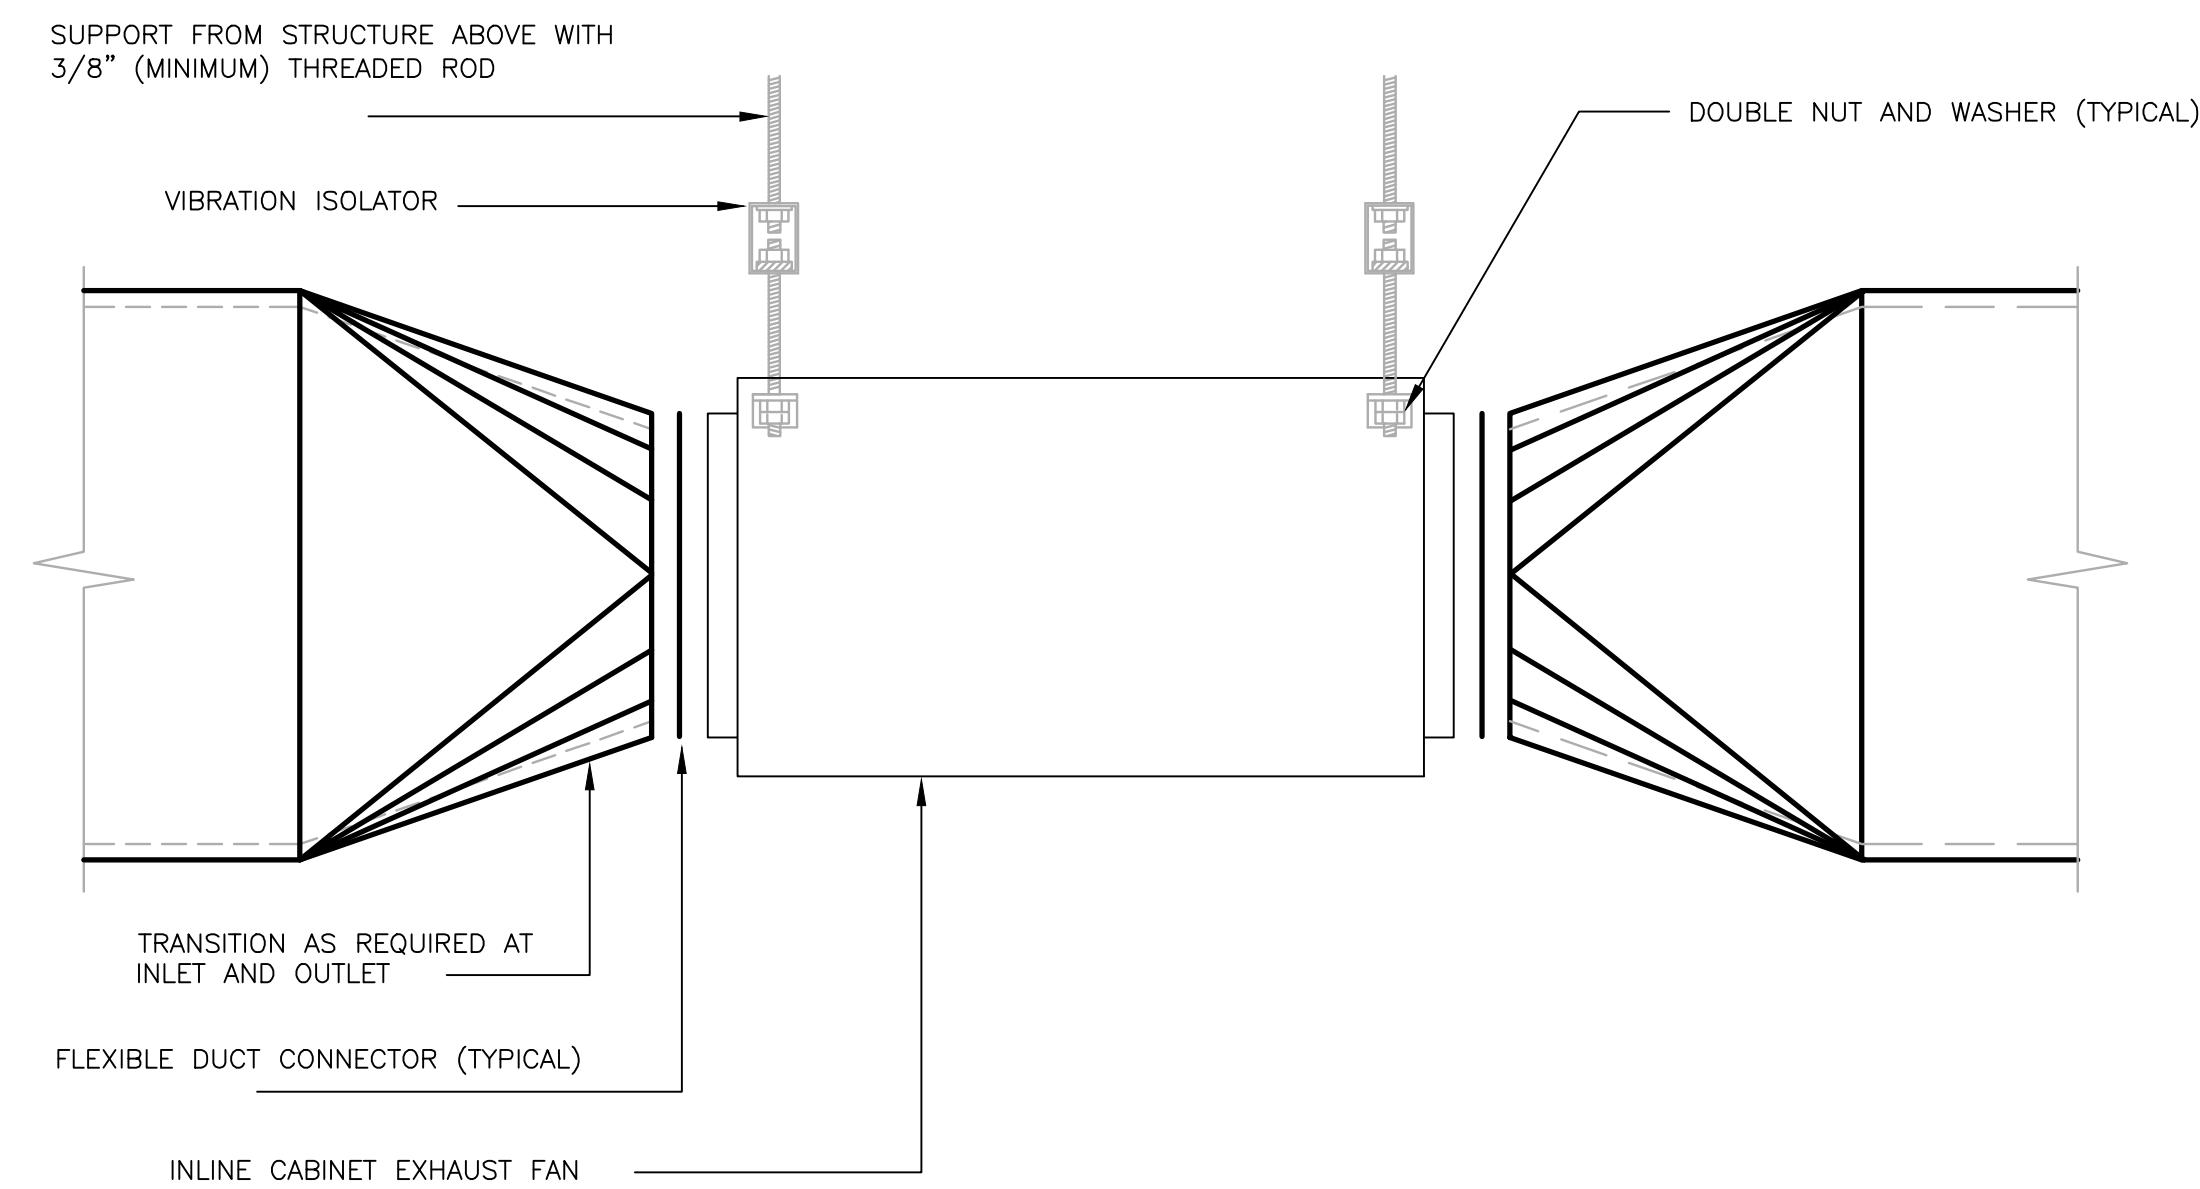

**5 INLINE CABINET FAN INSTALLATION DETAIL**  
SCALE: NOT TO SCALE

**LOWER GENERAL NOTES:**

- A. ALL CIRCUITS SHALL BE 120V, 20A CIRCUITS WITH #12, #12G, IN 3/4" UNLESS NOTED OTHERWISE.
- B. ALL CONDUCTORS GREATER THAN 60' IN LENGTH SHALL BE SIZED FOR A MAXIMUM VOLTAGE DROP OF 3% OVER THE TOTAL LENGTH OF THE CIRCUIT CALCULATED AT 80% OF FULL LOAD OF THE OVERCURRENT DEVICE PROTECTING THE CONDUCTOR. CONTRACTOR SHALL PROVIDE PIG-TAIL OR ENCLOSED TERMINATION BLOCKS AS REQUIRED TO LAND CIRCUITS ON THE DEVICES OR EQUIPMENT.
- C. CONTRACTOR MAY COMBINE THREE (3) CIRCUITS PER NEUTRAL AND GROUND WIRE EXCEPT AS OTHERWISE NOTED. COMBINED NEUTRAL CIRCUITS SHALL MEET NEC REQUIREMENTS WITH THE HANDLES AND COMPLIANCE LABELING.
- D. ALL EXISTING CIRCUITS WITHIN THE SCOPE OF WORK AREA THAT ARE NOT REUSED FOR THIS REMODEL SHALL BE REMOVED BACK TO THE PANELS AND THE PLACARDS SHALL INDICATE THE BREAKERS AS SPARES.
- E. PANELBOARD DIRECTORIES SHALL BE COMPLETELY FILLED OUT TO ACCURATELY IDENTIFY EACH CIRCUIT (EXISTING AND NEW CIRCUITS) IN ALL PANELS WITHIN SCOPE OF WORK. OBTAIN BUILDING MANAGEMENT/OWNER'S APPROVAL OF IDENTIFICATION. DIRECTORIES SHALL BE TYPEWRITTEN.
- F. JUNCTION BOXES AND/OR DEVICE BOXES SHALL NOT BE MOUNTED BACK TO BACK WHEN FLUSH MOUNTED IN A WALL. JUNCTION BOXES AND /OR DEVICE BOXES FLUSH MOUNTED ON OPPOSITE SIDES OF A WALL SHALL NOT BE INSTALLED IN THE SAME STUD SPACE.
- G. ALL RECEPTACLES MOUNTED ABOVE OR BELOW KITCHEN/BREAK ROOM COUNTERS OR COUNTERS WITH A SINK OR ANY OTHER WATER DISPENSING MECHANISM SHALL BE GFCI PROTECTED. ALL RECEPTACLES INSTALLED IN AN OUTDOOR LOCATION OR INTENDED TO PROVIDE POWER FOR VENDING MACHINES SHALL BE GFCI TYPE DEVICES. IN LOCATIONS WHERE THE RECEPTACLES ARE BEHIND APPLIANCES, IF THE AUTHORITY HAVING JURISDICTION REQUIRES REMOTE RESET BUTTONS, CONTRACTOR SHALL COORDINATE THE BUTTON LOCATIONS WITH THE ARCHITECT PRIOR TO ROUGH-IN, OR PROVIDE GFCI CIRCUIT BREAKERS WHEN POSSIBLE.
- H. ALL DEDICATED CIRCUITS (CIRCUITS SERVING A SINGLE DEVICE) SHALL HAVE SEPARATE NEUTRAL AND GROUND WIRES. THIS REQUIREMENT DOES NOT APPLY TO APPLIANCE CIRCUITS.
- I. PROVIDE 3/4" CONDUIT AND PULLSTRING, FROM EACH WALL MOUNTED TELEPHONE/DATA OUTLET. ROUTE TO +4" ABOVE SUSPENDED CEILING. AT SYSTEMS FURNITURE FEEDS, CONDUIT SHALL BE 1-1/4".
- J. ELECTRICAL CONTRACTOR SHALL PROVIDE A 4"x4"x2-5/8" STEEL JUNCTION BOX IN WALL WITH A SINGLE GANG MUD RING AND 3/4" METAL CONDUIT TO A MINIMUM OF 4" ABOVE FINISHED ACCESSIBLE CEILING FOR ALL THERMOSTATS AND HVAC SENSORS. COORDINATE EXACT LOCATIONS WITH MECHANICAL CONTRACTOR AND ARCHITECT. PROVIDE A PULL STRING INSTALLED FOR FUTURE USE. PULL STRING SHALL BE SECURED AT EACH END TO PREVENT ACCIDENTAL REMOVAL.
- K. PROVIDE 3/4" CONDUIT AND PULLSTRING, FROM EACH FLOOR MOUNTED TELEPHONE/DATA OUTLET TO THE NEAREST WALL THEN ROUTE TO +4" ABOVE SUSPENDED CEILING. AT SYSTEMS FURNITURE FEEDS, CONDUIT SHALL BE 1-1/4".
- L. LOW VOLTAGE CABLES (TELEPHONE, DATA, ETC.) INSTALLED IN CEILING SPACE USED FOR RETURN AIR PURPOSES SHALL BE PLENUM RATED CABLES OR INSTALLED IN CONDUIT.
- M. ELECTRIC CONNECTIONS TO PANELBOARDS AND BUS DUCTS SHALL BE MADE ONLY WHEN PANELBOARD OR BUS DUCT HAS BEEN DE-ENERGIZED. SCHEDULE DOWN TIME WITH BUILDING MANAGEMENT/OWNER.
- N. ELECTRICAL WIRING TO SYSTEMS FURNITURE SHALL BE 8-WIRE/4-CIRCUIT "2+2" CONSISTING OF 2-HOTS, 1-NEUTRAL, 1-COMMON GROUND FOR CONVENIENCE PLUS 2-HOT, 1-NEUTRAL, 1-ISOLATED GROUND FOR COMPUTERS.
- O. UNDERLINED CIRCUIT NUMBERS ARE FOR COMPUTER USE AND SHALL EACH HAVE AN INDEPENDENT NEUTRAL AND SHARED ISOLATED GROUND WIRES (MAXIMUM 3 CIRCUITS PER GROUND WIRE, PHASES A/B/C). THE ISOLATED GROUND WIRE SHALL TERMINATE IN AN ISOLATED GROUND BUS IN THE ELECTRIC PANEL. IF THE IG BUS DOES NOT EXIST, CONTRACTOR SHALL PROVIDE NEW BUS WITH ONE (1) #1/0 WIRE IN 3/4" CONDUIT TO GROUNDING SOURCE OF ELECTRIC PANEL.
- P. ALL NEW ELECTRICAL PANELS AND TRANSFORMERS SHALL HAVE PERMANENT ENGRAVED LABELS ON COVER INDICATING PANEL OR TRANSFORMER DESIGNATION.
- Q. CONTRACTOR SHALL RELOCATE ELECTRICAL CONNECTIONS ASSOCIATED WITH ALL RELOCATED MECHANICAL EQUIPMENT. REFER TO HVAC AND PLUMBING PLANS AND COORDINATE FINAL LOCATIONS WITH MECHANICAL CONTRACTOR IN THE FIELD.
- R. ELECTRICAL CONTRACTOR SHALL X-RAY SLAB PRIOR TO ANY CORE-DRILLING. COORDINATE WITH BUILDING MANAGEMENT FOR AFTER-HOURS ACCESS TO SPACE.
- S. WHERE A CIRCUIT IS SHOWN TO ORIGINATE FROM AN EXISTING PANELBOARD, CONTRACTOR SHALL FIELD VERIFY WHETHER THE CIRCUIT BREAKER EXISTS AND, IF NOT, SHALL PROVIDE A NEW BREAKER AS PART OF THE BASE BID.

MECHANICAL EQUIPMENT POWER SCHEDULE									
EQUIPMENT DESIGNATION	LOAD			VOLTAGE/PHASE	CIRCUIT NUMBER	CIRCUIT BREAKER AMPS/POLES	DISCONNECT AMPS/POLES/FUSE	WIRE SIZING	REMARKS
	KW	HP	FLA						
WH4-1	8.31	-	-	277/1	4HA-2	30/1	30A 1PSW	2#10, 1#10G, 3/4" C.	SEE NOTE 1
WH4-2	8.31	-	-	277/1	4HA-3	30/1	30A 1PSW	2#10, 1#10G, 3/4" C.	SEE NOTE 1
EF4-1	-	1/8	-	120/1	4LA-27	20/1	C/B	2#12, 1#12G, 3/4" C.	SEE NOTE 1
EF4-2	250W	-	-	120/1	4LA-29	20/1	C/B	2#12, 1#12G, 3/4" C.	SEE NOTE 1
FCU4-3	-	-	2.73	208/1	4LA-31/33	20/2	BY MECHANICAL	2#12, 1#12G, 3/4" C.	SEE NOTE 1,2,4
FCU4-4	-	-	3.5	208/1	4LA-31/33	-	BY MECHANICAL	2#12, 1#12G, 3/4" C.	SEE NOTE 1,2,4
FCU4-5	-	-	3.5	208/1	4LA-31/33	-	BY MECHANICAL	2#12, 1#12G, 3/4" C.	SEE NOTE 1,2,4
FCU4-6	-	-	3.5	208/1	4LA-31/33	-	BY MECHANICAL	2#12, 1#12G, 3/4" C.	SEE NOTE 1,2,4
FCU4-7	-	-	2.73	208/1	4LA-31/33	-	BY MECHANICAL	2#12, 1#12G, 3/4" C.	SEE NOTE 1,2,4
FCU4-8	-	-	1.2	208/1	4LA-35/37	20/2	BY MECHANICAL	2#12, 1#12G, 3/4" C.	SEE NOTE 1,2,4
FCU4-9	-	-	1.05	208/1	4LA-35/37	-	BY MECHANICAL	2#12, 1#12G, 3/4" C.	SEE NOTE 1,2,4
FCU4-10	-	-	1.05	208/1	4LA-35/37	-	BY MECHANICAL	2#12, 1#12G, 3/4" C.	SEE NOTE 1,2,4
FCU4-11	-	-	3.5	208/1	4LA-35/37	-	BY MECHANICAL	2#12, 1#12G, 3/4" C.	SEE NOTE 1,2,4
FCU4-12	-	-	1.2	208/1	4LA-35/37	-	BY MECHANICAL	2#12, 1#12G, 3/4" C.	SEE NOTE 1,2,4
FCU4-13	-	-	2.73	208/1	4LA-35/37	-	BY MECHANICAL	2#12, 1#12G, 3/4" C.	SEE NOTE 1,2,4

- NOTES:
1. REFER TO HVAC AND PLUMBING PLANS FOR LOCATIONS OF EQUIPMENT. COORDINATE FINAL LOCATIONS IN FIELD.
  2. PROVIDE 120V CIRCUIT TO LEAK DETECTION UNITS AND CONDENSATE PUMPS FROM CIRCUIT 4LA-35.
  3. PROVIDE 120V CIRCUIT TO LEAK DETECTION UNITS AND CONDENSATE PUMPS FROM CIRCUIT 4LA-37.
  4. PROVIDE CONTROLS CIRCUIT INDICATED TO EACH 120V/24V CONTROLS TRANSFORMER (TRANSFORMER BY MECHANICAL). EACH TRANSFORMER SHALL FEED UP TO FIVE (5) CONTROL MODULES. DO NOT EXCEED 1500VA PER 120V CONTROLS CIRCUIT. CABLE BETWEEN THE TRANSFORMERS AND THE CONTROLS SHALL BE BY MECHANICAL.

**DALLAS GREEN BUILDING REQUIREMENTS:**

506.1 MERCURY CONTENT IN FLUORESCENT LAMPS. THE MERCURY CONTENT IN STRAIGHT FLUORESCENT LAMPS SHALL COMPLY WITH SECTION 506.1.1 AND THE MERCURY CONTENT IN COMPACT FLUORESCENT LAMPS SHALL COMPLY WITH SECTION 506.1.2 AS APPLICABLE.  
 EXCEPTION: MERCURY CONTENT IS NOT LIMITED FOR LIGHTING INTEGRAL TO EQUIPMENT OR INSTRUMENTATION AND INSTALLED BY THE MANUFACTURER, OR FOR LAMPS WITH A HIGH COLOR RENDERING INDEX THAT IS GREATER THAN OR EQUAL TO 87.

506.1.1 STRAIGHT FLUORESCENT LAMPS. NON-PREHEAT STRAIGHT, DOUBLE-ENDED FLUORESCENT LAMPS LESS THAN 70 INCHES (1800 MM) AND GREATER THAN 21 INCHES (550 MM) IN LENGTH AND CONTAINING A MEDIUM BI-PIN BASE OR MINIATURE BI-PIN BASE SHALL COMPLY WITH THE FOLLOWING:

1. T-5 LAMPS WITH A RATED LIFETIME OF LESS THAN 25,000 HOURS AT 3 HOURS PER START SHALL CONTAIN NOT MORE THAN AN AVERAGE OF 3 MILLIGRAMS OF MERCURY PER LAMP.
2. T-8 LAMPS WITH A RATED LIFETIME LESS THAN 25,000 HOURS AT 3 HOURS PER START ON AN INSTANT START BALLAST SHALL CONTAIN NOT MORE THAN AN AVERAGE OF 4 MILLIGRAMS OF MERCURY PER LAMP.
3. ALL OTHER T5 OR T8 LAMPS SHALL CONTAIN NOT MORE THAN AN AVERAGE OF 5 MILLIGRAMS OF MERCURY PER LAMP.

506.1.2 COMPACT FLUORESCENT LAMPS. SINGLE-ENDED PIN-BASE AND SCREW-BASE COMPACT FLUORESCENT LAMPS SHALL CONTAIN NOT MORE THAN 5 MILLIGRAMS OF MERCURY PER LAMP, AND SHALL BE LISTED AND LABELED IN ACCORDANCE WITH UL 1993.

**POWER SYMBOLS**

SYMBOL	DESCRIPTION
	WALL MOUNTED DUPLEX RECEPTACLE (NEMA 5-20R)
	WALL MOUNTED QUADRAPLEX RECEPTACLE (NEMA 5-20R)
	WALL MOUNTED DEDICATED DUPLEX RECEPTACLE (NEMA 5-20R)
	WALL MOUNTED DEDICATED QUADRAPLEX RECEPTACLE (NEMA 5-20R)
	WALL MOUNTED COMMUNICATIONS OUTLET
	JUNCTION BOX - CEILING MOUNTED
	JUNCTION BOX - WALL MOUNTED
	FLUSH FLOOR POKE-THRU WITH DUPLEX POWER PLUS COMMUNICATIONS, WIREMOLD #RC3ATCBK ± COM75.
	FLOOR MOUNTED POKE-THRU FOR POWER AND COMMUNICATIONS FEEDS TO SYSTEMS FURNITURE, WIREMOLD #4FFATC
	TV/MONITOR
	CARD READER
(E)	INDICATES EXISTING TO REMAIN
	EXISTING ELECTRICAL PANEL - 208V/120
	EXISTING ELECTRICAL PANEL - 480V/277
	EXISTING TRANSFORMER
	WALL MOUNTED GROUND BUS - SEE PLAN FOR NOTES

**LIGHTING GENERAL NOTES:**

- A. GENERAL CONTRACTOR SHALL NOTIFY THE ARCHITECT IMMEDIATELY IF CONFLICTS OCCUR BETWEEN LIGHTING AND ANY OTHER TRADE. DO NOT PROCEED WITH INSTALLATION IN THAT AREA UNTIL CONFLICT HAS BEEN RESOLVED TO THE SATISFACTION OF THE ARCHITECT AND ENGINEER.
- B. REFER TO ARCHITECTURAL DRAWINGS FOR EXACT LOCATION AND MOUNTING INSTRUCTIONS FOR ALL LIGHT FIXTURES. NOTIFY THE ARCHITECT AND ENGINEER OF ANY DISCREPANCIES BETWEEN THESE PLANS AND THE ARCHITECTURAL PLANS RELATING TO QUANTITY, TYPE AND LOCATION OF DEVICES AND/OR FIXTURES.
- C. WHEN SPECIFIC LIGHT FIXTURE TYPE HAS BEEN SPECIFIED IN THE FIXTURE INFORMATION, ELECTRICAL CONTRACTOR SHALL PROVIDE COMPLETE ASSEMBLY INCLUSIVE OF ALL PARTS AND HARDWARE.
- D. ALL CIRCUITS SHOWN SHALL BE 277V, 20A CIRCUITS UNLESS NOTED OTHERWISE.
- E. ALL 120V RUNS LONGER THAN 60' SHALL BE #10 AWG AND 277V RUNS LONGER THAN 150' SHALL BE #10 AWG UNLESS NOTED OTHERWISE ON PLANS.
- F. MOUNT LIGHT SWITCHES AS INDICATED ON ARCHITECTURAL DRAWINGS (48" AFF UNLESS NOTED OTHERWISE).
- G. ALL GANGED SWITCHES SHALL HAVE A COMMON SEAMLESS FACEPLATE. EACH MULTI-GANG BOX SHALL BE NO MORE THAN SIX (6) SWITCHES WIDE. WHERE MORE THAN SIX (6) SWITCHES ARE SHOWN AT ONE (1) LOCATION, ADDITIONAL MULTI-GANG BOXES SHALL BE STACKED VERTICALLY AND THE WIDTH OF THE MULTI-GANGS SHALL BE AS EVEN AS POSSIBLE.
- H. EACH DIMMER SWITCH SHALL BE COMPATIBLE WITH THE FIXTURES BEING DIMMED (INCANDESCENT, FLUORESCENT, LED, LOW VOLTAGE, ETC). DIMMERS SHALL BE OF THE APPROPRIATE RATING PER THE MANUFACTURER BASED ON TOTAL FIXTURE LOAD AND ANY NECESSARY DERATING WHERE DIMMERS ARE GANGED TOGETHER. WHERE SWITCHES AND DIMMERS ARE SIDE-BY-SIDE, THEY SHALL BE GANGED TOGETHER.
- I. WHERE NEW FLUORESCENT FIXTURES ARE SHOWN TO BE DIMMED, THE FIXTURES SHALL HAVE DIMMING TYPE BALLASTS WHICH ARE COMPATIBLE WITH THE SPECIFIED DIMMERS. WHERE EXISTING FLUORESCENT FIXTURES ARE SHOWN TO BE DIMMED, CONTRACTOR SHALL PROVIDE NEW DIMMING TYPE BALLASTS WHICH ARE COMPATIBLE WITH THE SPECIFIED DIMMERS.
- J. ALL EMERGENCY LIGHT FIXTURES SHALL HAVE 90-MINUTE BATTERY BACK-UP UNLESS NOTED OTHERWISE.
- K. ALL EXIT SIGNS SHALL HAVE 90-MINUTE BATTERY BACK-UP EXCEPT AS OTHERWISE NOTED.
- L. ALL FLUORESCENT FIXTURES THAT UTILIZE DOUBLE-ENDED LAMPS AND CONTAIN BALLASTS SHALL BE PROVIDED WITH A DISCONNECTING MEANS IN ACCORDANCE WITH 2011 NEC 410.130(G).
- M. LIGHTING CONTROL SENSORS AND SWITCHES SHALL BE WIRED DEVICES. NO WIRELESS DEVICES SHALL BE SUBMITTED WITHOUT PRIOR WRITTEN APPROVAL BY OWNER/BUILDING MANAGEMENT.

**FIRE ALARM DEVICES**

A FIRE ALARM CONTRACTOR LICENSED BY THE TEXAS DEPARTMENT OF INSURANCE SHALL MODIFY THE EXISTING FIRE ALARM DEVICE LAYOUT AS REQUIRED FOR THE NEW TENANT LAYOUT. SCOPE OF WORK SHALL BE FOR A COMPLETE TURN-KEY INSTALLATION INCLUDING, BUT NOT LIMITED TO: RELOCATION OF EXISTING DEVICES, REMOVAL OF EXISTING DEVICES, ADDITION OF NEW DEVICES, UTILIZATION OF EXISTING DEVICES IN PLACE AND UPGRADES/ADDITIONS TO PANELS/POWER SUPPLIES TO SUPPORT THE DEVICES. THE FIRE ALARM DESIGN SHALL BE APPROVED BY THE CITY AND STATE FIRE MARSHALS ON SHOP DRAWING CONSTRUCTION SET AND SHALL MEET ALL A.D.A., N.F.P.A., STATE AND LOCAL REQUIREMENTS. SYSTEMS SHALL INCLUDE DETECTION AND NOTIFICATION DEVICE COVERAGE IN ALL SPACES BY UTILIZING BUILDING STANDARD, WHITE CEILING MOUNTED AUDIBLE DEVICES, STROBES, AND COMBINATION AUDIBLE/STROBE DEVICES. PLANS MUST BE SUBMITTED TO THE FIRE DEPARTMENT FOR REVIEW, FINAL APPROVAL AND PERMIT PRIOR TO INSTALLATION, UNDER SEPARATE INSTRUMENT AND COVER. DEVICES SHALL BE WHITE UNLESS REQUIRED TO MATCH EXISTING TO REMAIN.

**AVAILABLE CIRCUITS**

CIRCUITS SHOWN ARE BASED ON BEST KNOWLEDGE OF EXISTING PANEL PLACARDS AND PREVIOUS CONTRACT DOCUMENTS AND DO NOT NECESSARILY INDICATE THE ACTUAL PANEL CIRCUIT NUMBERS FOR USE. IT IS INTENDED TO FIRST REUSE EXISTING LIGHTING CIRCUITS THAT ARE AVAILABLE IN THE SAME PANEL(S) AFTER DEMOLITION OF WALLS AND EQUIPMENT AND THEN USE AVAILABLE SPACES/SPACES FROM THE SAME PANEL(S) AS NEEDED. MAXIMUM OF 16 AMP LOAD PER 20A CIRCUIT. CONTRACTOR SHALL VERIFY ACTUAL CIRCUIT AVAILABILITY AFTER DEMOLITION AND NOTIFY ARCHITECT IMMEDIATELY IF THE QUANTITY OF AVAILABLE CIRCUITS IS INADEQUATE OR OBTAIN APPROVAL FOR ADD ALTERNATE SOLUTION. CONTRACTOR SHALL OBTAIN WRITTEN APPROVAL FROM PURDY-MCGUIRE PRIOR TO USING CIRCUITS FROM A DIFFERENT PANEL.

**LIGHTING SYMBOLS**

SYMBOL	DESCRIPTION
	INDICATES FIXTURE SHALL BE AN EMERGENCY/NIGHT LIGHT
	INDICATES FIXTURE SHALL BE AN EMERGENCY/NIGHT LIGHT
	SINGLE FACE EXIT SIGNS - REFER TO PLAN FOR DIRECTIONAL ARROWS AND WALL OR CEILING MOUNTING
	DOUBLE FACE EXIT SIGNS - REFER TO PLAN FOR DIRECTIONAL ARROWS AND WALL OR CEILING MOUNTING
	SINGLE POLE SWITCH
	DIMMER SWITCH
	CEILING MOUNTED 360-DEGREE DUAL TECHNOLOGY OCCUPANCY SENSOR (AUTOMATIC ON AND OFF). PROVIDE ALL POWER PACKS AND ACCESSORIES AS REQUIRED TO CONTROL ALL LIGHTS IN ROOM. CONTRACTOR SHALL FOLLOW MANUFACTURER'S RECOMMENDED SENSOR SPACING.
	CEILING MOUNTED 360-DEGREE DUAL TECHNOLOGY VACANCY SENSOR (MANUAL ON AND AUTOMATIC OFF). PROVIDE ALL POWER PACKS AND ACCESSORIES AS REQUIRED TO CONTROL ALL LIGHTS IN ROOM. CONTRACTOR SHALL FOLLOW MANUFACTURER'S RECOMMENDED SENSOR SPACING.
	DUAL TECHNOLOGY VACANCY SENSOR SWITCH (MANUAL ON AND AUTOMATIC OFF)
	LOW VOLTAGE SWITCH ASSOCIATED WITH CEILING MOUNTED SENSORS
	CEILING MOUNTED DAYLIGHT SENSOR FOR CONTINUOUS DAYLIGHT RESPONSIVE DIMMING OF LIGHTING IN THE DAYLIGHT ZONE. PROVIDE ALL REQUIRED POWER PACKS, TRANSFORMERS, ACCESSORIES AND LOW VOLTAGE CABLING. REFER TO PLANS FOR THE ZONES THAT SHALL BE CONTROLLED VIA THIS SENSOR

- LEGEND NOTES:
1. CONTRACTOR IS RESPONSIBLE FOR PROVIDING ALL ACCESSORIES FOR PROPER MOUNTING OF FIXTURES IN SPECIFIC CEILING PER LOCATION OF FIXTURES.
  2. CONTRACTOR SHALL PROVIDE SUBMITTALS TO THE ENGINEER OF ALL LIGHTING FIXTURES, (NEW OR SUBSTITUTES).

**LIGHTING FIXTURES**

TYPE	DESCRIPTION	MFR. & CAT. NO.	LAMPS	VOLT	INPUT WATTS	REMARKS
	2x4 TROFFER	COOPER METALUX MTO - 24SR-LD1-48-C-UNV-L830-CD1-U	LED	277	49	
	2x4 TROFFER - EMERGENCY WITH BATTERY PACK	COOPER METALUX MTO - 24SR-LD1-48-C-UNV-L830-CD1-U	LED	277	49	
	2x4 TROFFER	LITHONIA AVANTE #2AVL4-40L-MDR-EZ1-LP835	LED	277	48	
	2x4 TROFFER - EMERGENCY WITH BATTERY PACK	LITHONIA AVANTE #2AVL4-40L-MDR-EZ1-LP835	LED	277	48	
	DOWNLIGHT	LIGHTOLIER #C6L15-35-MZ10U-C6RDL, FINISH: WHITE	LED	277	15	
	DECORATIVE LED PENDANT AT ISLAND	TBD	TBD	277	50	VERIFY FIXTURE SPECIFICATION WITH BLDG. MANAGEMENT
	DIRECT/INDIRECT LINEAR LED PENDANT	FINELITE #HP-2-ID-16-S-S-835-TG-F-96-277-SC, MATTE WHITE	LED	277	7.2WFT	
	LINEAR LED	FOCAL POINT SEEM 4 - FSWML-FL-1000F-35K-1C-UNV-LD1-XFF-WH-LENGTH	LED	UNV	10.5WFT	
	LED LIGHT TAPE	ACOLYTE CH-AC2-F-S2-90-IP20-24-3-25-X-ND-38'	LED	277	5WFT	PROVIDE POWER SUPPLY AS REQUIRED.
	EXIT SIGN	MATCH BUILDING STANDARD	INCLUDED	120/277	5	REFER TO DRAWINGS FOR EXIT SIGN DIRECTIONAL ARROWS AND FOR SINGLE OR DOUBLE FACE QUANTITIES.


- NOTES:
1. CONTRACTOR IS RESPONSIBLE FOR PROVIDING ALL ACCESSORIES FOR PROPER MOUNTING OF FIXTURES IN SPECIFIC CEILING PER LOCATION OF FIXTURES.
  2. CONTRACTOR SHALL PROVIDE SUBMITTALS TO THE ENGINEER OF ALL LIGHTING FIXTURES (NEW OR SUBSTITUTES).

- REVISIONS SUMMARY:
- ADDED DALLAS GREEN NOTES

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 PROJECT MGR. TODD JOHNSON

THIS DRAWING SHALL NOT BE REPRODUCED FOR ANY PROJECT OTHER THAN THE PROJECT NOTED IN THE TITLE BLOCK, WITHOUT THE WRITTEN CONSENT OF PURDY-MCGUIRE, INC. DALLAS, TX

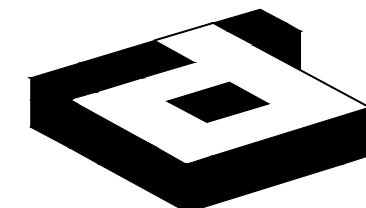

**idGROUP**

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PROJECT NO.: 580-004  
 DRAWN BY: PMI  
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 TENANT R.S.F.: 9.452

**BILLINGSLEY COMPANY**

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NO.	ISSUED FOR:	DATE:
1	REVISION 1	04/17/2020

LANDLORD/CLIENT REVIEW ISSUE DATE: 03/30/20  
 BID ISSUE DATE: 03/30/20  
 CONSTRUCTION ISSUE DATE: 03/30/20

DRAWING TITLE:  
**ELECTRICAL NOTES & SYMBOLS**

DRAWING NUMBER:

**E0.01**

**DIVISION 26 - ELECTRICAL**

**SECTION 260500 - COMMON WORK RESULTS**

**PART 1 - GENERAL**

**1.1 GENERAL NOTES**

- A. DRAWINGS AND GENERAL PROVISIONS OF THE CONTRACT, INCLUDING GENERAL AND SUPPLEMENTARY CONDITIONS, AND ALL OTHER SPECIFICATION SECTIONS, APPLY TO THIS AND THE OTHER SECTIONS OF DIVISION 26.
- B. THE CONTRACTOR FOR THIS DIVISION OF WORK IS REQUIRED TO OBTAIN A COMPLETE SET OF BID DOCUMENTS (DRAWINGS AND SPECIFICATIONS) AND FULLY REVIEW THEM. COORDINATE DIVISION 26 WORK WITH THAT OF ALL OTHER DIVISIONS OF WORK.
- C. THE DRAWINGS AND SPECIFICATIONS ARE INTENDED TO SUPPLEMENT EACH OTHER. ANY LABOR OR MATERIAL CALLED FOR IN ONE SHALL BE FURNISHED AND INSTALLED EVEN THOUGH NOT SPECIFICALLY MENTIONED IN BOTH. ANY LABOR OR MATERIAL WHICH IS NEITHER SHOWN ON THE DRAWINGS OR CALLED FOR IN THE SPECIFICATIONS, BUT WHICH IS OBVIOUSLY REQUIRED TO COMPLETE THE WORK, AND WHICH IS NORMALLY INCLUDED IN WORK OF SIMILAR CHARACTER, SHALL BE FURNISHED AND INSTALLED AS PART OF THIS CONTRACT.
- D. THE CONTRACTOR IS RESPONSIBLE FOR SCHEDULING THE COMPLETION AND INSPECTION OF THIS WORK TO COMPLY WITH THE OWNER'S SCHEDULE AND PROJECT COMPLETION DATE.

**1.2 SCOPE OF WORK**

- A. THE DESCRIPTION OF GENERAL CONDITION WORK IN THIS DIVISION SHALL ALSO APPLY TO DIVISION 28.
- B. THIS CONTRACTOR SHALL PROVIDE ALL LABOR, MATERIALS, EQUIPMENT, TOOLS, TRANSPORTATION, INCIDENTALS AND DETAILS NECESSARY TO PROVIDE A COMPLETE ELECTRICAL AND FIRE ALARM SYSTEM AS SHOWN ON THE DRAWINGS, CALLED FOR IN THE SPECIFICATIONS AND AS REQUIRED BY JOB CONDITIONS. WORK IS TO BE COMPLETE IN EVERY RESPECT, WHETHER SPECIFICALLY MENTIONED IN THE CONTRACT DOCUMENTS OR NOT.
- C. ALL WORK NOT SPECIFICALLY NOTED AS BEING BY THE OWNER (BUILDING OWNER, LANDLORD OR TENANT), SHALL BE PROVIDED BY THIS CONTRACTOR.
- D. THIS WORK, MATERIALS AND EQUIPMENT INCLUDES, BUT IS NOT LIMITED TO THE FOLLOWING ITEMS:
  - a. A COMPLETE ELECTRICAL DISTRIBUTION SYSTEM INCLUDING THE INSTALLATION OF ELECTRICAL PANELBOARDS, TRANSFORMERS, SAFETY AND DISCONNECT SWITCHES, MOTOR STARTERS, VFD'S AND LIGHTING. IT IS THE ELECTRICAL CONTRACTOR'S RESPONSIBILITY TO INCLUDE IN HIS BID FOR PROVIDING SERVICE EQUIPMENT NECESSARY FOR TIE-IN TO OWNER'S DISTRIBUTION EQUIPMENT. REFER TO ELECTRICAL RISER DIAGRAM FOR ADDITIONAL INFORMATION.
  - b. CONTRACTOR MUST ALSO INCLUDE IN BID ALL NECESSARY MATERIALS REQUIRED TO COMPLETE THE SYSTEM INCLUDING, BUT NOT LIMITED TO, FEEDERS, BRANCH CIRCUITS, JUNCTION BOXES, OUTLET BOXES, WIRING DEVICES, COVER PLATES, CONDUITS, ETC.
  - c. METERING REQUIRED PER DRAWING AND/OR OWNER.
  - d. THE WIRING OF MECHANICAL EQUIPMENT SHALL BE AS OUTLINED ON THE BID SET DRAWINGS AND IN THE SPECIFICATIONS. WORK SHALL INCLUDE WIRING OF ALL STARTERS, DISCONNECTS, VFD'S, AND POWER WIRING OF MECHANICAL EQUIPMENT EXCEPT AS SPECIFICALLY NOTED OTHERWISE. ALL LOW VOLTAGE (24 VOLT) EMS TEMPERATURE CONTROL WIRING SHALL BE THE RESPONSIBILITY OF THE MECHANICAL CONTRACTOR UNLESS NOTED SPECIFICALLY ON DRAWING.
  - e. INSTALLATION OF LIGHT FIXTURES AND LAMPS AS SHOWN ON THE DRAWINGS INCLUDING ALL DEVICES, EQUIPMENT, ETC. REQUIRED FOR MOUNTING.
  - f. A COMPLETE CONDUIT SYSTEM FOR TELEPHONE/DATA INCLUDING BRANCH CONDUITS, OUTLET BOXES, PULL WIRES, GROUND CONDUCTORS, COVER PLATES, ETC. OR AS SPECIFICALLY NOTED OTHERWISE ON THE DRAWINGS.
  - g. A COMPLETE EMERGENCY AND EXIT LIGHTING SYSTEM AS SHOWN ON THE DRAWINGS.
  - h. TEMPORARY SERVICE AS REQUIRED FOR CONSTRUCTION, INCLUDING ITS REMOVAL.
  - i. SMOKE/FIRE ALARM WIRING, DEVICES AND CONDUIT, AS DESCRIBED ON DRAWINGS OR AS NECESSARY TO MEET OWNER, STATE, LOCAL, INSURANCE AND FIRE DEPARTMENT REQUIREMENTS.
  - j. INSTALLATION OF CONDUITS STUBBED TO ABOVE CEILING FOR HVAC CONTROLS AND FUTURE LOADS.

**E. WORK NOT INCLUDED - THE FOLLOWING ITEMS OF ELECTRICAL CONSTRUCTION ARE NOT INCLUDED IN THIS CONTRACT:**

- a. TELEPHONE INSTRUMENTS AND WIRING UNLESS NOTED OTHERWISE.
- b. DATA CABLE WIRING UNLESS NOTED OTHERWISE.

**1.3 CODES**

- A. ALL WORK SHALL CONFORM TO THE OWNER'S CRITERIA, STATE, COUNTY, CITY AND LOCAL CODES AND ORDINANCES, SAFETY AND HEALTH CODES, NFPA CODES, ENERGY CODES AND ALL OTHER APPLICABLE CODES AND REQUIREMENTS. THIS CONTRACTOR SHALL INQUIRE INTO AND COMPLY WITH ALL APPLICABLE CODES, ORDINANCES AND REGULATIONS. THIS CONTRACTOR SHALL INCLUDE ANY CHANGES REQUIRED BY CODES IN THE BID AND IF THESE CHANGES ARE NOT INCLUDED IN THE BID, THEY MUST BE QUALIFIED AS A SEPARATE LINE ITEM IN THE BID. AFTER CONTRACT IS AWARDED, CHANGE ORDERS FOR INCREASED COSTS DUE TO CODE ISSUES WILL NOT BE ACCEPTED UNLESS ALLOWANCES HAVE BEEN PREVIOUSLY AGREED UPON.
- B. WHERE THE DRAWINGS AND SPECIFICATIONS CALL FOR ITEMS WHICH EXCEED CODE OR THE OWNER'S CRITERIA, THE CONTRACTOR IS RESPONSIBLE FOR FURNISHING AND INSTALLING THE SYSTEM WITH THE MORE STRINGENT REQUIREMENTS.

**1.4 LICENSES, PERMITS, INSPECTION AND FEES**

- A. THIS CONTRACTOR SHALL OBTAIN AND PAY FOR ALL LICENSES, PERMITS, INSPECTIONS AND FEES REQUIRED OR RELATED TO THIS WORK. ALL COSTS ASSOCIATED WITH THESE SHALL BE PAID FOR BY THE CONTRACTOR AND INCLUDED AS PART OF THE BID.
  - B. FURNISH TO THE OWNER ALL CERTIFICATES OF INSPECTION AND FINAL INSPECTION APPROVAL AT THE COMPLETION OF THE PROJECT.
- 1.5 GUARANTEE**
- A. ALL MATERIALS, EQUIPMENT AND WORKMANSHIP SHALL BE GUARANTEED FOR PERIOD OF 1 YEAR FROM THE DATE OF ACCEPTANCE (OFFICIAL DATE IN WRITING) OF THE PROJECT. ALL WORK FOUND TO BE DEFECTIVE SHALL BE REPAIRED OR REPLACED BY THE CONTRACTOR AT NO COST TO THE OWNER.
  - B. WHERE SPECIFIC EQUIPMENT IS NOTED TO HAVE EXTENDED WARRANTIES, THE CONTRACTOR SHALL BE RESPONSIBLE FOR THE PROPER REGISTRATION SO THE OWNER CAN MAKE ALL APPROPRIATE CLAIMS.

**1.6 RECORD DRAWINGS**

- A. THIS CONTRACTOR SHALL MAINTAIN ONE SET OF DRAWINGS ON THE JOBSITE, UPDATED WEEKLY, TO RECORD ALL DEVIATIONS FROM THE CONTRACT DOCUMENTS SUCH AS:
  - a. LOCATIONS OF CONCEALED CONDUITS
  - b. PANEL DESCRIPTIONS, CIRCUIT DIRECTORIES AND LABELS
  - c. REVISIONS, ADDENDUMS AND CHANGE ORDERS
  - d. SIGNIFICANT DEVIATIONS MADE NECESSARY BY FIELD CONDITIONS, APPROVED EQUIPMENT SUBSTITUTIONS, AND CONTRACTOR'S COORDINATION WITH OTHER TRADES.
- B. DELIVER RECORD DRAWINGS TO THE OWNER AT PROJECT COMPLETION.

**1.7 DEMOLITION**

- A. THIS CONTRACTOR SHALL BE RESPONSIBLE FOR THE COORDINATION OF THE DEMOLITION OF EXISTING WORK AND THE DEMOLITION PROVIDED BY THE GENERAL CONTRACTOR. COORDINATE WITH THE GENERAL CONTRACTOR ALL EXISTING EQUIPMENT REQUIRED TO BE LEFT INTACT.
- B. THIS CONTRACTOR SHALL INCLUDE, AND WILL BE RESPONSIBLE FOR, THE REMOVAL OF ALL EXISTING CONDUIT, FIRE ALARM SYSTEM, SWITCH GEAR, AND EQUIPMENT, ETC. UNLESS SPECIFICALLY NOTED OTHERWISE. CONTRACTOR MUST VERIFY WITH THE OWNER ALL PRESUMED ABANDONED EQUIPMENT, CONDUIT AND SWITCH GEAR PRIOR TO REMOVAL. EXISTING ABANDONED CONDUIT OR EQUIPMENT IN THE FLOOR, EMBEDDED IN CONCRETE, OR OTHERWISE INACCESSIBLE, ARE TO BE CUT OFF AND SEALED BELOW OR WITHIN FLOOR OR WALL LEVEL. WHEN THEY ARE NOT TO BE REUSED IN THIS PROJECT, IF REQUIRED BY OWNER OR CODES, ABANDONED CONDUIT MUST BE REMOVED TO POINT OF ORIGIN. CONFIRM EXTENT OF DEMOLITION PRIOR TO BID AND INCLUDE PROPOSAL.

**1.8 TEMPORARY LIGHT AND POWER**

- A. THIS CONTRACTOR SHALL FURNISH AND INSTALL ALL TEMPORARY WIRING AND RELATED GROUND FAULT INTERRUPTION PROTECTION FOR LIGHT AND POWER FOR ALL CONTRACTORS DURING CONSTRUCTION AND IS RESPONSIBLE FOR ITS REMOVAL.

**PART 2 - PRODUCTS**

**2.1 MATERIALS**

- A. MATERIALS UTILIZED IN THE CONSTRUCTION OF THIS PROJECT SHALL BE NEW AND CARRY ALL UL LABELS WHERE APPLICABLE, UNLESS APPROVED BY THE OWNER.
  - B. ANY USED EQUIPMENT OR MATERIALS USED SHALL STILL CARRY THE SPECIFIED 1 YEAR GUARANTEE AND APPROVAL OF THE USE OF THIS EQUIPMENT OR MATERIALS DOES NOT RELIEVE THE CONTRACTOR FROM ENSURING EVERYTHING IS OPERATIONAL.
- 2.2 MANUFACTURERS**
- A. WHERE TRADE NAMES OR MANUFACTURERS ARE USED ON THE DRAWINGS OR IN THE SPECIFICATIONS, THE EXACT EQUIPMENT SHALL BE CONSIDERED THE BASIS OF DESIGN AND USED AS A MINIMUM FOR THE BASE BID. MANUFACTURERS CONSIDERED AS AN EQUAL OR BETTER IN ALL ASPECTS TO THAT SPECIFIED, WILL BE SUBJECT TO APPROVAL IN WRITING BY THE ENGINEER THROUGH THE SHOP DRAWING SUBMITTAL PROCESS. FOR ACCEPTANCE PRIOR TO INSTALLATION, THE USE OF ANY UNAUTHORIZED EQUIPMENT SHALL BE REPLACED AT THE CONTRACTOR'S EXPENSE.

**2.3 SLEEVES**

- A. PROVIDE SLEEVES TO PROTECT EQUIPMENT OR FACILITIES IN THE INSTALLATION. EACH SLEEVE SHALL EXTEND THROUGH ITS RESPECTIVE FLOOR, WALL OR PARTITION AND SHALL BE CUT FLUSH WITH EACH SURFACE EXCEPT SLEEVES THAT PENETRATE THE FLOOR, WHICH SHALL EXTEND 2 INCHES ABOVE THE FLOOR.
- B. CONTRACTOR SHALL COORDINATE THROUGH THE GENERAL CONTRACTOR AND OWNER ANY CORE DRILLING OR CUTTING OF OPENINGS IN MASONRY WALLS OR CONCRETE FLOORS.
- C. ALL SLEEVES AND OPENINGS THROUGH FIRE RATED WALLS AND FLOORS SHALL BE FIRE SEALED. REFER TO "FIRE STOPPING".
- D. SLEEVES IN BEARING AND MASONRY WALLS, FLOORS AND PARTITIONS SHALL BE STANDARD WEIGHT STEEL PIPE FINISHED WITH SMOOTH EDGES. FOR OTHER THAN MASONRY PARTITIONS, THROUGH SUSPENDED CEILINGS OR FOR CONCEALED VERTICAL PIPING, SLEEVES SHALL BE MINIMUM NO. 22 USG GALVANIZED STEEL.

**2.4 FLAME SPREAD PROPERTIES OF MATERIALS**

- A. MATERIALS USED ON THIS PROJECT SHALL EACH HAVE A FLAME SPREAD RATING OF 25 OR LESS, AND A SMOKE DEVELOPED RATING OF 50 OR LESS, AS DETERMINED BY AN INDEPENDENT TESTING LABORATORY IN ACCORDANCE WITH NFPA-255.

**2.5 FIRE STOPPING**

- A. PROVIDE FIRE STOPPING IN SEALING OF PENETRATIONS IN FIRE-RATED CONSTRUCTION, HORIZONTAL AND VERTICAL, INCLUDING THE FOLLOWING MATERIALS:
    - a. FOAM: DOW CORNING FIRESTOP SILICONE RTV FOAM, CAT #2001 LIQUID COMPONENT PART A (BLACK) AND LIQUID COMPONENT PART B (OFF-WHITE).
    - b. SEALANT: 3M 1000 NS AND 1003 SI SILICONE ADHESIVE SEALANT.
    - c. DAMMING MATERIALS: MINERAL FIBERBOARD, AS SELECTED BY THE APPLICATOR.
  - B. MIXES SHALL CONFORM TO THE MANUFACTURER'S DIRECTIONS.
- 2.6 FLOOR, CEILING AND WALL PLATES**
- A. PROVIDE CHROME-PLATED, ONE-PIECE, ESCUTCHEONS ON CONDUITS AND HANGER RODS PENETRATING THE WALLS, FLOORS, AND CEILINGS IN FINISHED AREAS OF THE BUILDING. SPLIT RING ESCUTCHEONS ARE NOT ACCEPTABLE.

**2.7 EQUIPMENT FOUNDATIONS AND SUPPORTS**

- A. PROVIDE FOUNDATIONS AND SUPPORTS FOR ELECTRICAL EQUIPMENT AS REQUIRED. THESE SHALL INCLUDE REINFORCED CONCRETE HOUSEKEEPING PADS FOR ANY DISTRIBUTION EQUIPMENT INSTALLED INDOORS ON THE FLOOR. PADS SHALL EXTEND A MINIMUM OF 3 INCHES BEYOND EQUIPMENT IN ALL DIRECTIONS.

**PART 3 - EXECUTION**

- 3.1 SPACE AND EQUIPMENT ARRANGEMENT**
- A. EACH CONTRACTOR SHALL BE RESPONSIBLE TO SEE THAT THEIR PURCHASED EQUIPMENT WILL FIT THE SPACES AVAILABLE. IN CERTAIN INSTANCES HE WILL NOTE THAT THE EQUIPMENT IS MENTIONED BY NAME IN THE EQUIPMENT SCHEDULES. IN THESE CASES IT IS THAT EQUIPMENT WHOSE DIMENSIONS AND CONNECTION ARRANGEMENTS HAVE BEEN USED FOR THE PREPARATION OF THE LAYOUTS SHOWN ON THE WORKING DRAWINGS. SHOULD THE USE OF EQUIPMENT BY OTHER APPROVED MANUFACTURERS OR OF OTHER PHYSICAL SHAPE THAN THOSE SHOWN ON THE DRAWINGS BE PROPOSED, THE CONTRACTOR SHALL CONFIRM THE EQUIPMENT WILL FIT WITHIN THE ALLOTTED SPACE WITHOUT ARCHITECTURAL MODIFICATIONS OR IMPACT ON OTHER TRADES.
  - B. ALL WORK SHALL BE INSTALLED SO AS TO BE READILY ACCESSIBLE FOR OPERATING, SERVICING, MAINTAINING, AND REPAIRING. PROVIDE SUFFICIENT SERVICE ACCESS TO ALL EQUIPMENT.
  - C. BEFORE STARTING WORK, THIS CONTRACTOR SHALL EXAMINE THE ARCHITECTURAL, STRUCTURAL, FIRE PROTECTION, MECHANICAL, AND PLUMBING PLANS, SHOP DRAWINGS, AND SPECIFICATIONS TO SEQUENCE, COORDINATE, AND INTEGRATE THE VARIOUS ELEMENTS OF THE ELECTRICAL SYSTEM TO AVOID INTERFERENCES AND CONFLICTS.
- 3.2 MANUFACTURER'S DIRECTIONS**
- A. THE MANUFACTURER'S PUBLISHED DIRECTIONS SHALL BE FOLLOWED IN THE DELIVERY, STORAGE, PROTECTION, INSTALLATION, AND WIRING OF ALL EQUIPMENT AND MATERIAL. THE CONTRACTOR SHALL PROMPTLY NOTIFY THE OWNER IN WRITING OF ANY CONFLICT BETWEEN THE REQUIREMENTS OF THE CONTRACT DOCUMENTS AND THE MANUFACTURER'S DIRECTIONS, AND SHALL OBTAIN INSTRUCTIONS BEFORE PROCEEDING WITH THE WORK. SHOULD THE CONTRACTOR PERFORM ANY WORK BEFORE RECEIVING SUCH INSTRUCTIONS, HE SHALL BEAR ALL COSTS ARISING IN CONNECTIONS WITH THE DEFICIENCIES.

**3.3 CONSTRUCTION REQUIREMENTS**

- A. THE DRAWINGS AND SPECIFICATIONS SHOW EQUIPMENT CONNECTIONS, CONDUIT, AND WIRE SIZE, GENERAL ROUTING AND LOCATION, AND DESCRIBE THE VARIOUS SYSTEMS. THESE DOCUMENTS DESCRIBE AND SIZE EQUIPMENT, ITS GENERAL LOCATION, USAGE, SUPPORT, AND AUXILIARY REQUIREMENTS. THEY DESCRIBE MOST, BUT NOT ALL OF THE MATERIALS AND THEIR USAGE FOR THIS PROJECT.
- B. CONTRACT DOCUMENTS DO NOT DETAIL ALL JOB REQUIREMENTS. THEY DO NOT SHOW LAYOUTS, LOCATIONS, OR ELEVATIONS OF CONDUITS, HANGERS, SLEEVES, HANGERS, JUNCTION BOXES, OR ACCESS DOORS. THEY DO NOT SHOW FINAL PRECISE LOCATIONS OF EQUIPMENT BY DIMENSIONS IN ALL INSTANCES.
- C. THE EXACT LOCATION OF EACH ITEM SHALL BE DETERMINED BY REFERENCE TO THE PROJECT CONTRACT DRAWINGS, AND TO DETAILS, EQUIPMENT DRAWINGS, AND ROUGH-IN DRAWINGS, BY MEASUREMENTS AT THE BUILDING, AND IN COOPERATION WITH THE VARIOUS TRADES. MINOR RELOCATION NECESSITATED BY THE CONDITIONS AT THE SITE OR DIRECTED BY THE OWNER SHALL BE MADE WITHOUT ADDITIONAL COST TO THE OWNER, WHERE CONFLICTS OCCUR. WORK IN THE AREA INVOLVED.

**3.4 EQUIPMENT FOUNDATIONS, HANGERS AND SUPPORTS**

- A. FOR FLOOR MOUNTED ELECTRICAL EQUIPMENT, PROVIDE CONCRETE HOUSEKEEPING PADS NOT LESS THAN 3-1/2 INCHES THICK REINFORCED WITH NO. 3 DOWELS AND NO. 3 BARS, 2 FEET-0 INCHES ON CENTER EACH WAY.
- B. SUSPENDED EQUIPMENT SHALL HAVE SUPPORTS CONSISTING OF MANUFACTURED METAL FRAMING OR HANGERS CONFORMING TO SECTION 260529.

**3.5 INSTRUCTIONS TO OWNER'S PERSONNEL**

- A. PROVIDE THE SERVICES OF COMPETENT ENGINEERS OR TECHNICIANS TO INSTRUCT REPRESENTATIVES OF THE OWNER IN COMPLETE AND DETAILED OPERATION AND MAINTENANCE OF EACH ITEM OF EQUIPMENT AND EACH SYSTEM.
- B. THE CONTRACTOR SHALL BE FULLY RESPONSIBLE FOR PROPER MAINTENANCE OF EQUIPMENT AND SYSTEMS UNTIL THE INSTRUCTIONS HAVE BEEN GIVEN TO THE OWNER'S PERSONNEL AND THE LETTER OF RELEASE ACKNOWLEDGED.
- C. PROVIDE OPERATION & MAINTENANCE MANUALS (3 COPIES), ALONG WITH AS-BUILT SET OF PRINTS PRIOR TO SUBSTANTIAL COMPLETION OF THE PROJECT.

**3.6 ELECTRICAL WIRING OF MOTORS**

- A. THE ELECTRICAL CONTRACTOR SHALL FURNISH ALL DISCONNECT SWITCHES AND MOTOR CONTROLS AS REQUIRED FOR THE PROPER OPERATION OF THE EQUIPMENT, UNLESS SUCH EQUIPMENT IS SPECIFIED TO BE PROVIDED WITH FACTORY MOUNTED DISCONNECT SWITCHES, STARTERS, OR VFD'S. THE ELECTRICAL CONTRACTOR SHALL MAKE FINAL CONNECTIONS TO EQUIPMENT AS REQUIRED FOR A COMPLETE AND OPERATING SYSTEM.
- B. THE MECHANICAL AND PLUMBING DESIGN AND DRAWINGS ARE BASED ON THE EQUIPMENT SCHEDULED AND SHOWN ON THE DRAWINGS. SHOULD ANY CONTRACTOR SUBMIT FOR APPROVAL EQUIPMENT REQUIRING CHANGES TO THE MECHANICAL AND PLUMBING DESIGN FOR WHICH THE MECHANICAL OR PLUMBING CONTRACTOR WILL REQUEST AN EXTRA, THIS EXTRA SHALL BE PAID BY THE CONTRACTOR PROVIDING THE ALTERNATE EQUIPMENT REQUIRING THE CHANGE.
- C. ELECTRICAL CONTRACTOR SHALL REFER TO MECHANICAL DRAWINGS FOR ADDITIONAL ELECTRICAL WORK TO BE INCLUDED IN HIS BID.
- D. ELECTRICAL CONTRACTOR SHALL DO ALL POWER WIRING, LINE VOLTAGE WIRING, AND LINE VOLTAGE CONTROL WIRING INDICATED UNDER THE HEATING, VENTILATION AND AIR CONDITIONING, PLUMBING, AND FIRE PROTECTION SPECIFICATIONS AND DRAWINGS. THIS CONTRACTOR SHALL ALSO DO ALL INTERCONNECTING LINE VOLTAGE WIRING BETWEEN RELAYS AND SWITCHES AS REQUIRED.
- E. ELECTRICAL CONTRACTOR IS RESPONSIBLE FOR FURNISHING AND INSTALLING CONDUIT FOR HVAC CONTROL WIRING WHERE REQUIRED BY CODE OR SHOWN ON PRINTS TO BE IN CONDUIT. REFER TO PLANS FOR REQUIREMENTS AND SIZES.
- F. FIRE DAMPERS SHALL BE WIRED BY ELECTRICAL CONTRACTOR. COORDINATE WITH MECHANICAL CONTRACTOR FOR POWER REQUIREMENTS.

**3.7 QUIET OPERATION**

- A. THIS WORK SHALL BE INSTALLED IN SUCH A MANNER THAT UNDER ALL CONDITIONS OF LOAD IT SHALL OPERATE WITHOUT SOUND OR VIBRATION, WHICH IS OBJECTIONABLE IN THE OCCUPIED SPACES IN THE OPINION OF THE OWNER. IN THE CASE OF MOVING MACHINERY, SOUND OR VIBRATION ANNOYINGLY NOTICEABLE INSIDE ITS OWN ROOM CAN BE CONSIDERED AS OBJECTIONABLE. IN ANY CASE, THE SITUATION SHALL BE REMEDIED AT NO COST TO THE OWNER.

**3.8 CUTTING AND PATCHING**

- A. PROVIDE ALL CUTTING, CHASING AND CHANNELING REQUIRED FOR ANY WORK UNDER THIS DIVISION. CUTTING SHALL HAVE PRIOR APPROVAL FROM ARCHITECT AND OWNER.
- B. ALL PATCHING SHALL BE BY THE GENERAL CONTRACTOR AND SHALL MATCH THE SURROUNDING SURFACES.

**3.9 TESTS**

- A. THE CONTRACTOR INSTALLING THE ELECTRICAL SYSTEMS SHALL FOLLOW ALL TESTS AS REQUIRED TO PROVE COMPLIANCE WITH ALL LOCAL CODES.

**END OF SECTION.**

**SECTION 260519 - CONDUCTORS**

**PART 1 - GENERAL**

**1.1 SCOPE OF WORK**

- A. REFER TO SECTION 260500.

**PART 2 - PRODUCTS**

**2.1 SINGLE CONDUCTORS**

- A. CONDUCTORS FOR FEEDERS AND BRANCH CIRCUITS SHALL BE COPPER AND THE AWG SIZE AND TYPE AS SHOWN ON DRAWINGS. MINIMUM WIRE SIZE #12 UNLESS NOTED OTHERWISE ON PLAN OR IN GENERAL NOTES FOR VOLTAGE DROP. THE CONDUCTORS SHALL BE 600 VOLT INSULATION, TYPE THW, THWN OR THHN
  - B. CONDUCTORS MAY BE STRANDED FOR SIZES #10 AWG AND LARGER. CONDUCTOR SIZE #12 SHALL BE SOLID (NOT STRANDED).
  - C. ALUMINUM CONDUCTORS ARE NOT PERMITTED. CONTRACTOR MUST OBTAIN WRITTEN PERMISSION FROM GENERAL CONTRACTOR AND ENGINEER WHEN USED.
- 2.2 MULTICONDUCTOR CABLES**
- A. PROVIDE TYPE MC MULTICONDUCTOR CABLE IN COMPLIANCE WITH NEMA WC 70, WITH METAL CLAD AND GROUND WIRE.

**2.3 CONNECTORS**

- A. WIRE CONNECTORS SHALL BE EQUAL TO "SCOTCH LOCK" FOR #8 AWG WIRE AND SMALLER. USE "TAB" "LOCKTIGHT" FOR #6 AWG WIRE AND LARGER.

**PART 3 - EXECUTION**

**3.1 APPLICATIONS AND INSTALLATION**

- A. ALL WIRING SHALL BE IN CONDUIT UNLESS NOTED OTHERWISE (IE-LOW VOLTAGE PLENUM RATED WIRE).
- B. THE USE OF SHARED NEUTRALS IS REQUIRED FOR LIGHTING CIRCUITS AND ALLOWED PER DRAWING NOTES. IT

SHALL BE INSTALLED IN ACCORDANCE WITH THE NATIONAL ELECTRIC CODE AND LOCAL CODES.

C. THE USE OF ROMEX, BX, ETC. IS NOT PERMITTED.

D. ALL WIRING TO BE COLOR-CODED AS FOLLOWS:

- 120/208 VOLT SYSTEM
  - NEUTRAL - WHITE
  - PHASE A OR L1 - BLACK
  - PHASE B OR L2 - RED
  - PHASE C OR L3 - BLUE
  - GROUND - GREEN
  - ISOLATED GROUND - GREEN WITH YELLOW TRACER

- 277/480 VOLT SYSTEM
  - NEUTRAL - GRAY
  - PHASE A OR L1 - BROWN
  - PHASE B OR L2 - ORANGE
  - PHASE C OR L3 - YELLOW
  - GROUND - GREEN WITH YELLOW TRACER
  - ISOLATED GROUND - GREEN WITH YELLOW TRACER

E. UNLESS NOTED OTHERWISE, MC CABLE IS ONLY ALLOWED WITHIN PARTITIONS OR MILL WORK AND LOCATIONS DESCRIBED IN SECTION 260533.

**END OF SECTION.**

**SECTION 260526 - GROUNDING**

**PART 1 - GENERAL**

**1.1 SCOPE OF WORK**

- A. REFER TO SECTION 260500.

**PART 2 - PRODUCTS**

**2.1 CONDUCTORS AND JUMPERS**

- A. ALL CONDUIT, INCLUDING FLEXIBLE CONDUIT, SHALL BE GROUNDED WITH A GREEN COPPER GROUNDING CONDUCTOR.
- B. GROUNDING CONNECTIONS MADE TO THE WATER PIPING SYSTEM SHALL BE COORDINATED WITH THE PLUMBING CONTRACTOR AND A BONDING JUMPERS INSTALLED AROUND WATER METER PER CODES AND AS INDICATED ON DRAWING.

- C. ALL DEVICES SHALL BE BONDED TO THE CONDUIT SYSTEM. USE A BONDING JUMPER BETWEEN THE OUTLET BOX AND THE DEVICE GROUNDING TERMINAL. METAL-TO-METAL CONTACT BETWEEN THE DEVICE YOKE AND THE OUTLET BOX IS NOT ACCEPTABLE AS A BOND FOR EITHER SURFACE MOUNTED BOXES OR FLUSH TYPE BOXES. ALL JUNCTION BOXES, OUTLET BOXES, AND PULL BOXES SHALL BE BONDED TO THE CONDUIT SYSTEM.

**PART 3 - EXECUTION**

**3.1 INSTALLATION**

- A. RUN A SEPARATE ISOLATED GROUNDING CONDUCTOR, #12 AWG MINIMUM, IN EACH CONDUIT FEEDING ISOLATED GROUND RECEPTACLES AND OTHER COMPUTERIZED EQUIPMENT AS SHOWN ON DRAWINGS.
- B. ALL ENCLOSURES AND NON-CURRENT CARRYING METAL PARTS ARE TO BE GROUNDED. CONDUIT SYSTEM IS TO BE ELECTRICALLY CONTINUOUS. ALL LOCKNUTS MUST CUT THROUGH ENAMELED OR PAINTED SURFACES ON CONDUIT SYSTEM. USE BONDING JUMPERS WITH APPROVED CLAMPS. ALL GROUND CLAMPS SHALL BE "PENN-UNION" OR EQUAL, SIMILAR TO "GPL" TYPE.

**END OF SECTION.**

**SECTION 260529 - HANGERS AND SUPPORTS**

**PART 1 - GENERAL**

**1.1 SCOPE OF WORK**

- A. REFER TO SECTION 260500.

**PART 2 - PRODUCTS**

**2.1 STEEL SLOTTED SUPPORTS**

- A. HOT-DIP GALVANIZED AFTER FABRICATION OF DIMENSIONS REQUIRED FOR THE SIZE OF SUPPORTED ITEMS AND ANTICIPATED LOAD.
- B. RACEWAY AND CABLE SUPPORTS AS DESCRIBED IN NECA 1 AND 101.
- C. USE STEEL HANGERS, CLAMPS AND ASSOCIATED FITTINGS, DESIGNED FOR TYPES AND SIZES OF RACEWAYS TO BE SUPPORTED.

**PART 3 - EXECUTION**

**3.1 INSTALLATION**

- A. HANGERS SHALL INCLUDE ALL MISCELLANEOUS STEEL SUCH AS ANGLE IRON, BANDS, C-CLAMPS WITH RETAINING CLIPS, CHANNELS, HANGER RODS, ETC., NECESSARY FOR THE INSTALLATION OF WORK.
- B. HANGERS SHALL BE FASTENED TO BUILDING STEEL, CONCRETE, OR MASONRY, BUT NOT TO PIPING, HANGING FROM METAL DECK IS NOT PERMITTED. HANGERS MUST BE ATTACHED TO UPPER CHORD OF BAR JOIST. WHERE INTERFERENCES OCCUR, AND IN ORDER TO SUPPORT CONDUIT, THE CONTRACTOR MUST INSTALL TRAPEZIE TYPE HANGERS OR SUPPORTS WHICH SHALL BE LOCATED WHERE THEY DO NOT INTERFERE WITH ACCESS TO OTHER SYSTEMS AND EQUIPMENT. HANGER TYPES AND INSTALLATION METHODS ARE ALSO SUBJECT TO OWNER CRITERIA.
- C. HANGERS AND PIPING OF DISSIMILAR METALS SHALL BE DI-ELECTRICALLY SEPARATED.

**END OF SECTION.**


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SPECIFICATIONS 1 OF 2**

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SECTION 260533 - RACEWAYS AND BOXES

PART 1 - GENERAL

1.1 SCOPE OF WORK

- A. REFER TO SECTION 260500.
B. THIS CONTRACTOR SHALL FURNISH AND INSTALL ALL CONDUITS SERVING ALL EQUIPMENT, INCLUDING BUT NOT LIMITED TO LIGHTING, RECEPTACLES, HEATING, AIR CONDITIONING, PLUMBING EQUIPMENT, TELEPHONE, DATA, AUDIO/VISUAL, SECURITY, AND ELECTRICAL EQUIPMENT.

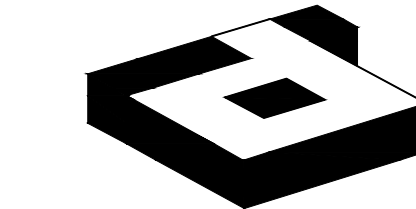PART 2 - PRODUCTS

2.1 RACEWAYS

- A. ALL CONDUITS SHALL BE GALVANIZED IMC, EMT OR MC TYPE UNLESS OTHERWISE SPECIFIED IN SPECIFICATIONS OR ON DRAWINGS. ALL CONDUIT IS TO BE UL LABELED.
a. EMT CONNECTORS SHALL BE STEEL COMPRESSION TYPE.
b. CONDUIT UNDER SLAB ON GRADE SHALL BE RIGID STEEL, OR SCHEDULE 40 PVC WITH RIGID STEEL ELLS WHERE PERMITTED BY OWNER OR CODE.
B. MINIMUM SIZE OF CONDUIT SHALL BE:
a. 3/4 INCH FOR INDIVIDUAL LIGHTING FIXTURE CONNECTIONS OR TO INDIVIDUAL LIGHT SWITCHES AND 3/4 INCH FOR ALL OTHER LIGHTING AND POWER CIRCUITING.
b. IF HVAC CONTROL WIRING IS REQUIRED TO BE RUN IN CONDUIT, IT SHALL BE A MINIMUM OF 3/4 INCH, UNLESS NOTED OTHERWISE ON DRAWINGS.
C. ALL UNDER FLOOR CONDUIT SHALL BE OF MINIMUM 1 INCH SIZE.
2.2 OUTLET BOXES
A. ALL OUTLET BOXES SHALL BE GALVANIZED PRESSED STEEL OF THE STANDARD KNOCKOUT TYPE. NO ROUND OUTLET BOXES SHALL BE PERMITTED UNLESS INDICATED AND FOR LIGHTING THAT REQUIRE SUCH CONFIGURATION. CONCEALED BOXES SHALL NOT BE LESS THAN 4 INCH SQUARE AND 1-1/2 INCH DEEP, WITH PLASTER RINGS.
B. ALL KNOCKOUT BOXES, UPON WHICH LIGHTING FIXTURES ARE TO BE INSTALLED, SHALL BE EQUIPPED WITH 3/8 INCH FIXTURE STUDS.
2.3 JUNCTION AND PULL BOXES
A. BOXES AND COVERS SHALL BE GALVANIZED STEEL OF CODE GAUGE AND SIZE.

PART 3 - EXECUTION

3.1 INSTALLATION

- A. SUPPORT ALL CONDUIT IN ACCORDANCE WITH THE NEC AND LOCAL CODES.
B. GENERALLY, ALL CONDUIT SHALL BE CONCEALED EXCEPT FOR UNFINISHED AREAS, SUCH AS EQUIPMENT ROOMS. EXPOSED CONDUIT SHALL BE ALLOWED ONLY AS NOTED ON PLAN AND AS APPROVED BY TENANT'S PROJECT MANAGER. PAINTING OF CONDUITS, NOTED ON DRAWINGS OR SPECIFICATIONS WILL BE BY GENERAL CONTRACTOR.
C. FLEXIBLE METAL CONDUIT OR MC TYPE CABLE FLEXIBLE CONDUIT OR MC TYPE CABLE SHALL ONLY BE USED FOR THE FOLLOWING APPLICATIONS:
a. FINAL CONNECTIONS TO MOTORS
b. FINAL CONNECTIONS INTO AND OUT OF THE TRANSFORMER
c. FINAL CONNECTIONS TO VIBRATING EQUIPMENT
d. INTER-CONNECTIONS BETWEEN ALL LIGHT FIXTURES
e. FINAL CONNECTIONS WHERE RIGID CONDUIT IS NOT PRACTICAL.
f. IN WALLS FOR LIGHT SWITCHES AND 120 VOLT POWER RECEPTACLES AND HVAC CONTROL EQUIPMENT).
D. FLEXIBLE METAL CONDUIT MUST BE THE SAME SIZE AS THE IMC OR EMT CONDUIT TO WHICH IT IS CONNECTED. THE FLEXIBLE METAL CONDUIT AND ITS FITTINGS ARE TO BE LISTED FOR GROUNDING. A GREEN GROUNDING CONDUCTOR SHALL BE INSTALLED. ALL CONNECTORS ARE TO BE OF A NEMA APPROVED TYPE.
E. THE USE OF ROMEX, BX, ETC. IS NOT PERMITTED.
F. PROVIDE PULL-WIRE IN ALL EMPTY CONDUITS EXCEPT AS NOTED OTHERWISE ON DRAWINGS.
G. HOME RUNS AND MAIN CONDUIT RUNS ARE TO BE HELD TIGHT TO STRUCTURE ABOVE OR AS REQUIRED TO ALLOW PROPER SERVICE ACCESS AND OTHER TRADES WORK. CONDUIT MUST BE TRAPEZED TO ALLOW 3 FEET MINIMUM CLEARANCE ABOVE CEILING.
H. ALL CONDUITS MUST BE SIZED PER NEC AND LOCAL CODES.
I. INSTALL BOXES RIGIDLY FROM BUILDING STRUCTURE AND SUPPORT INDEPENDENTLY OF THE CONDUIT SYSTEM. ALSO PROVIDE SUITABLE BOX EXTENSIONS TO EXTEND BOXES TO FINISHED FACES OF FLOORS, CEILINGS, WALLS, ETC. ALL OUTLET BOXES TO BE PROVIDED WITH CADDY "QUICK-MOUNT BOX SUPPORT" TO MINIMIZE THE DEFLECTION THAT OCCURS WHEN PLUGGING/UNPLUGGING INTO THESE DEVICES.
J. UNLESS OTHERWISE NOTED ON DRAWINGS OR OTHERWISE REQUIRED BY THE NATIONAL ELECTRIC CODE, HANDICAP CODES OR LOCAL CODES, OUTLET HEIGHTS SHALL BE AS FOLLOWS:
a. SWITCH HEIGHT 48 INCHES FROM FINISHED FLOOR TO CENTERLINE OF OUTLET
b. CONVENIENCE OUTLETS: 18 INCHES FROM FINISHED FLOOR TO CENTERLINE OF OUTLET
c. TELEPHONE OUTLETS SHALL BE LOCATED AS NOTED ON DRAWINGS
K. ARRANGE CIRCUITS TO AVOID THE USE OF JUNCTION BOXES IN INACCESSIBLE LOCATIONS. THE USE OF JUNCTION BOXES ABOVE DRYWALL CEILINGS SHOULD BE LIMITED TO LOCATIONS NEAR ACCESS FRAMES USED FOR DIFFUSERS AND RETURN AIR GRILLES OR ACCESS PANELS AS LOCATED ON PLANS.
L. JUNCTION AND PULL BOXES MUST BE LABELED WITH CIRCUIT NUMBER IDENTIFICATION AND SYSTEM TYPE ON COVER.
M. JUNCTION AND PULL BOXES MUST BE ACCESSIBLE ACCORDING TO NEC 314.29. REFER TO ARCHITECTURAL SPECIFICATIONS FOR ACCESS PANEL SPECIFICATION IF NEEDED.
3.2 TELEPHONE DATA AND COMPUTER SYSTEM
A. FURNISH AND INSTALL A SYSTEM OF CONDUIT RACEWAYS, OUTLET BOXES AND PULL WIRES AS SHOWN ON THE DRAWINGS UNLESS OTHERWISE NOTED ON PLANS. TELEPHONE SWITCHING APPARATUS, CONDUCTORS, INSTRUMENTS, MISCELLANEOUS EQUIPMENT AND APPURTENANCES ARE NOT PART OF THIS CONTRACT
B. OUTLET BOXES ARE TO BE 4 INCH SQUARE MINIMUM WITH SINGLE DEVICE COVER AND TELEPHONE PLATE
C. ALL PULL WIRES ARE TO BE LABELED FOR PURPOSE DESIGNATED.

END OF SECTION.

DIVISION 26 - ELECTRICAL

SECTION 260553 - IDENTIFICATION

PART 1 - GENERAL

1.1 SCOPE OF WORK

- A. REFER TO SECTION 260500.

PART 2 - PRODUCTS

2.1 EQUIPMENT LABELS

- A. MULTILAYER, MULTICOLOR PLASTIC LABELS WITH MECHANICAL ENGRAVING, FOR ATTACHMENT TO EQUIPMENT.

2.2 CONDUCTORS

- A. REFER TO SECTION 260519
B. PROVIDE SELF-ADHESIVE VINYL LABELS THAT ARE PREPRINTED.

PART 3 - EXECUTION

3.1 LABELING

- A. ALL EQUIPMENT (INCLUDING BUT NOT LIMITED TO PANELBOARDS, SWITCHBOARDS, DISTRIBUTION BOARDS, UPS'S, PDUS, MOTORS, TRANSFORMERS, DISCONNECT SWITCHES) SHALL BE LABELED INDICATING EQUIPMENT NAME AND FEEDER SIZE.
B. ALL BRANCH CIRCUIT WIRING DEVICES SHALL BE LABELED WITH CIRCUIT NUMBER.
C. ALL JUNCTION BOXES ABOVE CEILING AND BELOW RAISED FLOOR SHALL BE LABELED WITH CIRCUIT NUMBER.

END OF SECTION.

SECTION 260573 - OVERCURRENT PROTECTION DEVICE COORDINATION STUDY

PART 1 - GENERAL

1.1 SCOPE OF WORK

- A. REFER TO SECTION 260500.
B. UTILIZING A COMPUTER-BASED SOFTWARE PROGRAM, MODEL THE PROPOSED DISTRIBUTION SYSTEM, CALCULATE THE MAXIMUM AVAILABLE SHORT CIRCUIT THROUGHOUT AND COORDINATE THE SELECTION OF OVERCURRENT PROTECTION DEVICES TO MEET IEEE.
C. SUBMIT A FULL REPORT FOR REVIEW AND APPROVAL.

PART 2 - PRODUCTS (NOT USED)

PART 3 - EXECUTION (NOT USED)

END OF SECTION.

SECTION 262200 - TRANSFORMERS

PART 1 - GENERAL

1.1 SCOPE OF WORK

- A. REFER TO SECTION 260500.

PART 2 - PRODUCTS

2.1 DRY TYPE TRANSFORMERS

- A. PROVIDE TRANSFORMERS OF K RATINGS SHOWN ON THE DRAWINGS, WITH COPPER WINDINGS, VENTILATED ENCLOSURE, AND ELECTROSTATIC SHIELDING.
B. PROVIDE TWO, 2.5 PERCENT TAPS ABOVE AND TWO, 2.5 PERCENT TAPS BELOW FULL CAPACITY.

PART 3 - EXECUTION

3.1 INSTALLATION

- A. TRANSFORMER SHALL BE PAD MOUNTED OR SHALL BE SECURELY MOUNTED FROM THE BUILDING STRUCTURE.

REINFORCED WALLS OR AS NOTED ON DRAWINGS. USE ADDITIONAL VIBRATION ISOLATORS AT POINTS OF MOUNTING TO CUT VIBRATION NOISES. USE FLEXIBLE METALLIC CONDUIT WITH GROUNDING BUSHING FOR PRIMARY AND SECONDARY CONNECTIONS TO TRANSFORMER. TRANSFORMERS SHALL BE LOCATED, SET, MOUNTED AND CONNECTED IN SUCH A MANNER AS TO KEEP NOISE LEVELS WITHIN THE SURROUNDING AMBIENT NOISE LEVELS AND MAINTAIN ALL CODE REQUIRED CLEARANCES.

END OF SECTION.

SECTION 262416 - PANELBOARDS

PART 1 - GENERAL

1.1 SCOPE OF WORK

- A. REFER TO SECTION 260500.

PART 2 - PRODUCTS

2.1 PANELBOARDS

- A. ALL PANELBOARDS SHALL BE FACTORY ASSEMBLED OF THE BOLTED CIRCUIT BREAKER TYPE WITH SOLID COPPER BUSSING, FULL SIZED COPPER NEUTRAL, 100 PERCENT GROUND BUSSING, AND OVERALL HINGED/LOCKABLE DOOR. ALL CIRCUIT BREAKERS SHALL BE OF THE QUICK-MAKE AND QUICK-BREAK DESIGN, THERMAL-MAGNETIC TYPE, TRIP FREE AND TRIP-INDICATING. ALL PANELS SHALL BE DEAD FRONT AND FLUSH OR SURFACE MOUNTED AS SHOWN.
B. PANELBOARDS SHALL HAVE A MINIMUM SHORT CIRCUIT CURRENT RATING AND LUG CONNECTIONS AS REQUIRED BY A SHORT CIRCUIT STUDY.
C. ALL LUG CONNECTIONS TO BE 75 DEGREE C RATED.
D. PROVIDE ISOLATED GROUND BUS AND DOUBLE NEUTRAL BUS WHERE INDICATED ON THE DRAWINGS.

PART 3 - EXECUTION

3.1 INSTALLATION

- A. REFER TO DRAWINGS FOR FLUSH OR SURFACE MOUNTING.

END OF SECTION.

SECTION 262726 - WIRING DEVICES

PART 1 - GENERAL

1.1 SCOPE OF WORK

- A. REFER TO SECTION 260500.

PART 2 - PRODUCTS

2.1 SWITCHES AND RECEPTACLES

- A. FURNISH AND INSTALL SWITCHES AND RECEPTACLES, UNLESS NOTED OTHERWISE, AS NECESSARY FOR A COMPLETE INSTALLATION. COLOR OF DEVICES AND PLATES SHALL BE SELECTED BY THE ARCHITECT.
B. THE DEVICES SHALL BE OF THE TYPES AND RATINGS LISTED, OR EQUALS BY PASS & SEYMOR, HUBBELL, OR LEVITON.
a. SINGLE POLE SWITCHES: 20AMP - 120-277V: LEVITON 'DECORA' #5621-X
b. THREE WAY SWITCHES: 20AMP - 120-277V: LEVITON 'DECORA' #5623-X
c. DUPLEX RECEPTACLES: 20AMP - 125V: LEVITON 'DECORA' #16352-X
d. ISOLATED GROUND RECEPTACLES: 20AMP - 125V: LEVITON 'DECORA' #16352-IG
e. GROUND FAULT CIRCUIT INTERRUPTING RECEPTACLES: 20AMP - 125V: LEVITON 'DECORA' #8899
C. ALL DEVICE COVER PLATES SHALL BE LEVITON 'DECORA' NYLON STYLE.
2.2 WALL-BOX DIMMERS
A. DIMMERS SHALL BE LEVITON 'MONET' OR LUTRON "NOVA-T-STAR".
2.3 OCCUPANCY CONTROLS
A. WALL-SWITCH SENSORS SHALL BE OF THE PASSIVE INFARED TYPE DESCRIBED ON THE DRAWINGS WITH ADJUSTABLE TIME DELAY AND FIELD OF VIEW AND COVERAGE REQUIRED FOR THE INSTALLATION.
B. REFER TO THE DRAWINGS FOR PASSIVE INFARED, ULTRASONIC AND DUAL TECHNOLOGY OCCUPANCY SENSORS REQUIRED FOR LARGER SPACES. PROVIDE A COMPLETE SYSTEM INCLUDING SENSORS, POWER PACKS/RELAYS AND WALL OVERRIDE SWITCHES.
2.4 FLOOR BOXES
A. REFER TO THE DRAWINGS FOR DESCRIPTION OF REQUIRED FLOOR BOXES IN SLAB ON GRADE OR POKE-THRU INSTALLATIONS.

PART 3 - EXECUTION

3.1 INSTALLATION

- A. INSTALL DEVICES PER THE MANUFACTURER'S RECOMMENDATIONS.
B. LABEL ALL RECEPTACLES INDICATING PANELBOARD AND CIRCUIT NUMBER. INSTALL CLEAR LABEL WITH BLACK TEXT ON THE FACE OF WALL PLATE.

END OF SECTION.

SECTION 262816 - ENCLOSED SWITCHES

PART 1 - GENERAL

1.1 SCOPE OF WORK

- A. REFER TO SECTION 260500.

PART 2 - PRODUCTS

2.1 SAFETY SWITCHES

- A. SAFETY AND DISCONNECT SWITCHES SHALL BE HEAVY DUTY TYPE, QUICK-MAKE, QUICK-BREAK FUSED OR NON-FUSIBLE WITH RATINGS AND SIZES AS NOTED ON PLANS AND REQUIRED BY CODES.
B. SWITCHES SHALL BE WEATHERPROOF IN OUTDOOR LOCATION OR AS REQUIRED BY LOCAL CODES.

PART 3 - EXECUTION

3.1 INSTALLATION

- A. COORDINATE ALL CONTROL DEVICES WITH MECHANICAL CONTRACTOR. COMBINATION STARTER/DISCONNECT SWITCHES SHALL CONTAIN FUSIBLE SWITCHES AND ONLY USED WHERE INDICATED ON DRAWINGS.

END OF SECTION.

SECTION 264313 - SURGE SUPPRESSION DEVICE

PART 1 - GENERAL

1.1 SCOPE OF WORK

- A. REFER TO SECTION 260500.
B. ALL SPD'S MUST COMPLY WITH UL 1449 3RD ADDITION.

PART 2 - PRODUCTS

2.1 SERVICE ENTRANCES

- A. PROVIDE CURRENT TECHNOLOGY "TRANSGUARD", OR EQUAL, WITH L-N, L-G, N-G, AND L-L PROTECTION. UNIT SHALL HAVE A SINGLE SURGE CURRENT CAPACITY PER MODE OF 200,000 AMPS, 400,000 AMPS PER PHASE, AND HAVE REPETITIVE SURGE CURRENT CAPACITY PER MODE OF 6,500 IMPULSES.
B. PROVIDE SEPARATE NEMA 1 ENCLOSURES FOR SURFACE MOUNTING NEXT TO MAIN SERVICE EQUIPMENT.
2.2 PANELBOARD PROTECTION
A. PROVIDE CURRENT TECHNOLOGY "TRANSGUARD", OR EQUAL, WITH L-N, L-G, N-G, AND L-L PROTECTION. UNIT SHALL HAVE A SINGLE SURGE CURRENT CAPACITY PER MODE OF 100,000 AMPS, 200,000 AMPS PER PHASE, AND HAVE REPETITIVE SURGE CURRENT CAPACITY PER MODE OF 4,500 IMPULSES.
B. PROVIDE SEPARATE NEMA 1 ENCLOSURES FOR SURFACE OR FLUSH MOUNTING NEXT TO MAIN SERVICE EQUIPMENT.

PART 3 - EXECUTION

3.1 INSTALLATION

- A. INSTALL TVSS PER THE MANUFACTURER'S RECOMMENDATIONS USING LEADS AS SHORT AS POSSIBLE.

END OF SECTION.

SECTION 265100 - LIGHTING

PART 1 - GENERAL

1.1 SCOPE OF WORK

- A. REFER TO SECTION 260500.

PART 2 - PRODUCTS

2.1 LIGHT FIXTURES

- A. PROVIDE LIGHT FIXTURES, LAMPS AND BALLASTS AS SHOWN IN THE FIXTURE SCHEDULE ON THE DRAWINGS.
B. ALL INCANDESCENT FIXTURES SHALL BE EQUIPPED WITH APPLICABLE THERMAL PROTECTION.
C. FIXTURES SHALL BE PAINTED AFTER FABRICATION.
2.2 BALLASTS
A. BALLASTS FOR FLUORESCENT LAMPS SHALL BE ELECTRONIC, PROGRAMMABLE START, UL LISTED, CBM CERTIFIED AND ETL APPROVED.
B. THE MINIMUM SOUND RATING SHALL BE "A" AND BALLASTS SHALL HAVE A TOTAL HARMONIC DISTORTION OF LESS THAN 10 PERCENT.
C. PROVIDE DIMMABLE BALLASTS OF THE SAME CRITERIA FOR INSTANCES WHERE DIMMING IS INDICATED ON THE DRAWINGS.

D. BALLASTS FOR HID LAMPS SHALL ALSO CARRY AN "A" SOUND RATING AND HAVE A TOTAL HARMONIC DISTORTION OF LESS THAN 15 PERCENT.

2.3 EMERGENCY BATTERY PACKS

- A. UNITS SHALL BE SELF-CONTAINED MODULAR TYPE, INSTALLED IN THE BALLAST COMPARTMENT, CAPABLE OF OPERATING ONE (1) LAMP TO 1100 LUMENS.
B. PROVIDE TEST PUSH BUTTON AND INDICATOR LIGHT.

2.4 LAMPS


- A. REFER TO LIGHT FIXTURE SCHEDULE FOR REQUIRED LAMPS. PROVIDE LAMPS SUITABLE FOR USE WITH DIMMABLE BALLASTS WHERE INDICATED.

PART 3 - EXECUTION

3.1 INSTALLATION

- A. THIS CONTRACTOR SHALL FURNISH ADDITIONAL AUXILIARY SUPPORT STEEL HANGER WIRES ADEQUATELY SIZED TO SUPPORT THE WEIGHT OF THE FIXTURE FASTENED TO THE BUILDING STRUCTURE (MINIMUM TWO PER FIXTURE) FOR ALL FIXTURES IN LAY-IN CEILINGS AND OTHER FIXTURES AS REQUIRED BY THE OWNER AND LOCAL CODE OFFICIALS.
B. FURNISH AND INSTALL APPLICABLE FIRE RATED DRYWALL BOXES OVER RECESSED FIXTURES IN FIRE RATED CEILINGS AS REQUIRED BY CODES. FIELD COORDINATE AS REQUIRED TO AVOID CONFLICTS.

END OF SECTION.

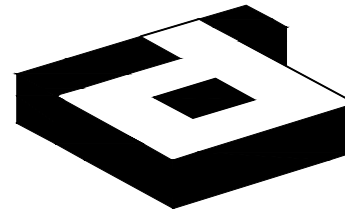

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BILLINGSLEY COMPANY

3401 OLYMPUS ARTISAN DESIGN GROUP

3401 OLYMPUS BLVD. SUITE #450 DALLAS, TX 75019

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LANDLORD/CLIENT REVIEW ISSUE DATE: 03/30/20 BID ISSUE DATE: 03/30/20 CONSTRUCTION ISSUE DATE: 03/30/20

Purdy - McGuire Mechanical - Electrical Engineers 17300 North Dallas Parkway Suite 3000 Dallas, Texas 75248-1147 Firm Registration # F-1511 Tel: 972/239-5357 Fax: 972/239-5231 www.purdy-mcguire.com

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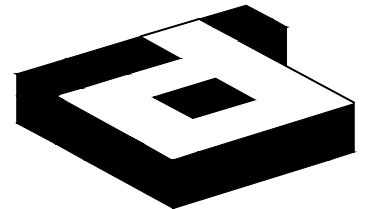
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DRAWING TITLE: ELECTRICAL SPECIFICATIONS 2 OF 2

DRAWING NUMBER:

E1.02

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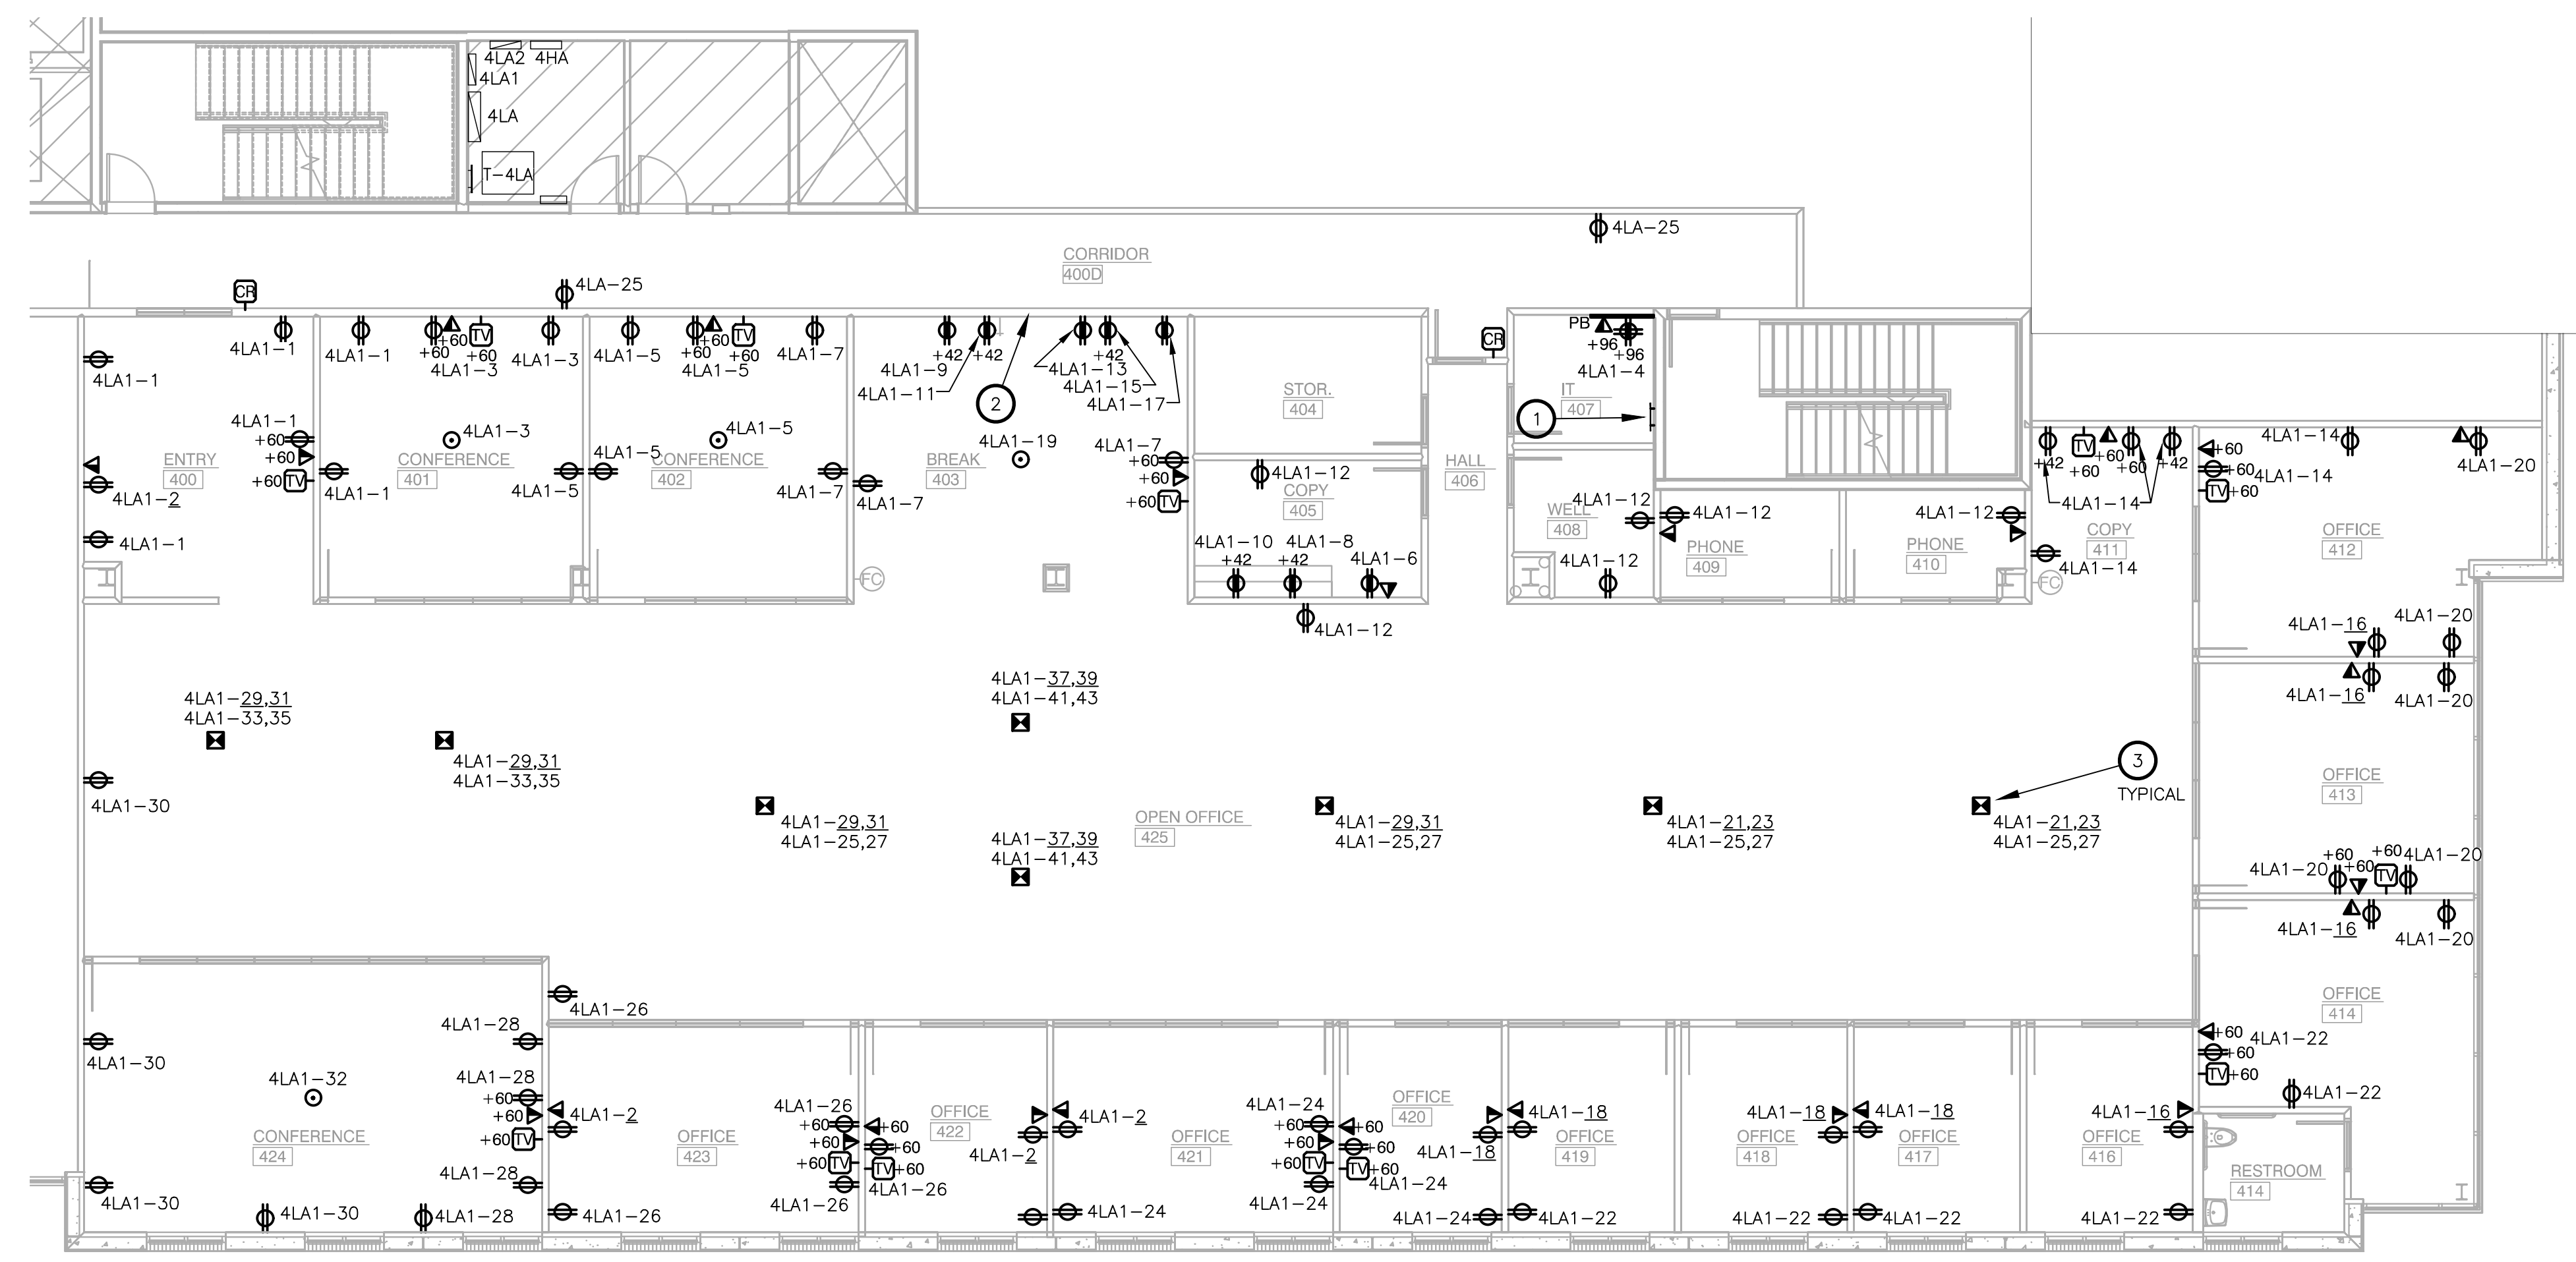
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DRAWING TITLE:  
**LEVEL 04 ELECTRICAL PLAN - EAST**

DRAWING NUMBER:

**E2.04E**


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**NOTES BY SYMBOL (X) :**


1. PROVIDE 12"x2"x1/4" COPPER GROUND BUS WALL MOUNTED WITH INSULATING STANDOFFS AT 48" AFF. EXTEND 1#6AWG IN 3/4" C FROM GROUND BUS TO BUILDING GROUND.
2. REFER TO MECHANICAL EQUIPMENT POWER SCHEDULE ON SHEET E0.01 FOR POWER TO WATER HEATER.
3. CONFIRM FURNITURE SYSTEM WIRING CONFIGURATION PRIOR TO INSTALLATION. CIRCUIT SHOWN FOR 2+2 ARE AN ASSUMPTION ONLY. NOTIFY ARCHITECT IF SUPPLIED WORKSTATIONS POWER CONFIGURATION IS NOT 2+2.

**1 LEVEL 04 ELECTRICAL PLAN**  
SCALE: 1/8"=1'-0"



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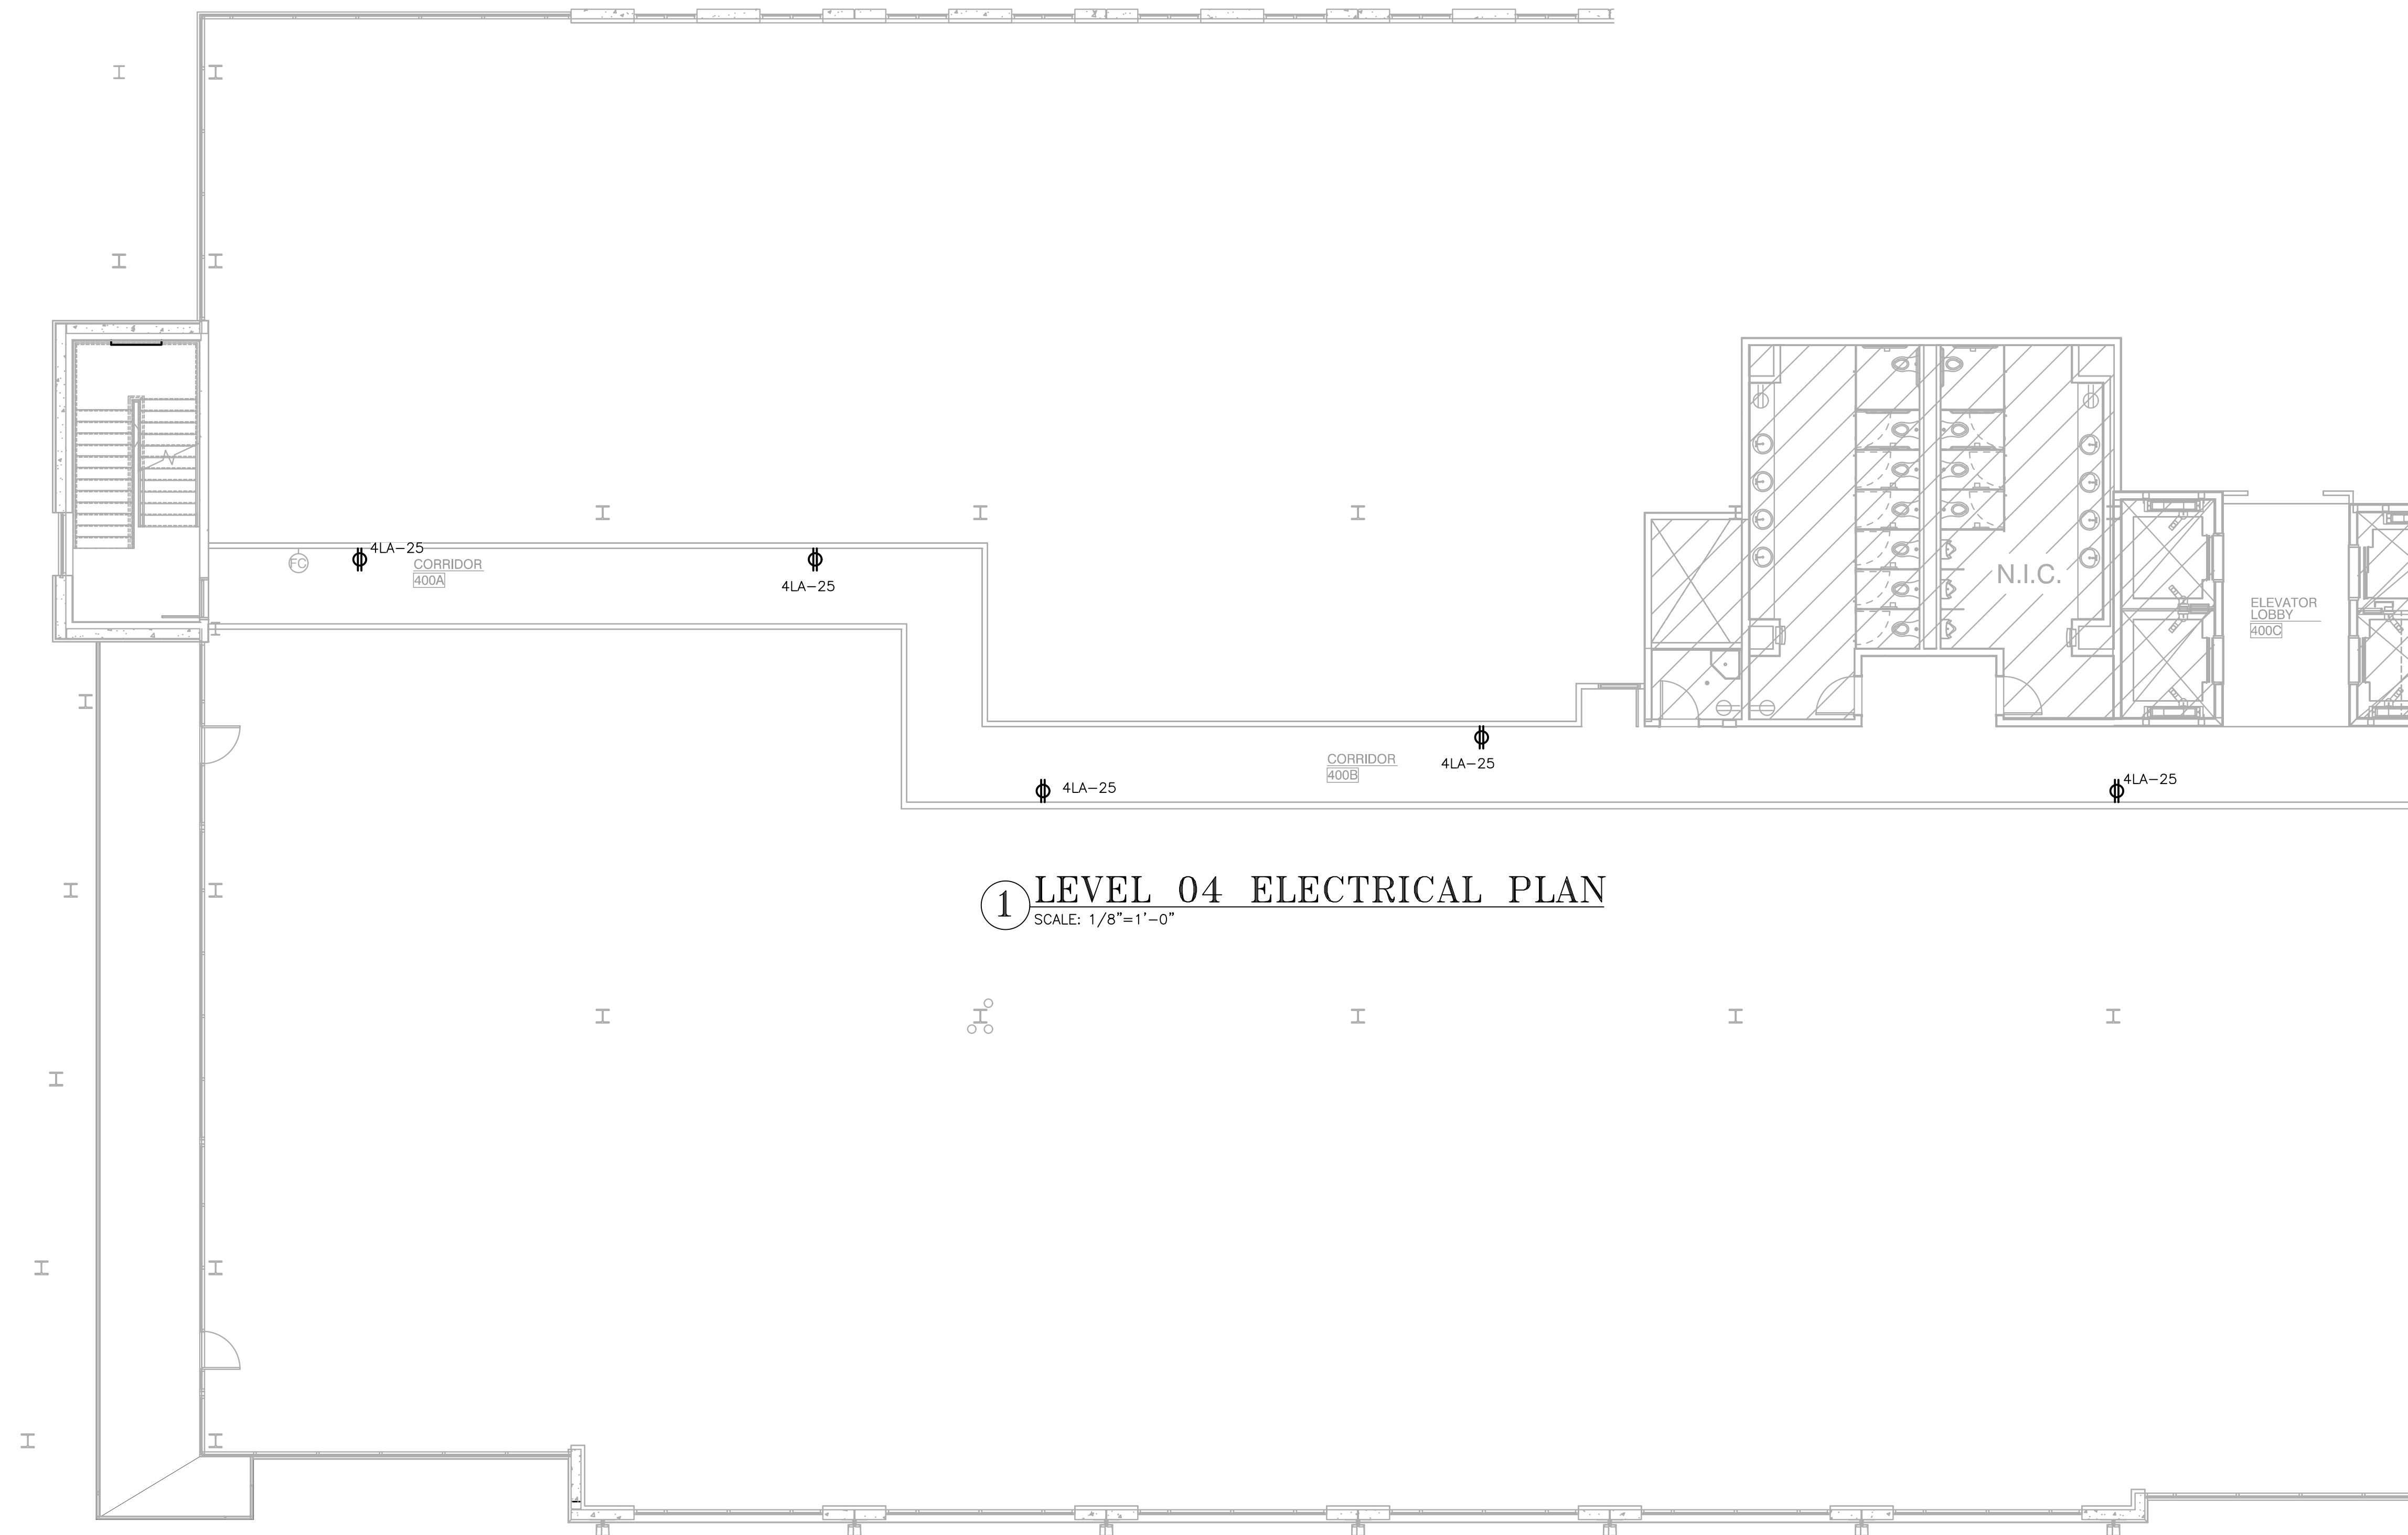
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**LEVEL 04 ELECTRICAL  
PLAN - WEST**

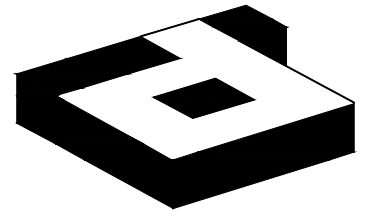
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**1 LEVEL 04 ELECTRICAL PLAN**  
SCALE: 1/8"=1'-0"

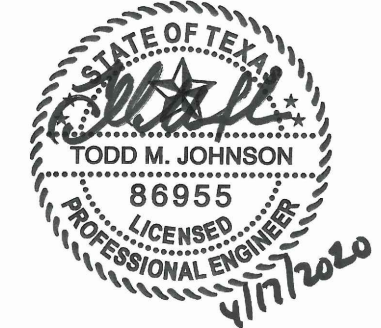

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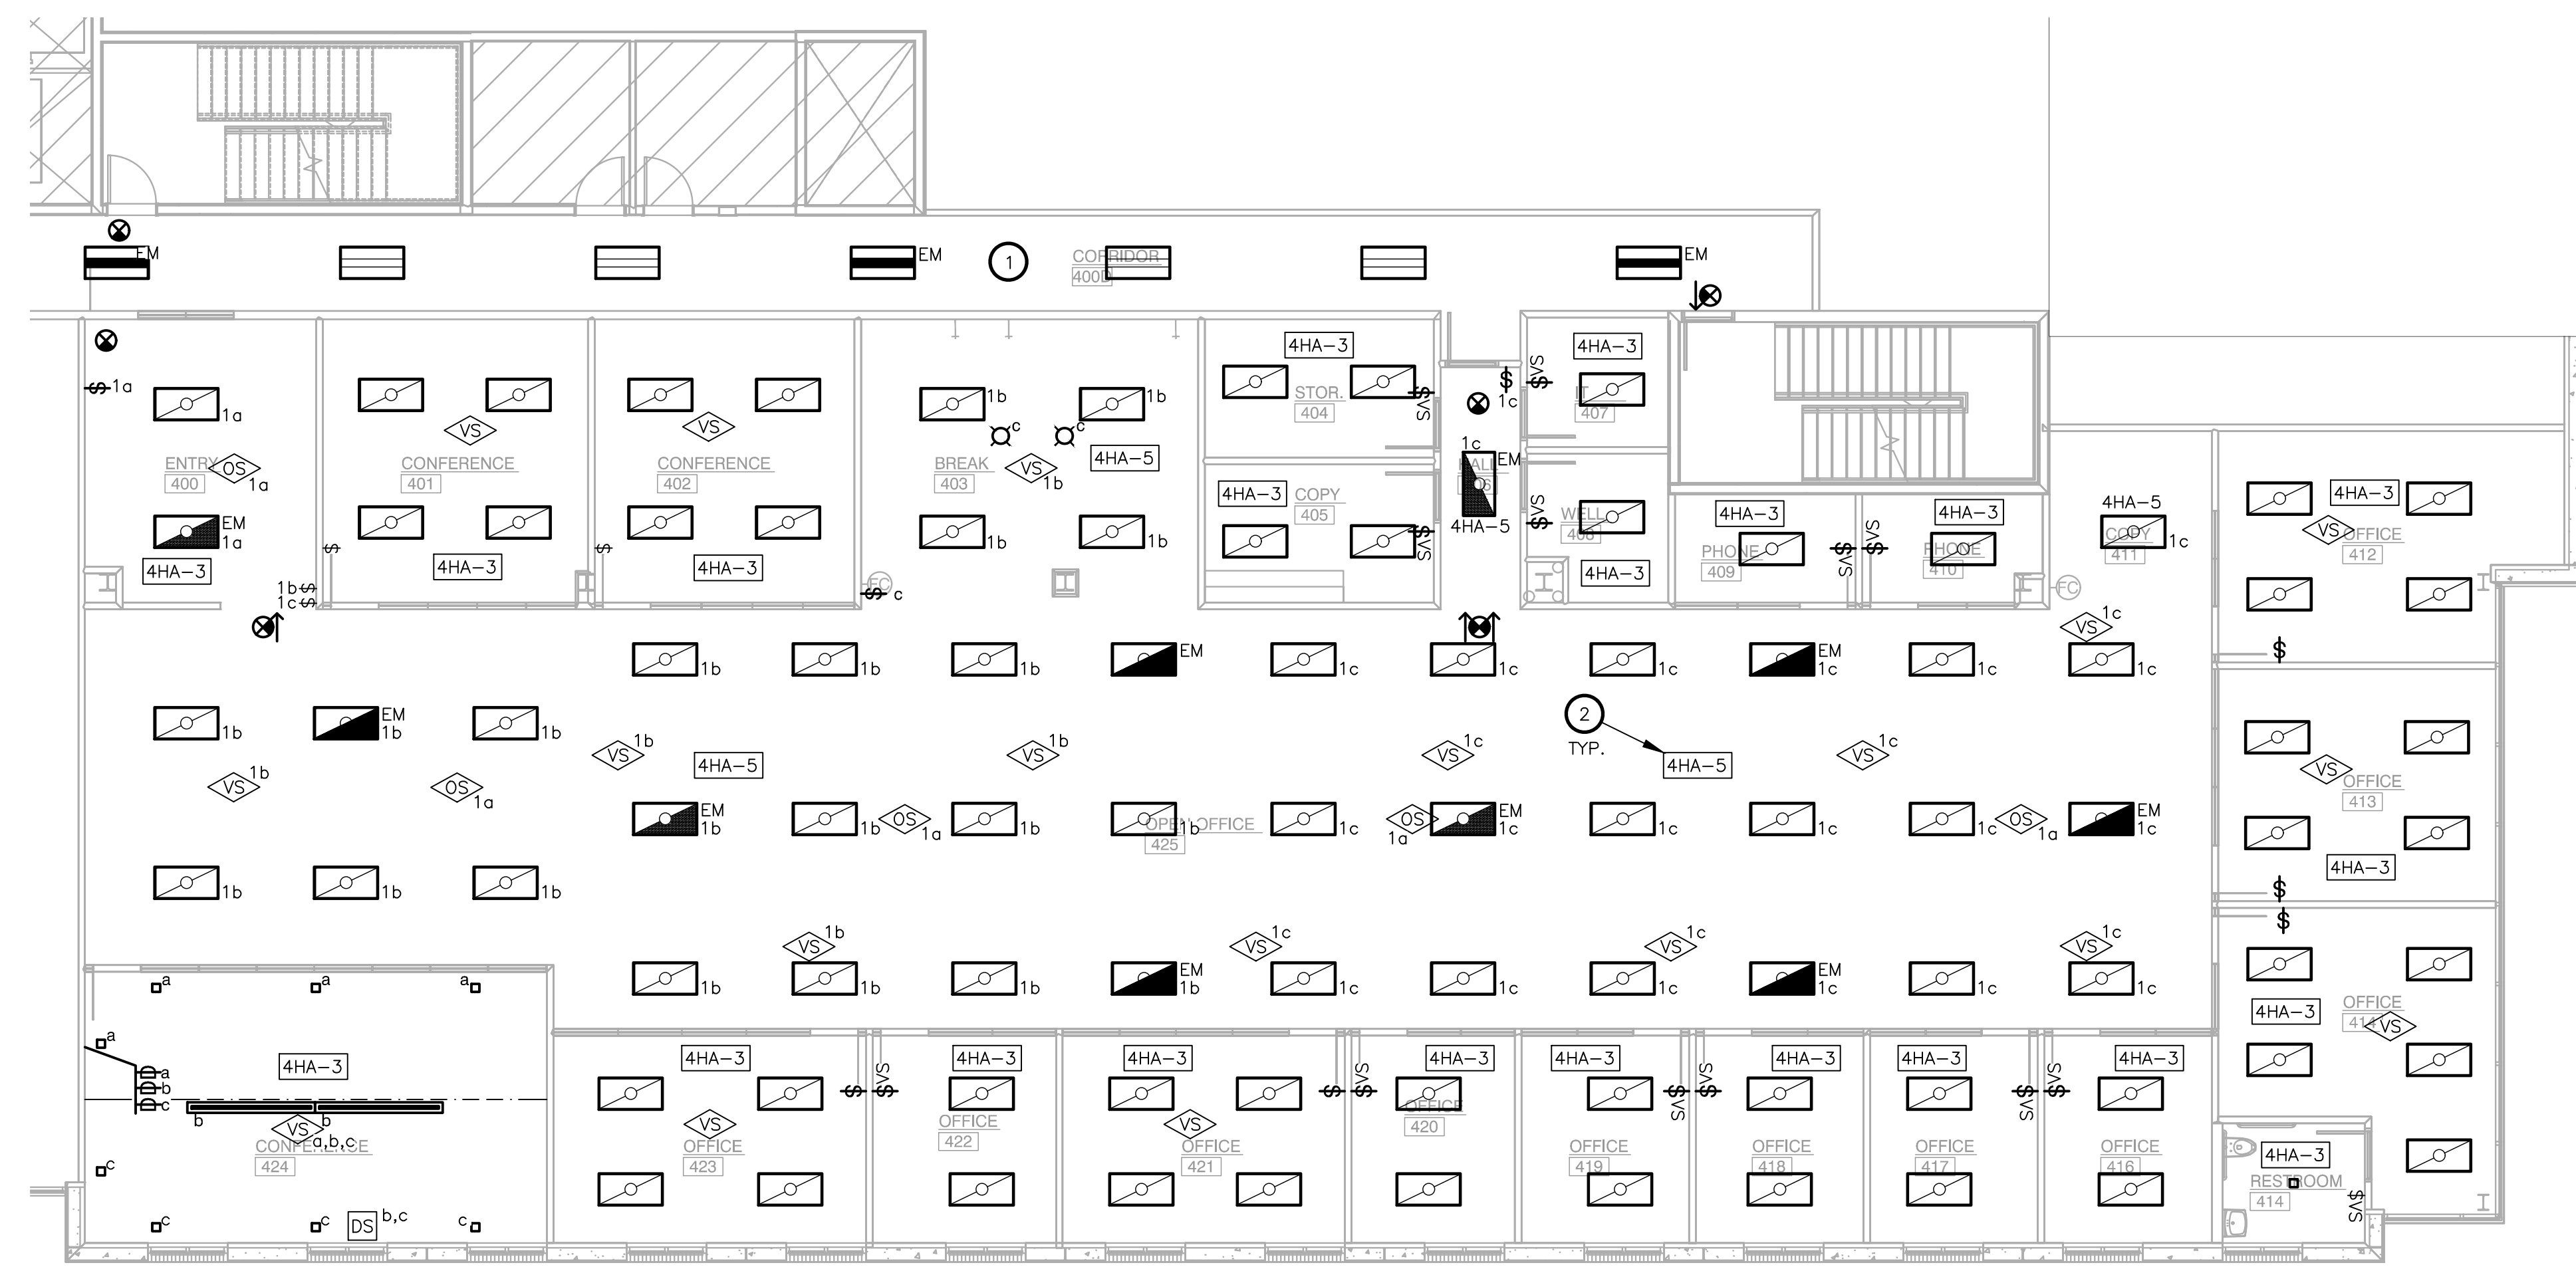
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DRAWING TITLE:  
**LEVEL 04 LIGHTING PLAN - EAST**

DRAWING NUMBER:  
**E3.04E**


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**NOTES BY SYMBOL :**

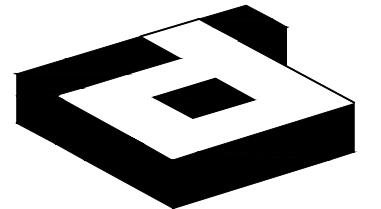- CORRIDOR AND ELEVATOR LIGHTING CONTROLS SHALL GO BACK TO BUILDING SYSTEM SIMILAR TO THE 1ST FLOOR LOBBY CONTROLS WITH NO LOCAL OVERRIDE. CONTRACTOR SHALL VERIFY SYSTEM. CONNECT TO EXISTING 4TH FLOOR CORE/SHELL LIGHTING CIRCUIT. NO MORE THAN 3500 WATTS PER 20 AMP CIRCUIT.
- INDICATES ALL LIGHTING IN THE ROOM/AREA SHALL BE ON THIS CIRCUIT EXCEPT FOR EMERGENCY LIGHTS OR AS NOTED OTHERWISE.

**1 LEVEL 04 LIGHTING PLAN**  
SCALE: 1/8"=1'-0"



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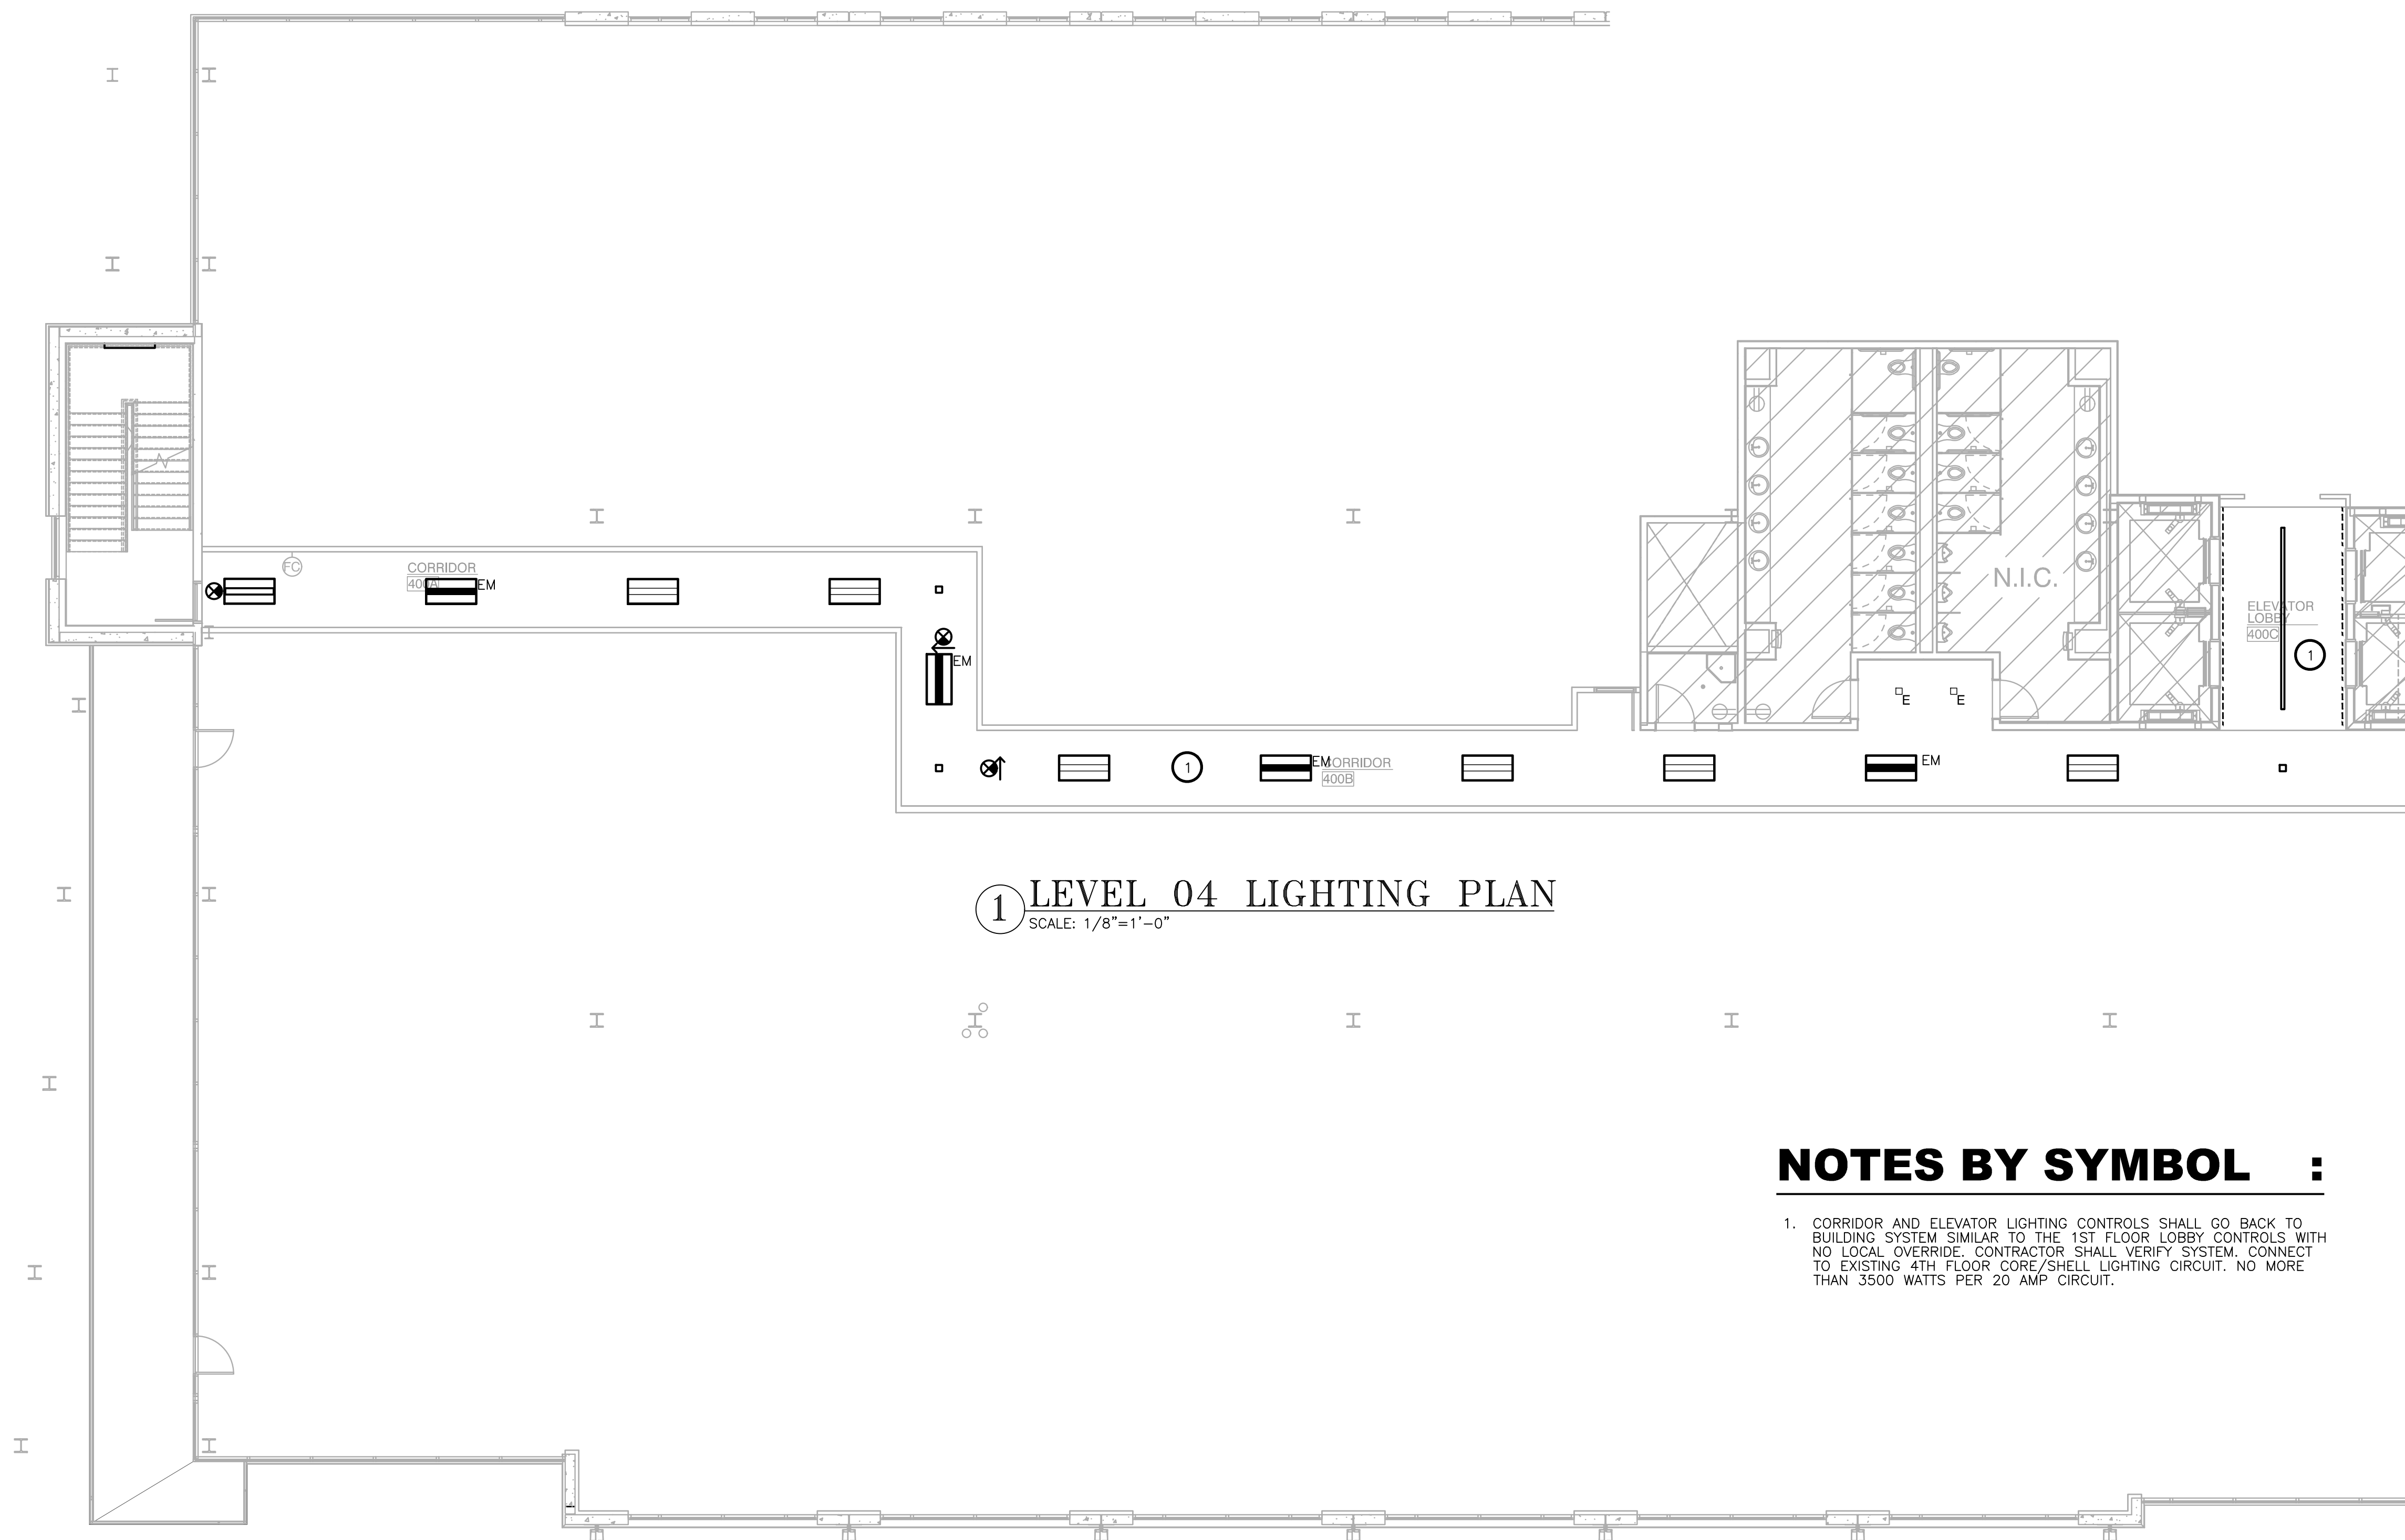

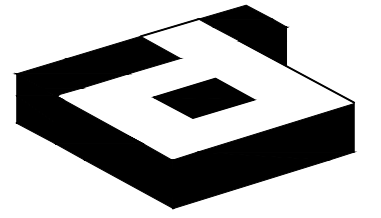
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**LEVEL 04 LIGHTING PLAN**

SCALE: 1/8"=1'-0"

**NOTES BY SYMBOL :**

- 1. CORRIDOR AND ELEVATOR LIGHTING CONTROLS SHALL GO BACK TO BUILDING SYSTEM SIMILAR TO THE 1ST FLOOR LOBBY CONTROLS WITH NO LOCAL OVERRIDE. CONTRACTOR SHALL VERIFY SYSTEM, CONNECT TO EXISTING 4TH FLOOR CORE/SHELL LIGHTING CIRCUIT. NO MORE THAN 3500 WATTS PER 20 AMP CIRCUIT.

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DRAWING TITLE:  
**LEVEL 04 LIGHTING PLAN - WEST**

DRAWING NUMBER:

**E3.04W**

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## FIRE PROTECTION SPECIFICATION:

MODIFY THE EXISTING WET PIPE FIRE SPRINKLER SYSTEM AS REQUIRED FOR THE NEW TENANT LAYOUT INCLUDING RELOCATING PIPING TO CLEAR NEW DUCTWORK, ADDING NEW HEADS, RELOCATING EXISTING HEADS, AND LEAVING CERTAIN EXISTING HEADS IN PLACE. THE SPRINKLER DESIGN SHALL COMPLY WITH NFPA 13, THE REQUIREMENTS OF THE LOCAL AUTHORITIES HAVING JURISDICTION AND THE REQUIREMENTS OF THE OWNER'S INSURANCE COMPANY. EXISTING SPRINKLER HEADS TO BE RELOCATED MAY BE REUSED. EXISTING PIPING WHICH IS REMOVED IN THE MODIFICATION WORK SHALL NOT BE REUSED. NEW SPRINKLER PIPING SHALL BE ROUTED AS REQUIRED TO CLEAR NEW DUCTWORK, EXISTING DUCTWORK TO REMAIN, LIGHT FIXTURES, STRUCTURAL INTERFERENCES, ETC. THE NEW SPRINKLER HEADS SHALL MATCH EXISTING SPRINKLER HEADS. ALL PIPING SHALL BE SCHEDULE 40 WITH USA FITTINGS.

IN ALL GYP. BOARD CEILING AREA, PROVIDE CONCEALED SPRINKLER HEADS WITH CAPS TO BE FACTORY PAINTED TO MATCH CEILING. ALL SPRINKLER HEADS IN LAY-IN CEILING SHALL BE LOCATED IN CENTER OF TILE AND ALIGNED WITH LIGHT FIXTURES.

SPRINKLER CONTRACTOR SHALL PROVIDE SHOP DRAWINGS OF CALCULATIONS AND SPRINKLER HEAD LOCATIONS FOR ARCHITECT TO REVIEW PRIOR TO ANY INSTALLATION. NO EXCEPTION TAKEN.


ALL SPRINKLER HEADS IN EXPOSED CEILING SHALL BE TURNED TO THE UPRIGHT POSITION AND REPLACE HEADS IF REQUIRED.

## PLUMBING SYMBOLS

SYMBOL	DESCRIPTION
	SANITARY SEWER
	VENT
	DOMESTIC COLD WATER
	DOMESTIC HOT WATER
	DRAIN PIPING
	CLEAN OUT
	PIPING DOWN
	PIPING UP -OR- PIPING UP & DOWN
	CAP ON END OF PIPE
	DIRECTION OF FLOW
	ASME TEMPERATURE & PRESSURE RELIEF VALVE
	BALL VALVE
	UNION
	CONNECTION TO EXISTING

## GENERAL NOTES:

- ALL WORK SHALL COMPLY WITH APPLICABLE NATIONAL, STATE AND LOCAL CODES, RULES, REGULATIONS AND REQUIREMENTS.
- ALL WORK SHALL COMPLY WITH THE BUILDING TENANT CONSTRUCTION GUIDE. COORDINATE WITH BUILDING MANAGEMENT/OWNER FOR ACCESS TO ANY TENANT LEASE SPACES THAT MIGHT BE REQUIRED FOR THE INSTALLATION. UNLESS DIRECTED BY LANDLORD ALL EQUIPMENT AND WORKMANSHIP SHALL BE GUARANTEED FOR 1 YEAR.
- EXISTING CONDITIONS ARE BASED ON INFORMATION PROVIDED BY PREVIOUS RECORD DRAWINGS DATED 1/18/2019 HOWEVER, IT IS NOT INTENDED TO BE A TRUE REPRESENTATION OF ACTUAL CONDITIONS. CONTRACTOR SHALL VISIT JOB SITE PRIOR TO BIDDING TO ASCERTAIN EXISTING CONDITIONS AND SHALL NOTIFY ARCHITECT OF ANY DISCREPANCIES PRIOR TO BID.
- PIPING LAYOUT IS SCHEMATIC, EXACT LOCATION OF PIPES TO BE COORDINATED WITH BUILDING STRUCTURE AND WORK OF OTHER CONTRACTORS.
- CONTRACTOR SHALL COORDINATE PLUMBING ROUGH-IN WITH ARCHITECTURAL DRAWINGS TO PROVIDE EXACT PLUMBING LOCATION FOR FIXTURES.
- COORDINATE EXACT LOCATION OF ALL WATER AND DRAIN CONNECTIONS FOR EQUIPMENT PROVIDED BY OTHERS.
- COPPER COLD, HOT AND HOT WATER LINES SHALL BE INSULATED WITH RIGID FIBERGLASS WITH WHITE ALL-SERVICE JACKET AND VAPOR BARRIER. FITTINGS SHALL BE PRE-MOLDED OF THE SAME MATERIAL. REFER TO PLUMBING INSULATION SCHEDULE.
- RUN ALL WATER LINES LEVEL.
- THIS CONTRACTOR IS TO PROVIDE ALL ADDITIONAL STEEL, HANGER MATERIALS, RODS AND CLAMPS AS REQUIRED FOR COORDINATION WITH WORK OF OTHER TRADES.
- SUPPORT CAST IRON SANITARY PIPING NOT IN EARTH, ON 5'-0" CENTERS, ALL STEEL PIPING ON 10'-0" CENTERS AND COPPER PIPING ON 8'-0" CENTERS.
- THIS CONTRACTOR IS RESPONSIBLE FOR FIRESTOPPING AT ALL PLUMBING RELATED PENETRATIONS OF FIRE AND SMOKE RATED STRUCTURES, FLOORS AND PARTITIONS. REFER TO ARCHITECTURAL FLOOR PLANS FOR LOCATIONS OF ALL RATED STRUCTURES.
- ALL FIXTURES TO BE EQUIPPED WITH STOP VALVES IN ACCESSIBLE LOCATION.
- CONTRACTOR SHALL PROVIDE SHUT-OFF VALVE AT EACH BRANCH LINE CONNECTING TO THE MAIN. PROVIDE BRASS VALVE TAGS WITH DOCUMENTATION IN CLOSEOUT DOCUMENTS.
- MAIN WATER SHUT-OFFS SHALL BE ACCESSIBLE.
- PROVIDE ACCESSIBLE CLEANOUTS AT NOT MORE THAN 50 FEET APART IN HORIZONTAL SANITARY DRAINAGE LINES 4" SIZE OR LESS, AND NOT MORE THAN 100 FEET APART FOR LARGER PIPES.
- PROVIDE ACCESSIBLE CLEANOUTS AT BASE OF ALL SANITARY STACKS AND OTHER PLACES AS REQUIRED BY CODE.
- WATER HEATER SHALL HAVE BOTH WATER AND ELECTRICAL SHUT-OFFS AT EASILY ACCESSIBLE LOCATIONS.
- CONTRACTOR SHALL BE RESPONSIBLE FOR DEMOLITION AND REMOVAL OF ALL ABANDONED PLUMBING LINES.
- ALL DOMESTIC WATER PIPING SHALL BE TYPE "L" HARD DRAWN SEAMLESS COPPER WATER TUBE CONFORMING TO ASTM B88. JOINED WITH WROUGHT COPPER SWEAT TYPE FITTINGS SHALL CONFORM TO ANSI B16.22. WHERE SOLDERED COPPER PIPING IS CONNECTED TO THREADED BRASS PIPING, A CAST BRASS ADAPTER SHALL BE USED. SOLDERED COPPER JOINTS SHALL BE SOLDERED WITH LEAD FREE ASTM B32 GRADE 95T TIN-ANTIMONY SOLDER. EXPOSED PIPING CONNECTED TO FIXTURES AND EQUIPMENT SHALL BE MADE WITH RED BRASS, GRADE "A". NO FERROUS PIPING OR MATERIALS WILL BE ALLOWED.
- ALL SOIL WASTE AND VENT SANITARY DRAINAGE LINES SHALL BE CAST IRON SOIL PIPE AND FITTINGS. COATED INSIDE AND OUTSIDE. MANUFACTURED IN ACCORDANCE WITH ASTM A-74, AND SHALL BE LABELED WITH CAST IRON SOIL PIPE INSTITUTES "MARK OF QUALITY AND PERMANENCE." JOINTS SHALL BE FABRICATED BY THE USE OF "PUSH-ON" TYPE GASKETED JOINTS BELOW GRADE AND "NO-HUB" MECHANICAL JOINTS ABOVE GRADE. PIPING MAY BE PVC ONLY IF ALLOWED PER CODE. (WEIGHT OF PIPE SHALL BE AS REQUIRED BY CODE FOR LOCATION AND DUTY).
- CONDENSATE DRAIN AND INDIRECT DRAIN PIPING SHALL BE TYPE "DWV" HARD DRAWN COPPER PIPE, WITH CAST OR WROUGHT COPPER DRAINAGE PATTERN FITTINGS. PIPING SHALL BE EXTENDED FROM UNIT OR FIXTURE TO DRAIN. ALL PIPING IN CEILING PLENUM SHALL BE INSULATED WITH 1/2" ARMAFLEX OR 1/2" FIBERGLASS WITH ALL SERVICE JACKET.
- PLUMBING CONTRACTOR SHALL X-RAY SLAB PRIOR TO ANY CORE-DRILLING. COORDINATE WITH BUILDING MANAGEMENT FOR AFTER-HOURS ACCESS TO SPACE.
- REFER TO PLUMBING RISER DIAGRAMS FOR PIPING SIZES NOT SHOWN ON PLAN.

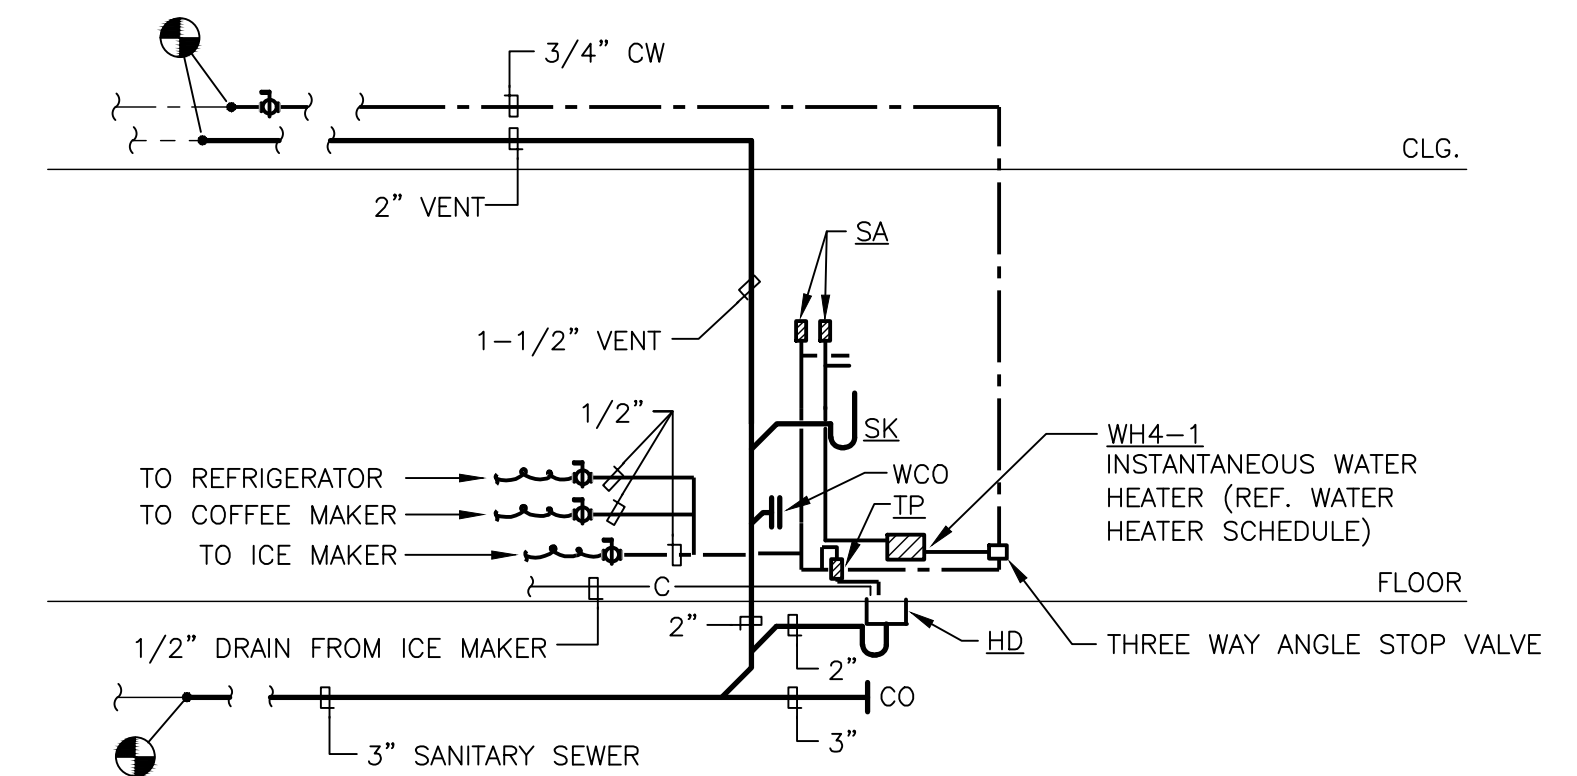

1 PLUMBING RISER DIAGRAM  
SCALE: NOT TO SCALE

## DALLAS GREEN BUILDING REQ.


702.7 HOT AND TEMPERED WATER DISTRIBUTION. WATER SUPPLY PIPING SHALL BE IN ACCORDANCE WITH SECTION 702.7 OR SECTION 702.7.2. THE FLOW RATE THROUGH 1/4-INCH (6.4 MM) TUBING SHALL NOT EXCEED 0.5 GPM (1.9 LPM). THE FLOW RATE THROUGH 5/16-INCH (7.9 MM) TUBING SHALL NOT EXCEED 1 GPM (3.8 LPM). THE FLOW RATE THROUGH 3/8-INCH (9.5 MM) TUBING SHALL NOT EXCEED 1.5 GPM (5.7 LPM).

702.7.1 MAXIMUM ALLOWABLE PIPE LENGTH METHOD. THE MAXIMUM ALLOWABLE PIPE LENGTH FROM THE SOURCE OF HOT OR TEMPERED WATER TO THE TERMINATION OF THE FIXTURE SUPPLY PIPE SHALL BE IN ACCORDANCE WITH THE MAXIMUM PIPE LENGTH COLUMNS IN TABLES 702.7.2(2) THROUGH 702.7.2(10), AS APPROPRIATE FOR THE TYPE OF PIPE TO BE INSTALLED. WHERE THE TYPE OF PIPE TO BE INSTALLED IS UNKNOWN OR THE TYPE OF PIPE IS NOT COVERED BY TABLES 702.7.2(2) THROUGH 702.7.2(10), TABLE 702.7.2(1) SHALL BE USED FOR DESIGN PURPOSES. WHERE THE LENGTH CONTAINS MORE THAN ONE SIZE OF PIPE, THE LARGEST SIZE SHALL BE USED FOR DETERMINING THE MAXIMUM ALLOWABLE LENGTH OF THE PIPE IN THE TABLES.

702.7.2 MAXIMUM ALLOWABLE PIPE VOLUME METHOD. THE WATER VOLUME IN THE PIPING SHALL BE CALCULATED IN ACCORDANCE WITH SECTION 702.7.2.1. THE MAXIMUM VOLUME OF HOT OR TEMPERED WATER IN THE PIPING TO PUBLIC LAVATORY FAUCETS, METERING OR NONMETERING, SHALL BE 2 OUNCES (0.06 L). FOR FIXTURES OTHER THAN PUBLIC LAVATORY FAUCETS, THE MAXIMUM VOLUME SHALL BE 64 OUNCES (1.89 L) FOR HOT OR TEMPERED WATER FROM A WATER HEATER OR BOILER; AND 24 OUNCES (0.7 L) FOR HOT OR TEMPERED WATER FROM A CIRCULATION LOOP PIPE OR AN ELECTRICAL HEAT-TRACED PIPE. THE WATER VOLUME IN THE PIPING SHALL BE CALCULATED IN ACCORDANCE WITH SECTION 702.7.2.1.

702.7.2.1 WATER VOLUME DETERMINATION. THE VOLUME SHALL BE THE SUM OF THE INTERNAL VOLUMES OF PIPE, FITTINGS, VALVES, METERS AND MANIFOLDS BETWEEN THE SOURCE OF HOT WATER AND THE TERMINATION OF THE FIXTURE SUPPLY PIPE. THE VOLUME SHALL BE DETERMINED FROM THE LIQUID OUNCES PER FOOT COLUMN OF TABLES 702.7.2(2) THROUGH 702.7.2(10) AS APPROPRIATE FOR THE TYPE OF PIPE. WHERE THE TYPE OF PIPE IS UNKNOWN OR THE TYPE OF PIPE IS NOT COVERED BY TABLES 702.7.2(2) THROUGH 702.7.2(10), TABLE 702.7.2(1) SHALL BE USED TO DETERMINE THE VOLUME. THE VOLUME CONTAINED WITHIN FIXTURE SHUTOFF VALVES, FLEXIBLE WATER SUPPLY CONNECTORS TO A FIXTURE FITTING, OR WITHIN A FIXTURE FITTING SHALL NOT BE INCLUDED IN THE WATER VOLUME DETERMINATION. WHERE HOT OR TEMPERED WATER IS SUPPLIED BY A CIRCULATION LOOP PIPE OR AN ELECTRICAL HEAT-TRACED PIPE, THE VOLUME SHALL INCLUDE THE PORTION OF THE FITTING ON THE SOURCE PIPE THAT SUPPLIES WATER TO THE FIXTURE.

PLUMBING FIXTURE SCHEDULE			
DESIGNATION	FIXTURE	MANUFACTURER AND MODEL NO.	DESCRIPTION, TRIM AND NOTES
SK	SINK	ELKAY LUSTERTONE ELUHAD211555 WITH EDGEWATER 4932.410 FAUCET	SINGLE COMPARTMENT UNDERMOUNT, 18 GAUGE TYPE 304 STAINLESS STEEL, 5-3/8" DEEP SINK WITH DRAIN AND CUP STRAINER. PROVIDE SINGLE HANDLE SWIVEL FAUCET PROVIDING 1.5 GPM. PROVIDE CHROME PLATED CAST P-TRAP WITH CLEANOUT, CHROME PLATED FLEX SUPPLIES, WALL STOPS AND WALL ESCUTCHEONS. PROVIDE TRUEBRO INSULATION KIT FOR ADA COMPLIANCE.
WC	WATER CLOSET	AMERICAN STANDARD MADERA 2854.528 WITH MANUAL FLUSH VALVE	VITREOUS CHINA, FLOOR MOUNTED, HIGH EFFICIENCY, SIPHON JET, 1.28 GALLON/FLUSH, ELONGATED BOWL WITH CHURCH #9500CT SEAT AND HEAVY DUTY (500 LB. STATIC LOAD) CARRIER.
LV	LAVATORY	AMERICAN STANDARD MURRO 0958.008EC WITH SHROUD 0059.0020EC AND AMERICAN STANDARD MONTERREY 6409.171 FAUCET	WALL MOUNTED VITREOUS CHINA LAVATORY SINK WITH DRAIN AND 3-HOLE PUNCH. PROVIDE GOOSENECK FAUCET WITH DUAL WRIST BLADE HANDLES AT 1.5 GPM. ALSO PROVIDE CHROME PLATED CAST BRASS P-TRAP WITH CLEANOUT. CHROME PLATED GRIP TYPE SUPPLY WITH WALL ESCUTCHEON AND LOOSE-KEY WALL STOPS EQUAL TO MCGUIRE NO. H2.15BLK.
FD	FLOOR DRAIN	WATTS DRAINAGE MODEL #FD-100-A	CAST IRON DRAIN WITH SATIN NIKALOY STRAINER, CAST IRON FLASHING COLLAR AND TRAP PRIMER CONNECTION.
HD	HUB DRAIN	JOSAM SERIES 88600	OPEN CAST IRON DRAINAGE HUB.
SA	SHOCK ARRESTOR	WATTS DRAINAGE SG SERIES	WROUGHT COPPER SHELL SIZE AND LOCATE IN ACCORDANCE WITH P.D.I. STANDARDS.
TP	TRAP PRIMER	PRECISION PLUMBING PRODUCTS	ALL BRASS WITH DISTRIBUTION UNIT WHERE REQUIRED.

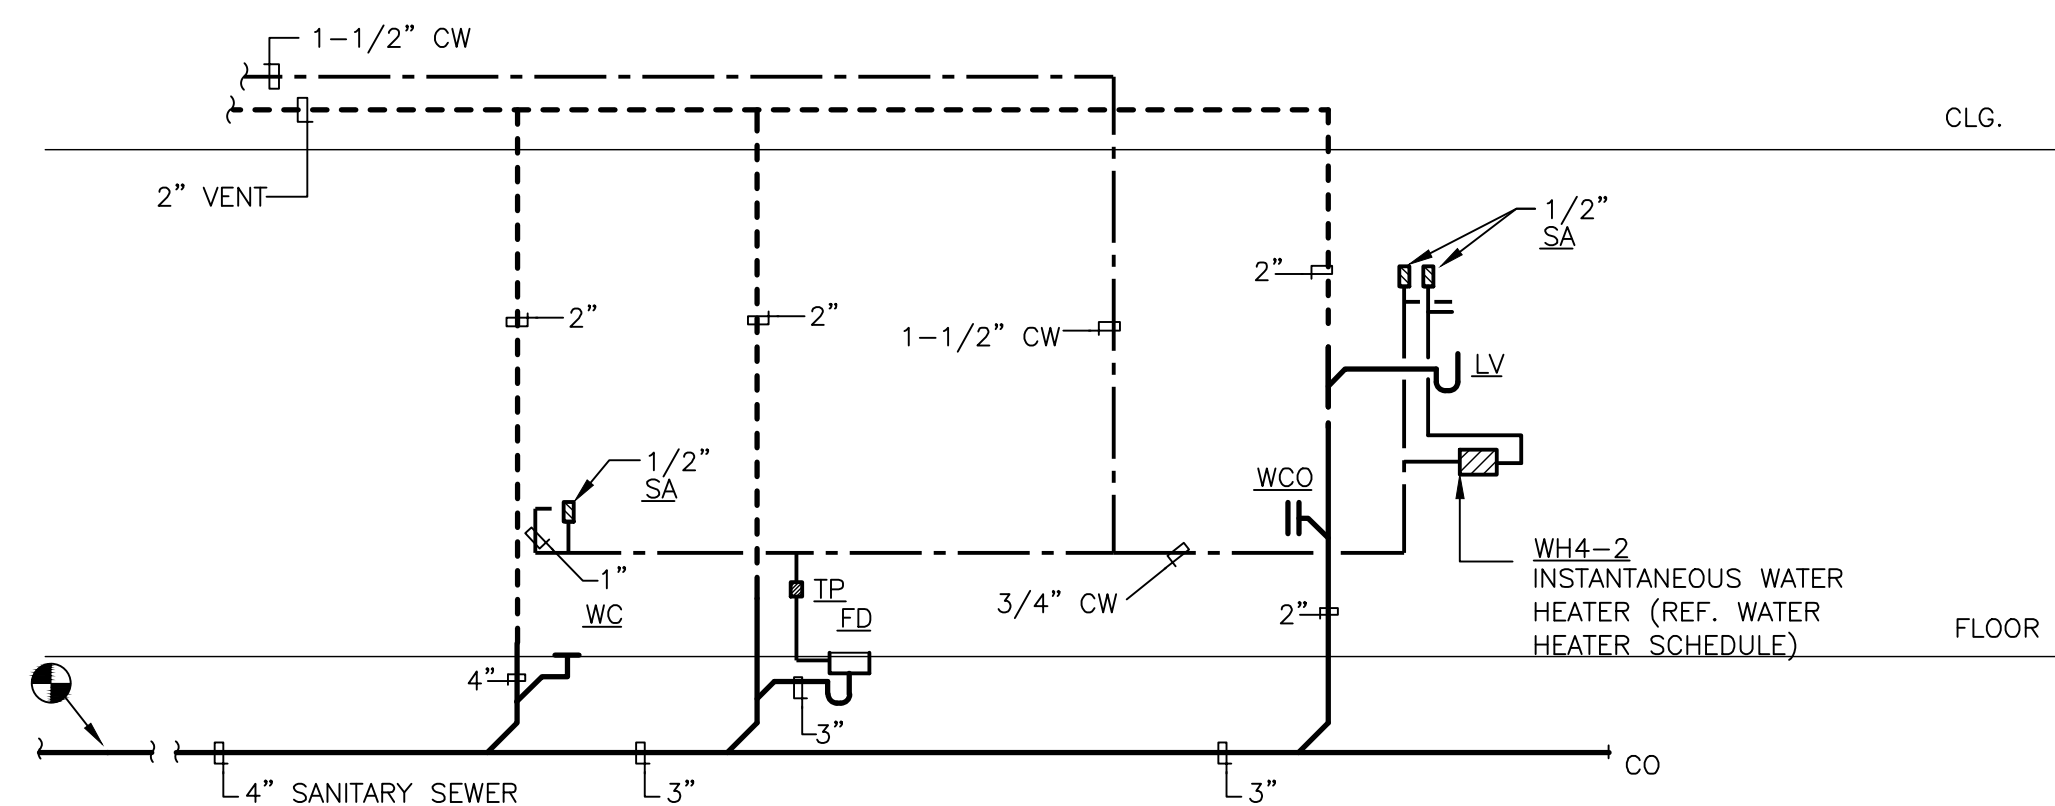

2 PLUMBING RISER DIAGRAM RESTROOM  
SCALE: NOT TO SCALE

## ELECTRICAL WATER HEATER SCHEDULE

WATER HEATER DESIGNATION	SERVES	INPUT	ELECTRICAL			STORAGE GALLONS	RECOVERY GPH/GPM	DEGREE °F RISE	WATER TEMP AVG °F	EQUAL TO MANUFACTURER	NOTES
			VOLTAGE	PHASE	FLA						
WH4-1	BREAK	8310 WATTS	277	1	30.0	NA	1 GPM	57	---	CHRONOMTE INSTA-FLOW MICRO M-30	NOTE 1
WH4-2	RESTROOM	8310 WATTS	277	1	30.0	NA	1 GPM	57	---	CHRONOMTE INSTA-FLOW MICRO M-30	NOTE 1

### PLUMBING NOTES:

1. SUPPLY SET POINT TEMPERATURE SHALL BE 110°F WHICH SHALL BE PRESET AT FACTORY.

### REVISIONS SUMMARY:


- ADDED DALLAS GREEN NOTES

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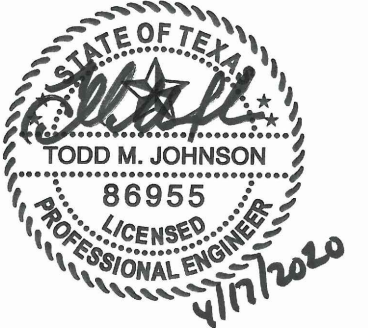
PMI JOB NO. 20039.001  
PROJECT MGR. TODD JOHNSON

THIS DRAWING SHALL NOT BE REPRODUCED OR ANY PROJECT OTHER THAN THE PROJECT NOTED IN THE TITLE BLOCK, WITHOUT THE WRITTEN CONSENT OF PURDY-MCGUIRE, INC. DALLAS, TX



idGROUP
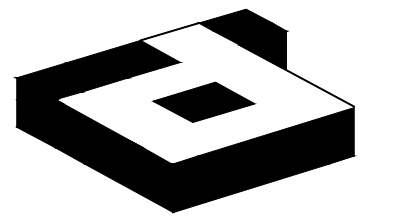
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PROJECT NO.: 580-004  
DRAWN BY: PMI  
CHECKED BY: PMI  
TENANT R.S.F.: 9.452

BILLINGSLEY  
COMPANY

3401 OLYMPUS  
ARTISAN DESIGN GROUP

3401 OLYMPUS BLVD.  
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DALLAS, TX 75019

NO.	ISSUED FOR	DATE
1	REVISION 1	04/17/2020

LANDLORD/CLIENT REVIEW ISSUE DATE: 03/30/20  
BID ISSUE DATE: 03/30/20  
CONSTRUCTION ISSUE DATE: 03/30/20

DRAWING TITLE:  
PLUMBING  
NOTES & SYMBOLS

DRAWING NUMBER:

P0.01

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DIVISION 22 - PLUMBING

SECTION 220500 - COMMON WORK RESULTS

PART 1 - GENERAL

1.1 GENERAL NOTES

- A. DRAWINGS AND GENERAL PROVISIONS OF THE CONTRACT, INCLUDING GENERAL AND SUPPLEMENTARY CONDITIONS AND ALL OTHER SPECIFICATION SECTIONS, APPLY TO THIS AND THE OTHER SECTIONS OF DIVISION 22.
B. THE CONTRACTOR FOR THIS DIVISION OF WORK IS REQUIRED TO OBTAIN A COMPLETE SET OF BID DOCUMENTS (DRAWINGS AND SPECIFICATIONS) AND FULLY REVIEW THEM...
C. THE DRAWINGS AND SPECIFICATIONS ARE INTENDED TO SUPPLEMENT EACH OTHER...
D. THE CONTRACTOR IS RESPONSIBLE FOR SCHEDULING THE COMPLETION AND INSPECTION OF THIS WORK TO COMPLY WITH THE OWNER'S SCHEDULE AND PROJECT COMPLETION DATE.

1.2 SCOPE OF WORK

- A. THE DESCRIPTION OF GENERAL CONDITION WORK IN THIS DIVISION SHALL ALSO APPLY TO DIVISIONS 21 AND 23.
B. THIS CONTRACTOR SHALL PROVIDE ALL LABOR, MATERIALS, EQUIPMENT, TOOLS, TRANSPORTATION, INCIDENTALS AND DETAILS NECESSARY TO PROVIDE A COMPLETE FIRE PROTECTION, PLUMBING AND HVAC SYSTEM AS SHOWN ON THE DRAWINGS...
C. ALL WORK NOT SPECIFICALLY NOTED AS BEING BY THE OWNER (BUILDING OWNER, LANDLORD OR TENANT), SHALL BE PROVIDED BY THIS CONTRACTOR.
D. THIS WORK, MATERIALS AND EQUIPMENT INCLUDES, BUT IS NOT LIMITED TO THE FOLLOWING ITEMS:
a. FIRE PROTECTION MODIFICATIONS AND ADDITIONS INCLUDING, BUT LIMITED TO PIPING, SPRINKLER HEADS AND CONTROL VALVES.
b. PLUMBING WORK INCLUDING, BUT NOT LIMITED TO WASTE AND VENT PIPING, DOMESTIC WATER SERVICE AND DISTRIBUTION, PLUMBING FIXTURES, WATER HEATERS AND ROUGH-IN CONNECTION TO EQUIPMENT FURNISHED BY THE OWNER...
c. HEATING, VENTILATING AND AIR CONDITIONING SYSTEMS INCLUDING, BUT NOT LIMITED TO HEATING AND COOLING UNITS, VENTILATING SYSTEMS, COMPLETE DUCT SYSTEMS, GRILLES REGISTERS AND DIFFUSERS, INSULATION, ACCESSORIES AND TEMPERATURE CONTROL SYSTEMS.

1.3 CODES

- A. ALL WORK SHALL CONFORM TO THE OWNER'S CRITERIA, STATE, COUNTY, CITY AND LOCAL CODES AND ORDINANCES, SAFETY AND HEALTH CODES, NFPA CODES, ENERGY CODES AND ALL OTHER APPLICABLE CODES AND REQUIREMENTS...
B. WHERE THE DRAWINGS AND SPECIFICATIONS CALL FOR ITEMS WHICH EXCEED CODE OR THE OWNER'S CRITERIA, THE CONTRACTOR IS RESPONSIBLE FOR FURNISHING AND INSTALLING THE SYSTEM WITH THE MORE STRINGENT REQUIREMENTS.

1.4 LICENSES, PERMITS, INSPECTIONS AND FEES

- A. THIS CONTRACTOR SHALL OBTAIN AND PAY FOR ALL LICENSES, PERMITS, INSPECTIONS AND FEES REQUIRED OR RELATED TO THIS WORK...
B. FURNISH TO THE OWNER ALL CERTIFICATES OF INSPECTION AND FINAL INSPECTION APPROVAL AT THE COMPLETION OF THE PROJECT.

1.5 GUARANTEE

- A. ALL MATERIALS, EQUIPMENT AND WORKMANSHIP SHALL BE GUARANTEED FOR A PERIOD OF 1 YEAR FROM THE DATE OF ACCEPTANCE...
B. WHERE SPECIFIC EQUIPMENT IS NOTED TO HAVE EXTENDED WARRANTIES, THE CONTRACTOR SHALL BE RESPONSIBLE FOR THE PROPER REGISTRATION SO THE OWNER CAN MAKE ALL APPROPRIATE CLAIMS.

1.6 RECORD DRAWINGS

- A. THIS CONTRACTOR SHALL MAINTAIN ONE SET OF DRAWINGS ON THE JOBSITE, UPDATED WEEKLY, TO RECORD ALL DEVIATIONS FROM THE CONTRACT DOCUMENTS SUCH AS:
a. LOCATIONS OF CONCEALED PIPING AND DUCTS
b. REVISIONS, ADDENDUMS AND CHANGE ORDERS
c. SIGNIFICANT DEVIATIONS MADE NECESSARY BY FIELD CONDITIONS, APPROVED EQUIPMENT SUBSTITUTIONS, AND CONTRACTOR'S COORDINATION WITH OTHER TRADES.
B. DELIVER RECORD DRAWINGS TO THE OWNER AT PROJECT COMPLETION.

1.7 DEMOLITION

- A. THIS CONTRACTOR SHALL BE RESPONSIBLE FOR THE COORDINATION OF THE DEMOLITION OF EXISTING WORK AND THE DEMOLITION PROVIDED BY THE GENERAL CONTRACTOR...
B. THIS CONTRACTOR SHALL INCLUDE AND BE RESPONSIBLE FOR THE REMOVAL OF ALL FIRE PROTECTION, PLUMBING AND HVAC SYSTEMS NOTED ON THE DRAWINGS OR REQUIRED TO ACCOMPLISH THE STATED WORK.

PART 2 - PRODUCTS

- 2.1 MATERIALS
A. MATERIALS UTILIZED IN THE CONSTRUCTION OF THIS PROJECT SHALL BE NEW AND CARRY UL LABELS WHERE APPLICABLE...
B. ANY USED EQUIPMENT OR MATERIALS USED SHALL STILL CARRY THE SPECIFIED 1 YEAR GUARANTEE...
2.2 MANUFACTURERS
A. WHERE TRADE NAMES OR MANUFACTURERS ARE USED ON THE DRAWINGS OR IN THE SPECIFICATIONS...
2.3 SLEEVES
A. PROVIDE SLEEVES TO PROTECT EQUIPMENT OR FACILITIES IN THE INSTALLATION...
2.4 FLAME SPREAD PROPERTIES OF MATERIALS
A. MATERIALS USED ON THIS PROJECT SHALL EACH HAVE A FLAME SPREAD RATING OF 25 OR LESS...
2.5 FIRE STOPPING
A. PROVIDE FIRE STOPPING IN SEALING OF PENETRATIONS IN FIRE-RATED CONSTRUCTION...
B. MIXES SHALL CONFORM TO THE MANUFACTURER'S DIRECTIONS.
C. PROVIDE CHROME-PLATED, ONE-PIECE, ESCUTCHEONS ON PIPES AND HANGER RODS PENETRATING WALLS, FLOORS AND CEILINGS IN FINISHED AREAS OF THE BUILDING...
D. DIELECTRIC CONNECTIONS
A. CONNECTIONS BETWEEN FERROUS AND NON-FERROUS PIPING SYSTEMS...
E. EQUIPMENT FOUNDATIONS AND SUPPORTS
A. PROVIDE FOUNDATIONS AND SUPPORTS FOR MECHANICAL EQUIPMENT AS REQUIRED...

PART 3 - EXECUTION

3.1 SPACE AND EQUIPMENT ARRANGEMENT

- A. EACH CONTRACTOR SHALL BE RESPONSIBLE TO SEE THAT THEIR PURCHASED EQUIPMENT WILL FIT THE SPACES AVAILABLE...
B. ALL WORK SHALL BE INSTALLED SO AS TO BE READILY ACCESSIBLE FOR OPERATING, SERVICING, MAINTAINING, AND REPAIRING...
C. BEFORE STARTING WORK THIS CONTRACTOR SHALL EXAMINE THE ARCHITECTURAL, STRUCTURAL, POWER, LIGHTING AND FIRE ALARM PLANS, SHOP DRAWINGS AND SPECIFICATIONS TO SEQUENCE, COORDINATE AND INTEGRATE THE VARIOUS ELEMENTS OF THE MECHANICAL SYSTEMS TO AVOID INTERFERENCES AND CONFLICTS.

3.2 MANUFACTURER'S DIRECTIONS

- A. THE MANUFACTURER'S PUBLISHED DIRECTIONS SHALL BE FOLLOWED IN THE DELIVERY, STORAGE, PROTECTION, INSTALLATION, PIPING AND WIRING OF ALL EQUIPMENT AND MATERIAL...
B. CONTRACT DOCUMENTS DO NOT DETAIL ALL JOB REQUIREMENTS...
C. CONSTRUCTION REQUIREMENTS

- A. THE DRAWINGS AND SPECIFICATIONS SHOW PIPE AND DUCT SIZES, GENERAL ROUTING AND LOCATION...
B. CONTRACT DOCUMENTS DO NOT DETAIL ALL JOB REQUIREMENTS...
C. THE EXACT LOCATION OF EACH ITEM SHALL BE DETERMINED BY REFERENCE TO THE PROJECT CONTRACT DRAWINGS...
D. FABRICATION OF PIPE
A. PIPING SHALL FOLLOW AS CLOSELY AS POSSIBLE THE ROUTES SHOWN ON THE DRAWINGS...
B. SHOULD ANY UNFORESEEN CONDITIONS ARISE, PIPING SHALL BE CHANGED OR REROUTED AS REQUIRED...
C. PIPING SHALL BE CLEANED WHEN IT IS INSTALLED...
D. EQUIPMENT FOUNDATIONS, HANGERS AND SUPPORTS
A. FOR FLOOR MOUNTED MECHANICAL EQUIPMENT...
B. SUSPENDED EQUIPMENT SHALL HAVE SUPPORTS CONSISTING OF MANUFACTURED METAL FRAMING...
E. INSTRUCTIONS OF OWNER'S PERSONNEL
A. PROVIDE THE SERVICES OF COMPETENT ENGINEERS OR TECHNICIANS...
B. THE CONTRACTOR SHALL BE FULLY RESPONSIBLE FOR PROPER MAINTENANCE OF EQUIPMENT AND SYSTEMS...
C. PROVIDE OPERATION & MAINTENANCE MANUALS (3 COPIES)...
F. ELECTRIC WIRING OF MOTORS AND EQUIPMENT
A. LOW VOLTAGE HVAC CONTROL WIRING WILL BE INSTALLED BY THE HVAC CONTRACTOR...
B. THE ELECTRICAL DESIGN AND DRAWINGS ARE BASED ON THE EQUIPMENT SCHEDULED...
G. QUIET OPERATION
A. THIS WORK SHALL BE INSTALLED IN SUCH A MANNER THAT UNDER ALL CONDITIONS OF LOAD IT SHALL OPERATE WITHOUT SOUND OR VIBRATION...
H. CUTTING AND PATCHING
A. PROVIDE ALL CUTTING, CHASING AND CHANNELING REQUIRED...
B. ALL PATCHING SHALL BE BY GENERAL CONTRACTOR...
I. TESTS
A. THE CONTRACTOR INSTALLING THE PLUMBING SYSTEMS SHALL FOLLOW ALL TESTS AS REQUIRED...
B. DOMESTIC WATER PIPING SYSTEM: UPON COMPLETION OF A SECTION OF THE ENTIRE WATER SUPPLY SYSTEM...
C. SANITARY SYSTEMS: ALL SANITARY SEWER SYSTEMS SHALL BE TESTED EITHER IN SECTIONS OR IN THEIR ENTIRETY...
D. SIZES 2-1/2 INCH AND LARGER: BUTTERFLY VALVE: NIBCO L2000 LUG STYLE...
E. SIZES 2-1/2 INCH AND LARGER: CHECK VALVE: NIBCO F-918-B CAST IRON, FLANGED...
END OF SECTION.

SECTION 220523 - GENERAL DUTY VALVES

PART 1 - GENERAL

1.1 SCOPE OF WORK

- A. REFER TO SECTION 220500.

PART 2 - PRODUCTS

- A. DOMESTIC, CHILLED, HOT, AND CONDENSER WATER SYSTEMS: PROVIDE VALVES, WHERE SHOWN ON THE DRAWINGS AND ELSEWHERE AS SPECIFIED OR REQUIRED...
B. SIZES 2 INCH AND SMALLER: CHECK VALVE: NIBCO S-433 CLASS 150, BRONZE.
C. SIZES 2-1/2 INCH AND LARGER: BUTTERFLY VALVE: NIBCO L2000 LUG STYLE, CAST IRON, 200 PSIG WITH STAINLESS STEEL TRIM AND EPDM SEAT.
D. SIZES 2-1/2 INCH AND LARGER: CHECK VALVE: NIBCO F-918-B CAST IRON, FLANGED, 200 PSIG WITH BRONZE TRIM.

PART 3 - EXECUTION

3.1 INSTALLATION

- A. VALVES SHALL BE INSTALLED IN ACCORDANCE WITH THE MANUFACTURERS' RECOMMENDATIONS...
END OF SECTION.

SECTION 220529 - HANGERS AND SUPPORTS

PART 1 - GENERAL

1.1 SCOPE OF WORK

- A. REFER TO SECTION 220500.

PART 2 - PRODUCTS

- 2.1 GENERAL
A. PIPE HANGERS AND SUPPORTS SHALL CONFORM TO THE RECOMMENDATIONS OF ASHRAE, ASPE, ANSI AND MSS.
B. PROVIDE FACTORY-FABRICATED PIPE HANGERS AND SUPPORTS IN WHICH MATERIALS, DESIGN AND MANUFACTURE COMPLY WITH ANS/MSS SP-58...
C. USE ONLY ONE TYPE OF HANGER AND SUPPORT BY ONE MANUFACTURER...
D. PROVIDE COPPER-PLATED HANGERS AND SUPPORTS FOR COPPER PIPING SYSTEMS...
E. PROVIDE PROTECTIVE COATINGS ON HANGERS AND SUPPORTS WHEN LOCATED IN OUTDOOR AND/OR CORROSIVE ENVIRONMENTS...
2.2 HORIZONTAL PIPING HANGERS AND SUPPORTS
A. SELECT SIZE OF HANGERS AND SUPPORTS TO EXACTLY FIT PIPE SIZE FOR BARE PIPING...
2.3 HANGER ROD ATTACHMENTS
A. SELECT SIZE OF HANGER ROD ATTACHMENTS TO SUIT HANGER RODS.
2.4 BUILDING ATTACHMENTS
A. SELECT SIZE AND TYPE OF BUILDING ATTACHMENTS TO SUIT HANGER RODS AND STRUCTURE.
2.5 PIPE INSULATION HANGER SHIELD INSERTS AND SHIELDS
A. THERMAL HANGER INSERTS SHALL BE DESIGNED TO PREVENT INSULATION FROM BEING CRUSHED...
B. SHIELDS SHALL BE FIELD OR FACTORY FABRICATED OF GALVANIZED SHEET METAL.

PART 3 - EXECUTION

3.1 PREPARATION

- A. PROCEED WITH INSTALLATION OF HANGERS, SUPPORTS AND ANCHORS ONLY AFTER REQUIRED BUILDING STRUCTURAL WORK HAS BEEN COMPLETED...
3.2 INSTALLATION OF BUILDING ATTACHMENTS
A. INSTALL BUILDING ATTACHMENTS AT REQUIRED LOCATIONS...
3.3 INSTALLATION OF HANGERS AND SUPPORTS
A. INSTALL HANGERS, SUPPORTS, CLAMPS AND ATTACHMENTS TO SUPPORT PIPING PROPERLY...
B. INSTALL HANGER AND SUPPORTS COMPLETE WITH NECESSARY BOLTS, RODS, NUT WASHERS AND OTHER ACCESSORIES...
C. SUPPORT FIRE PROTECTION WATER PIPING INDEPENDENTLY OF OTHER PIPING.
D. PROVISIONS FOR MOVEMENT
A. INSTALL HANGERS AND SUPPORTS TO ALLOW MOVEMENT OF PIPING SYSTEMS...
B. HANGERS FOR OTHER INSULATED PIPING MAY BE PLACED DIRECTLY AGAINST THE PIPING...
C. HANGERS SHALL BE SPACED SO AS TO SUPPORT PIPING PROPERLY...
D. HANGERS FOR INSULATED COLD PIPING SHALL BE PLACED AROUND THE OUTSIDE OF THE INSULATION AND VAPOR BARRIER...
E. PROVIDE A 180 DEGREE THERMAL INSERT ON THE BOTTOM OF THE PIPE...
F. HANGERS FOR OTHER INSULATED PIPING MAY BE PLACED DIRECTLY AGAINST THE PIPING...
G. HANGER SPACING AND ROD SIZES
A. HANGERS SHALL BE SPACED SO AS TO SUPPORT PIPING PROPERLY...
C. AT NO TIME SHALL ANY SECTION OF PIPE HAVE LESS THAN TWO SUPPORTS.

3.2 CONSTRUCTION REQUIREMENTS

- A. THE DRAWINGS AND SPECIFICATIONS SHOW PIPE AND DUCT SIZES, GENERAL ROUTING AND LOCATION...
B. CONTRACT DOCUMENTS DO NOT DETAIL ALL JOB REQUIREMENTS...
C. THE EXACT LOCATION OF EACH ITEM SHALL BE DETERMINED BY REFERENCE TO THE PROJECT CONTRACT DRAWINGS...
D. FABRICATION OF PIPE
A. PIPING SHALL FOLLOW AS CLOSELY AS POSSIBLE THE ROUTES SHOWN ON THE DRAWINGS...
B. SHOULD ANY UNFORESEEN CONDITIONS ARISE, PIPING SHALL BE CHANGED OR REROUTED AS REQUIRED...
C. PIPING SHALL BE CLEANED WHEN IT IS INSTALLED...
D. EQUIPMENT FOUNDATIONS, HANGERS AND SUPPORTS
A. FOR FLOOR MOUNTED MECHANICAL EQUIPMENT...
B. SUSPENDED EQUIPMENT SHALL HAVE SUPPORTS CONSISTING OF MANUFACTURED METAL FRAMING...
E. INSTRUCTIONS OF OWNER'S PERSONNEL
A. PROVIDE THE SERVICES OF COMPETENT ENGINEERS OR TECHNICIANS...
B. THE CONTRACTOR SHALL BE FULLY RESPONSIBLE FOR PROPER MAINTENANCE OF EQUIPMENT AND SYSTEMS...
C. PROVIDE OPERATION & MAINTENANCE MANUALS (3 COPIES)...
F. ELECTRIC WIRING OF MOTORS AND EQUIPMENT
A. LOW VOLTAGE HVAC CONTROL WIRING WILL BE INSTALLED BY THE HVAC CONTRACTOR...
B. THE ELECTRICAL DESIGN AND DRAWINGS ARE BASED ON THE EQUIPMENT SCHEDULED...
G. QUIET OPERATION
A. THIS WORK SHALL BE INSTALLED IN SUCH A MANNER THAT UNDER ALL CONDITIONS OF LOAD IT SHALL OPERATE WITHOUT SOUND OR VIBRATION...
H. CUTTING AND PATCHING
A. PROVIDE ALL CUTTING, CHASING AND CHANNELING REQUIRED...
B. ALL PATCHING SHALL BE BY GENERAL CONTRACTOR...
I. TESTS
A. THE CONTRACTOR INSTALLING THE PLUMBING SYSTEMS SHALL FOLLOW ALL TESTS AS REQUIRED...
B. DOMESTIC WATER PIPING SYSTEM: UPON COMPLETION OF A SECTION OF THE ENTIRE WATER SUPPLY SYSTEM...
C. SANITARY SYSTEMS: ALL SANITARY SEWER SYSTEMS SHALL BE TESTED EITHER IN SECTIONS OR IN THEIR ENTIRETY...
D. SIZES 2-1/2 INCH AND LARGER: BUTTERFLY VALVE: NIBCO L2000 LUG STYLE, CAST IRON, 200 PSIG WITH STAINLESS STEEL TRIM AND EPDM SEAT.
E. SIZES 2-1/2 INCH AND LARGER: CHECK VALVE: NIBCO F-918-B CAST IRON, FLANGED, 200 PSIG WITH BRONZE TRIM.

3.3 CONSTRUCTION REQUIREMENTS

- A. THE DRAWINGS AND SPECIFICATIONS SHOW PIPE AND DUCT SIZES, GENERAL ROUTING AND LOCATION...
B. CONTRACT DOCUMENTS DO NOT DETAIL ALL JOB REQUIREMENTS...
C. THE EXACT LOCATION OF EACH ITEM SHALL BE DETERMINED BY REFERENCE TO THE PROJECT CONTRACT DRAWINGS...
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A. PROVIDE ALL CUTTING, CHASING AND CHANNELING REQUIRED...
B. ALL PATCHING SHALL BE BY GENERAL CONTRACTOR...
I. TESTS
A. THE CONTRACTOR INSTALLING THE PLUMBING SYSTEMS SHALL FOLLOW ALL TESTS AS REQUIRED...
B. DOMESTIC WATER PIPING SYSTEM: UPON COMPLETION OF A SECTION OF THE ENTIRE WATER SUPPLY SYSTEM...
C. SANITARY SYSTEMS: ALL SANITARY SEWER SYSTEMS SHALL BE TESTED EITHER IN SECTIONS OR IN THEIR ENTIRETY...
D. SIZES 2-1/2 INCH AND LARGER: BUTTERFLY VALVE: NIBCO L2000 LUG STYLE, CAST IRON, 200 PSIG WITH STAINLESS STEEL TRIM AND EPDM SEAT.
E. SIZES 2-1/2 INCH AND LARGER: CHECK VALVE: NIBCO F-918-B CAST IRON, FLANGED, 200 PSIG WITH BRONZE TRIM.

3.4 PROVISIONS FOR MOVEMENT

- A. INSTALL HANGERS AND SUPPORTS TO ALLOW MOVEMENT OF PIPING SYSTEMS...
B. HANGERS FOR OTHER INSULATED PIPING MAY BE PLACED DIRECTLY AGAINST THE PIPING...
C. HANGERS SHALL BE SPACED SO AS TO SUPPORT PIPING PROPERLY...
D. HANGERS FOR INSULATED COLD PIPING SHALL BE PLACED AROUND THE OUTSIDE OF THE INSULATION AND VAPOR BARRIER...
E. PROVIDE A 180 DEGREE THERMAL INSERT ON THE BOTTOM OF THE PIPE...
F. HANGERS FOR OTHER INSULATED PIPING MAY BE PLACED DIRECTLY AGAINST THE PIPING...
G. HANGER SPACING AND ROD SIZES
A. HANGERS SHALL BE SPACED SO AS TO SUPPORT PIPING PROPERLY...
C. AT NO TIME SHALL ANY SECTION OF PIPE HAVE LESS THAN TWO SUPPORTS.

3.5 INSULATED PIPING REQUIREMENTS

- A. HANGERS FOR INSULATED COLD PIPING SHALL BE PLACED AROUND THE OUTSIDE OF THE INSULATION AND VAPOR BARRIER...
B. HANGERS FOR OTHER INSULATED PIPING MAY BE PLACED DIRECTLY AGAINST THE PIPING...
C. HANGERS SHALL BE SPACED SO AS TO SUPPORT PIPING PROPERLY...
D. HANGERS FOR INSULATED COLD PIPING SHALL BE PLACED AROUND THE OUTSIDE OF THE INSULATION AND VAPOR BARRIER...
E. PROVIDE A 180 DEGREE THERMAL INSERT ON THE BOTTOM OF THE PIPE...
F. HANGERS FOR OTHER INSULATED PIPING MAY BE PLACED DIRECTLY AGAINST THE PIPING...
G. HANGER SPACING AND ROD SIZES
A. HANGERS SHALL BE SPACED SO AS TO SUPPORT PIPING PROPERLY...
C. AT NO TIME SHALL ANY SECTION OF PIPE HAVE LESS THAN TWO SUPPORTS.

3.6 HANGER SPACING AND ROD SIZES

- A. HANGERS SHALL BE SPACED SO AS TO SUPPORT PIPING PROPERLY...
C. AT NO TIME SHALL ANY SECTION OF PIPE HAVE LESS THAN TWO SUPPORTS.

END OF SECTION.

SECTION 220553 - IDENTIFICATION

PART 1 - GENERAL

1.1 SCOPE OF WORK

- A. REFER TO SECTION 220500.

B. LABEL ALL NEW EQUIPMENT AND PIPING SYSTEMS.

PART 2 - PRODUCTS

2.1 PIPE LABELS

- A. PRETENSION PIPE LABELS OF SEMI-RIGID PLASTIC FORMED TO COVER THE FULL CIRCUMFERENCE OF PIPE...
B. IDENTIFY THE SERVICE AND DIRECTION OF FLOW...
2.2 VALVE TAGS
A. MULTILAYER, MULTICOLOR PLASTIC LABELS WITH MECHANICAL ENGRAVING...
2.3 EQUIPMENT LABELS
A. MULTILAYER, MULTICOLOR PLASTIC LABELS WITH MECHANICAL ENGRAVING...
C. AT NO TIME SHALL ANY SECTION OF PIPE HAVE LESS THAN TWO SUPPORTS.

PIPE SIZE MAXIMUM HANGER SPACING MINIMUM ROD SIZE

Table with 3 columns: PIPE SIZE, MAXIMUM HANGER SPACING, MINIMUM ROD SIZE. Rows include 1/2 INCH, 3/4 INCH, 1 INCH, 1-1/4 INCH, 1-1/2 INCH, 2 INCH AND LARGER.

C. AT NO TIME SHALL ANY SECTION OF PIPE HAVE LESS THAN TWO SUPPORTS.

END OF SECTION.

SECTION 221116 - DOMESTIC WATER PIPING

PART 1 - GENERAL

1.1 SCOPE OF WORK

- A. REFER TO SECTION 220500.

PART 2 - PRODUCTS

2.1 PIPE LABELS

- A. PRETENSION PIPE LABELS OF SEMI-RIGID PLASTIC FORMED TO COVER THE FULL CIRCUMFERENCE OF PIPE...
B. IDENTIFY THE SERVICE AND DIRECTION OF FLOW...
2.2 VALVE TAGS
A. MULTILAYER, MULTICOLOR PLASTIC LABELS WITH MECHANICAL ENGRAVING...
2.3 EQUIPMENT LABELS
A. MULTILAYER, MULTICOLOR PLASTIC LABELS WITH MECHANICAL ENGRAVING...
C. AT NO TIME SHALL ANY SECTION OF PIPE HAVE LESS THAN TWO SUPPORTS.

PART 3 - EXECUTION

3.1 INSTALLATION

- A. CLEAN AND DISINFECT ALL NEW PIPING WITH WATER/CHLORINE SOLUTION...
B. INSTALL WATER PIPING LEVEL AND PLUMB...
C. PIPING BELOW SLAB SHALL BE INSTALLED WITHOUT JOINTS.

END OF SECTION.

SECTION 221316 - SANITARY WASTE AND VENT PIPING

PART 1 - GENERAL

1.1 SCOPE OF WORK

- A. REFER TO SECTION 220500.

PART 2 - PRODUCTS

2.1 COPPER PIPING

- A. PROVIDE SOFT COPPER TUBE, TYPE "K", WITH SOLDER-JOINT FITTINGS...
B. PROVIDE HARD COPPER TUBE, TYPE "L", WITH SOLDER JOINT FITTINGS...
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PART 3 - EXECUTION

3.1 INSTALLATION

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PART 3 - EXECUTION


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SECTION 221316 - SANITARY WASTE AND VENT PIPING


PART 1 - GENERAL



**1 LEVEL 04 PLUMBING PLAN**  
SCALE: 1/8"=1'-0"


**NOTES BY SYMBOL (X):**

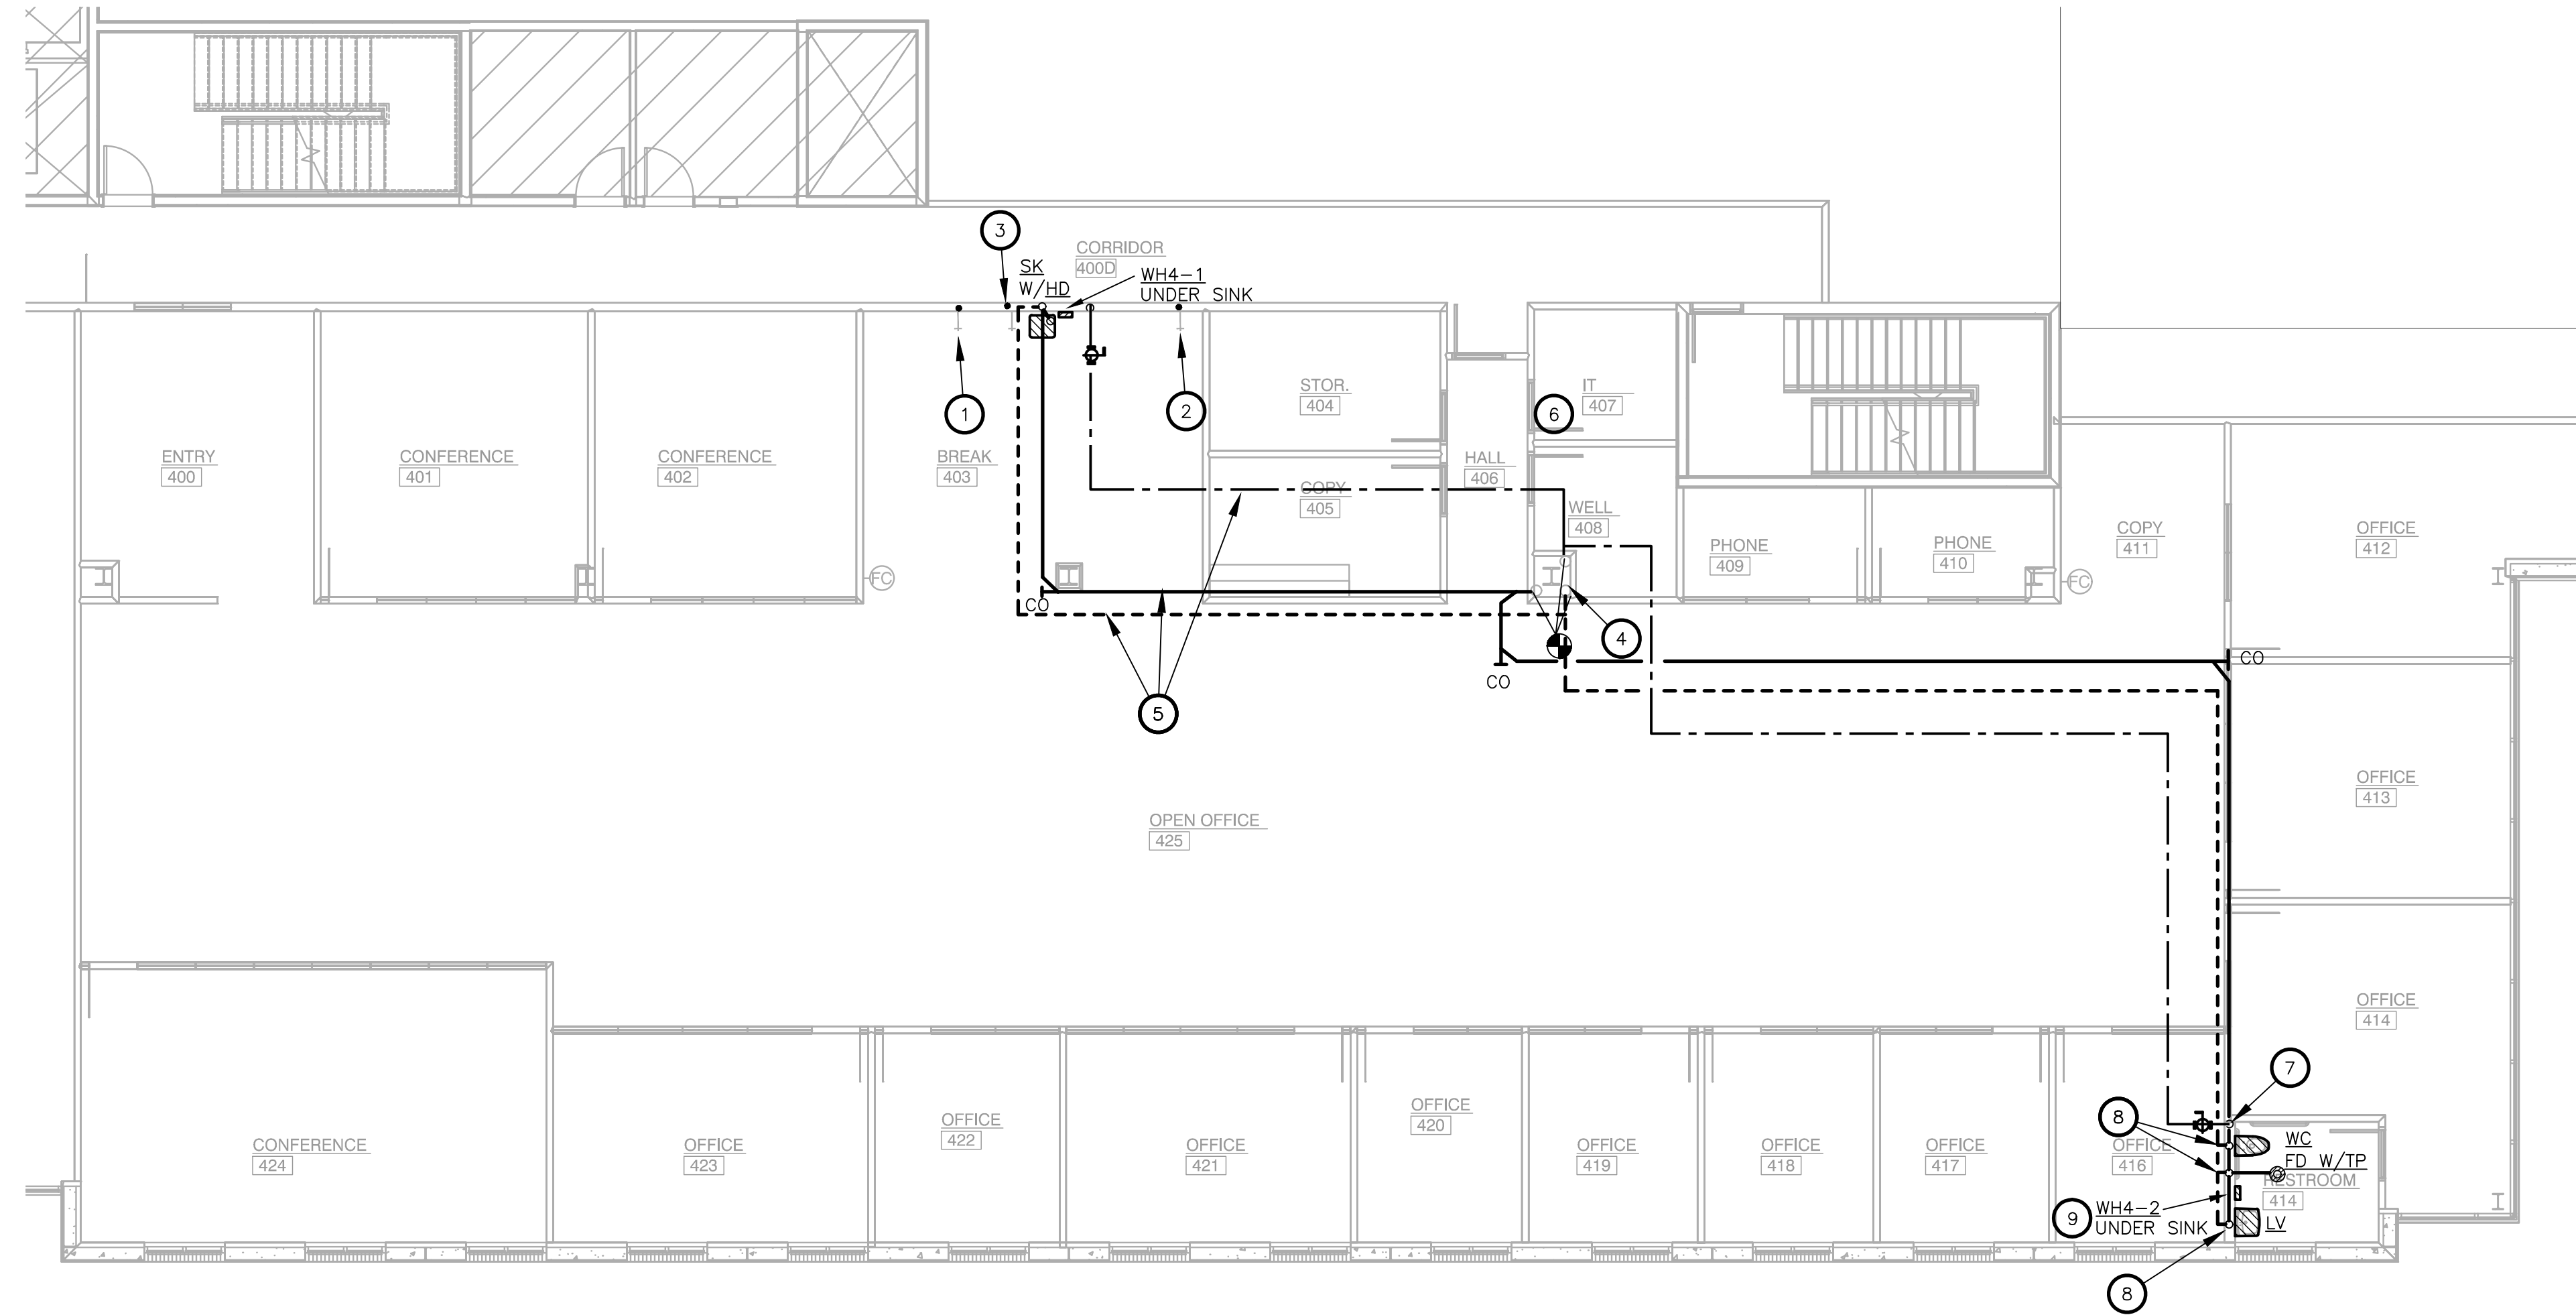1. PROVIDE COLD WATER WITH VALVE TO ASSE 1022 COMPLIANT BACKFLOW PREVENTER AND EXTEND 1/4" COPPER TUBING UP THRU COUNTER TOP TO COFFEE MAKER. VERIFY WITH ARCHITECT EXACT LOCATION OF COFFEE MAKER ON COUNTER.
2. PROVIDE COLD WATER WITH VALVE AND EXTEND 1/4" COPPER TUBING TO REFRIGERATOR/ICE MAKER.
3. PROVIDE COLD WATER WITH VALVE TO ASSE 1022 COMPLIANT BACKFLOW PREVENTER AND EXTEND 1/4" COPPER TUBING TO ICE MAKER. EXTEND CONDENSATE DRAIN LINE FROM ICE MAKER TO HUB DRAIN. PROVIDE PUMP AS REQUIRED.
4. LOCATION OF BUILDING WET STACK STUB-OUTS. VERIFY EXACT LOCATIONS, SIZE AND FIELD CONDITIONS AT WET STACK LOCATION FOR PROPER CONNECTION PRIOR TO ANY INSTALLATION.
5. RUN NEW PIPING TO INDICATED EXISTING LOCATION. VERIFY EXACT LOCATION AND ROUTING AT JOB SITE. PROVIDE SHUT-OFF VALVE IN THE NEW DOMESTIC WATER LINE FOR FUTURE CONNECTION.
6. DO NOT RUN ANY NEW WATER LINES OVER THIS ROOM.
7. 1-1/2" DOMESTIC COLD WATER DOWN. PROVIDE ACCESSIBLE SHUT OFF BALL VALVE IN CEILING.
8. WASTE DOWN AND VENT UP IN WALL.
9. INSTALL WATER HEATER PER ARCHITECT'S DIRECTION. DISCONNECT AND ANY EXPOSED CONDUIT TO BE INSTALLED IN CLEAN AND NEAT MANNER WITH ARCHITECT'S APPROVAL.

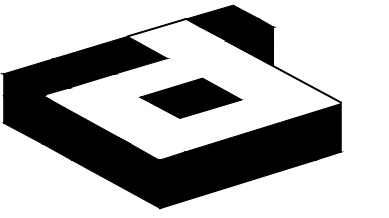

**idGROUP**

2641 IRVING BLVD.  
DALLAS, TEXAS 75207  
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PROJECT NO.: 580-004  
DRAWN BY: PMI  
CHECKED BY: PMI  
TENANT R.S.F.: 9.452

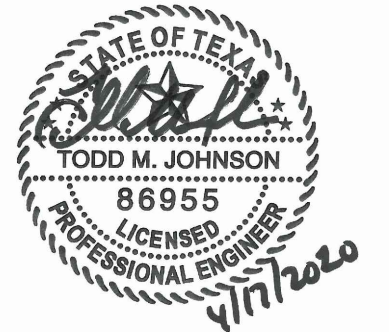**BILLINGSLEY**  
COMPANY

**3401 OLYMPUS**  
**ARTISAN DESIGN GROUP**

3401 OLYMPUS BLVD.  
SUITE #450  
DALLAS, TX 75019

NO.	ISSUED FOR:	DATE:
1	REVISION 1	04/17/2020

LANDLORD/CLIENT REVIEW ISSUE DATE: 03/30/20  
BID ISSUE DATE: 03/30/20  
CONSTRUCTION ISSUE DATE: 03/30/20

Purdy - McGuire  
Mechanical - Electrical Engineers  
17300 North Dallas Parkway  
Suite 3000  
Dallas, Texas 75248-1147  
Firm Registration # F-1511  
Tel: 972/239-5357  
Fax: 972/239-5231  
www.purdy-mcguire.com

PMI JOB NO. 20039.001  
PROJECT MGR. TODD JOHNSON

THIS DRAWING SHALL NOT BE REPRODUCED FOR ANY PROJECT OTHER THAN THE PROJECT NOTED IN THE TITLE BLOCK, WITHOUT THE WRITTEN CONSENT OF PURDY-McGUIRE, INC. DALLAS, TX

DRAWING TITLE:  
**LEVEL 04 PLUMBING PLAN - EAST**

DRAWING NUMBER:

**P2.04E**

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